Commission:

Mayor

Francis X. Suarez

D1 Commissioner

Wifredo (Willy) Gort D2 Commissioner

Ken Russell

D3 Commissioner

Joe Carollo

D4 Commissioner

Manuel E. Reyes

D5 Commissioner Keon Hardemon

City Manager

Emilio T. Gonzalez

INDEX OF SHEETS

SHEET NO.	DESCRIPTION
1	COVER SHEET
2	GENERAL NOTES & LEGEND
3	SUMMARY OF QUANTITIES
SU-1 - SU-2	EXISTING CONDITIONS
6-7	GEOMETRY & SIDEWALK PLAN
8-10	STORMWATER POLLUTION PREVENTION PLAN NOTES
11	TRAFFIC CONTROL NOTES
12	RIGHT-OF-WAY AND PROPERTY OWNERSHIP EXHIBIT
13	TYPICAL SECTIONS AND DETAILS
H1.0-H2.0	HARDSCAPE PLANS
H3.0	HARDSCAPE DETAILS
L1.0-L2.0	LANDSCAPE PLANS
L3.0	LANDSCAPE DETAILS
TM1.0 - TM3.0	TREE MANAGEMENT PLANS

CITY OF MIAMI CAPITAL IMPROVEMENTS PROGRAM

STEVEN C. WILLIAMSON, DIRECTOR

NW 11 STREET NW 12 AVENUE TO NW 7TH AVENUE OVERTOWN GREENWAY PROJECT No. B-173648FINANCIAL PROJECT ID 420917-2

PHASE II NW 12 AVENUE TO NW 7 AVENUE





ROADWAY SHOP DRAWINGS TO BE SUBMITTED TO:

FRANCISCO J. ALONSO, P.E. 201 ALHAMBRA CIRCLE SUITE 900 CORAL GABLES, FL 33134

PLANS PREPARED BY:

T-Y-LININTERNATIONAL

201 ALHAMBRA CIRCLE SUITE 900 CORAL GABLES, FLORIDA 33134 PHONE: (305) 567-1888 FAX: (305) 567-1771 EB00002017

> 100% SUBMITTAL JUNE 28, 2019

NOTE: THE SCALE OF THESE PLANS MAY HAVE CHANGED DUE TO REPRODUCTION.

ENGINEER OF RECORD: FRANCISCO J. ALONSO, P.E.

P.E. NO.: ____66918

SCOPE OF WORK

- REMOVE EXISTING SIDEWALK
- CONSTRUCT NEW SIDEWALK, TYPICALLY 10' WIDE, WITH DECORATIVE TREATMENT.
 CONSTRUCT NEW CONCRETE CROSSWALKS
 INSTALL NEW LANDSCAPING AND LIGHTING

CITY OF MIAMI PROJECT MANAGER: KEITH NG

CITY OF MIAMI CONSTRUCTION MANAGER: TBD

GOVERNING STANDARDS AND SPECIFICATIONS:

- FLORIDA DEPARTMENT OF TRANSPORTATION, 2016 "FLORIDA GREENBOOK". DESIGN STANDARDS DATED 2017-18. AND STANDARD SPECIFICATIONS FOR ROAD AND BRIDGE CONSTRUCTION DATED JANUARY 2018, AS AMENDED BY CONTRACT DOCUMENTS.
- CITY OF MIAMI ENGINEERING STANDARDS FOR DESIGN AND CONSTRUCTION DATED DECEMBER 2010.



SHEET NO.

GENERAL NOTES:

- ALL ELEVATIONS REFER TO THE CITY OF MIAMI DATUM. ALL PUBLIC LAND CORNERS AND PRIMARY NETWORK CONTROL SURVEY MONUMENTS ARE TO BE PROTECTED BY THE CONTRACTOR. CORNERS AND MONUMENTS WITHIN THE WORK ZONE AND IN DANGER OF BEING DAMAGED, DESTROYED OR COVERED SHALL BE PROPERLY REFERENCED BY A REGISTERED LAND SURVEYOR IN ACCORDANCE WITHIN THE MINIMUM TECHNICAL STANDARDS OF THE FLORIDA BOARD OF PROFESSIONAL LAND SURVEYOR PRIOR TO THE BEGINNING OF WORK. UPON PROJECT COMPLETION THE CONTRACTOR SHALL RESTORE ALL SUCH CORNERS AND MONUMENTS AND SHALL FURNISH TO THE CITY A SIGNED AND SEALED COPY OF THE LAND SURVEYOR'S REFERENCE DRAWING. INCLUDE ALL COST OF REFERENCING, RESTORING AND PRESERVING CORNERS AND MONUMENTS IN THE BID PRICE FOR MOBILIZATION.
- 2. THE CONTRACTOR MUST HAND EXCAVATE AROUND AREAS WHERE EXISTING UNDERGROUND UTILITIES ARE EXPECTED OR SUSPECTED IN ORDER TO AVOID DAMAGES. THE CONTRACTOR SHALL BE SPONSIBLE FOR ALL REPAIRS AND COSTS TO CORRECT DAMAGES RESULTING FROM FAILURE TO TAKE ALL NECESSARY PRECAUTIONS INCLUDING LOCATING, MARKING AND CAREFUL EXCAVATION, AND
- 3. CONTRACTOR SHALL OBTAIN ALL NECESSARY PERMITS PRIOR TO COMMENCING CONSTRUCTION.
- 4. IT IS THE OBLIGATION OF THE BIDDER OR THE CONTRACTOR TO MAKE HIS OWN INVESTIGATION AND SATISFY HIMSELF FULLY OF SUBSURFACE CONDITIONS PRIOR TO SUBMITTING HIS BID. FAILURE TO DO SO, WILL NOT RELIEVE HIM OF HIS OBLIGATION TO COMPLETE THE WORK FULLY AND ACCEPTABLE TO THE ENGINEER AND THE OWNER FOR THE CONSIDERATION SET FORTH IN HIS BID.
- 5 CONTRACTOR SHALL NOT SCALE DIMENSIONS FROM PRINTS FOR CONSTRUCTION PURPOSES
- CONTRACTOR SHALL CUT EXISTING DRIVEWAYS AND SIDEWALKS CAREFULLY AND NEATLY WHERE PIPING CROSSES THESE LOCATIONS. CUT EXISTING CONCRETE SIDEWALKS AT THE NEAREST JOINTS AND REPLACE CUT OUT SECTION AS DETAILED IN THE CITY STANDARDS AND FINISH TO MATCH EXISTING SURFACE LEVEL AND FINISH.
- 7. BASELINE OF CONSTRUCTION FOR ALL STREETS SHALL BE THE STREET CENTER LINE OR AS SHOWN ON THE PLANS
- 8. ALL DISTURBED GRASS AREAS SHALL BE RESTORED WITH SUITABLE SOIL AND SOLID ST AUGUSTINE SOD IF NOT SPECIFIED OTHERWISE ON THE PLANS.
- 9. IT IS THE INTENT OF THESE PLANS TO BE IN COMPLIANCE WITH APPLICABLE CODES OF AUTHORITIES HAVING JURISDICTION. ANY DISCREPANCIES BETWEEN THESE PLANS AND APPLICABLE CODES SHALL BE IMMEDIATELY BROUGHT TO THE ATTENTION OF THE ENGINEER.
- 10. WHERE NEW PAVEMENT MEETS EXISTING, CONNECTION SHALL BE MADE IN A NEAT STRAIGHT (FEATHERED) LINE AND FLUSH WITH EXISTING PAVEMENT
- 11. THE CONTRACTOR SHALL USE CITY OF MIAMI STANDARD FOR DESIGN AND CONSTRUCTION (2010) AND THE FDOT STANDARD INDEX AND SPECIFICATIONS (2017-18) UNLESS OTHERWISE SPECIFIED.
- 12. CONTRACTOR IS TO VERIFY THE EXACT LOCATION OF ALL EXISTING TREES, STRUCTURES, UTILITIES AND UTILITY MARKERS, WHICH MAY NOT BE SHOWN ON PLANS. ANY EXISTING STRUCTURES, PAVEMENT, TREES, UTILITIES, UTILITY MARKERS OR OTHER EXISTING IMPROVEMENT NOT SPECIFIED FOR REMOVAL WHICH IS TEMPORARILY DAMAGED, EXPOSED OR IN ANY WAY DISTURBED BY CONSTRUCTION PERFORMED UNDER THIS CONTRACT, SHALL BE REPAIRED, PATCHED OR REPLACED AT NO ADDITIONAL COST TO THE OWNER.
- 13. CONTRACTOR SHALL RESET OR REPLACE EXISTING METER BOXES AND PULL BOXES AS REQUIRED FOR SIDEWALK RECONSTRUCTION. INSTALLATIONS OF NEW PULL BOXES SHALL BE PERFORMED BY OULLIFIED ELECTRICAL CONTRACTOR. WHEN REPLACING AN EXISTING PULL BOX, THE CONTRACTOR SHALL ADJUST CONDUITS AND CABLES TO FIT THE NEW PULL BOX ELEVATION. COST OF ADJUSTMENTS AND NEW PULL BOXES/METER BOXES IS INCIDENTAL TO TOTAL PROJECT COST.
- 14. NO STAGING OR ANY ACTIVITIES FOR THIS PROJECT ARE ALLOWED WITHIN OR ADJACENT TO THE WAGNER CREEK CANAL, OTHER THAN WHAT IS SHOWN IN THE PLANS.

PAY ITEM NOTES 15. ALL IMPROVEMENTS ARE TO BE CONSTRUCTED AND/OR INSTALLED WITHIN THE EXISTING STATE AND/OR LOCAL RIGHT OF WAY

1. ALL DEMOLITION, WITH THE EXCEPTION OF REMOVAL OF EXISTING PAVEMENTS, SHALL BE PAID UNDER CLEARING AND GRUBBING.

UTILITY COMPANY CONTACT LIST:

STEVE MASSIE 305-222-8745 LEONARD MAXWELL-NEWBOLD COMCAST CABLE 954-447-8405 MIAMI-DADE COUNTY PUBLIC WORKS AURELIO DEL VALLE 305-592-8925 EXT.258 FIBERLIGHT LLC 954-596-2559 CHRIS PANCIONE THOMAS MILLER 305-491-4391 FDOT 6 FLORIDA POWER AND LIGHT-DADE TRACY STERN 800-868-9554 FLORIDA POWER AND LIGHT-FIBERNET DANNY HASKETT 305-552-2931 FLORIDA POWER AND LIGHT- TRANSMISSION SEYED HAIASSADOLLAH 305-228-5290 JIM VANVALKENBURGH GLOBAL CROSSING 585-255-1030 MIAMI-DADE ENTERPRISE TECHNOLOGY 305-596-8404 JUAN AGUIRRE LEVEL 3 COMMUNICATIONS JUDY HENRY 720-888-2061 INVESTIGATIONS 972-729-6016 MIAMI-DADE WATER AND SEWER 786-268-5255 TECO PEOPLE GAS SOUTH FLORIDA YVONNE GOLDMAN 954-453-0824 MIKE FITZGERALD OWEST COMMUNICATIONS 813-630-2605 321-287-9942

SYMBOL LEGEND

Tree * Palm Tree -o- Single Support Sign Manhole Drainage Curb Inlet WATER Meter Water Fire Hydrant

LINE LEGEND:

— oH —— oH — Overhead Line

Metal Fence

-×---×--- Chain link Fence

Manhole Unmarked -O- Wood Pole Wiring Pull Box

Catch Basin

Manhole Sewer Guard Post

Column (W) Valve Water ---- Guy Wire

ABBREVIATION

→ Double Support Sign Light Pole --- Concrete Light Pole ŪK̇̀ Valve Unknown Monitoring Well

Manhole Telephone

CBS Concrete Block Stucco Typ. Typical Transf. Transformer Conc. Concrete El. Elevation

Sta. Station Conc. Concrete T.B.M. Temporary Bench Mark Fnd. Found

(G) Valve Gas

Irrigation Valve

PAVING, GRADING AND DRAINAGE NOTES:

- 1. ALL WORK TO BE IN COMPLIANCE WITH THE REQUIREMENTS OF AND ACCEPTABLE TO CITY OF MIAMI PUBLIC WORKS DEPARTMENT, MIAMI-DADE COUNTY D.E.R.M AND THE COUNTY PUBLIC WORKS
- CONTRACTOR SHALL PROVIDE HIS OWN LINE AND GRADE FROM HORIZONTAL AND VERTICAL CONTROL. CONTRACTOR SHALL ALSO PROVIDE "AS BUILT" GRADES CERTIFIED BY A REGISTERED LAND SURVEYOR AS REQUIRED BY THE CITY OF MIAMI PUBLIC WORKS DEPARTMENT.
- 3. PAVEMENT RESTORATION AND DRIVEWAY CONSTRUCTION SHALL BY CONSTRUCTED IN ACCORDANCE WITH THE CITY OF MIAMI PUBLIC WORKS DEPARTMENT
- 4. CONTRACTOR TO PROVIDE PROCTOR AND FIELD DENSITY TESTS (WHERE APPLICABLE) ON TRENCH FILL MATERIALS BASE AS REQUIRED IN THE SPECIFICATIONS. IN THE EVENT OF FIELD DENSITY TEST FAILURES. THE CONTRACTOR SHALL REWORK THE BASE AND/OR SURGRADE AS REQUIRED AND PROVIDE ADDITIONAL TEST(S). AS REQUIRED. AT HIS EXPENSE
- 5. PAVEMENT RESTORATION SHALL BE IN ACCORDANCE WITH THE CITY OF MIAMI PUBLIC WORKS DEPARTMENT STANDARD (2010) DETAIL MISC 35-85-37 OR PER DETAILS SHOWN ON THESE PLANS.
- 6. BID PRICES SHALL INCLUDE ALL LABOR, EQUIPMENT, MATERIALS AND INCIDENTALS COMPLETE IN PLACE, TESTED, AND ACCEPTED BY THE ENGINEER,
- 7. THE CONTRACTOR SHALL USE SWEEPER (USING WATER) OR OTHER EQUIPMENT CAPABLE OF CONTROLLING AND REMOVING DUST. APPROVAL OF THE USE OF SUCH EQUIPMENT IS CONTINGENT UPON ITS DEMONSTRATED ABILITY TO DO WORK
- 8. THE CONTRACTOR IS RESPONSIBLE FOR KEEPING EXISTING AND NEW INLETS CLEAN OF MILLING MATERIAL, LIMEROCK, DEBRIS, ETC. THIS SHALL BE DONE DURING THE CONSTRUCTION AT NO ADDITIONAL COST TO THE OWNER. ALL EXISTING LINES AND STRUCTURES SHALL BE CLEANED PRIOR TO FINAL INSPECTION AND ACCEPTANCE
- 9. PEDESTRIAN CURB RAMPS AND DETECTABLE WARNING DOMES SHALL COMPLY WITH FDOT STANDARD 304 AND SHALL BE CAST IN PLACE YELLOW SUCH AS ARMOR-TILE TYPE
- 10. CONTRACTOR SHALL CONTACT SUNSHINE AT (800) 432-4770 AT LEAST 48 HOURS PRIOR TO PERFORMING ANY DIGGING TO VERIFY THE EXACT LOCATION OF EXISTING UTILITIES. THE CONTRACTOR SHALL COMPLY WITH MIAMI DADE COUNTY'S WHITE LINE ORDINANCE AND UTILIZE LOW IMPACT UTILITY MARKING PAINT
- 11 EXISTING TREES SHALL BE REMOVED ONLY IF REQUIRED FOR CONSTRUCTION THOSE TREES NOT INTERFERING WITH CONSTRUCTION SHALL BE PROTECTED IN PLACE. THE CONTRACTOR IS ADVISED THAT A TREE PERMIT IS REQUIRED FOR TREE REMOVAL AND RELOCATION. CONTRACTOR SHALL NOTIFY THE CITY OF MIAMI PRIOR TO REMOVING AND RELOCATING ANY TREES. REFER TO LANDSCAPE PLAN FOR MORE INFORMATION. TREE TRIMMING AND REMOVAL PERMITS ON MIAMI DADE TRANSIT AGENCY PROPERTY SHALL BE ADMINISTERED BY THE CITY'S NET OFFICE.
- 12. EXISTING GRADES WERE TAKEN FROM THE BEST AVAILABLE DATA AND MAY NOT ACCURATELY REFLECT PRESENT CONDITIONS. CONTRACTOR SHALL BE RESPONSIBLE FOR FAMILIARIZING HIMSELF WITH CURRENT SITE CONDITIONS, AND SHALL REPORT ANY DISCREPANCIES TO THE ENGINEER PRIOR TO STARTING WORK.
- 13. THE CONTRACTOR SHALL PREPARE AND SUBMIT SHOP DRAWINGS FOR ALL ITEMS LISTED IN PROJECT SPECIFICATION (WHERE APPLICABLE).
- 14. THE CONTRACTOR SHALL MAINTAIN ACCESS TO ALL ADJACENT PROPERTIES AT ALL TIMES.
- 15. ALL EXCAVATED MATERIAL REMOVED FROM THIS PROJECT SHALL BE DISPOSED OF PROPERLY BY THE CONTRACTOR AT THE CONTRACTOR'S EXPENSE.
- 16. EXCAVATED OR OTHER MATERIAL STORED ADJACENT TO OR PARTIALLY UPON A ROADWAY PAVEMENT SHALL BE ADEQUATELY MARKED FOR TRAFFIC SAFETY AT ALL TIMES.
- 17. TEMPORARY PATCH MATERIAL SHALL BE ON THE JOB SITE WHENEVER PAVEMENT IS CUT.
- 18. ALL EXISTING DRAINAGE STRUCTURES AND PIPES ARE TO REMAIN AND TO BE PROTECTED UNLESS OTHERWISE SPECIFIED AND APPROVED.
- 19. THE CONTRACTOR SHALL NOT REMOVE OR RELOCATE ANY TREES WITHOUT PRIOR APPROVAL FROM THE CITY. THE CONTRACTOR SHALL OBTAIN ALL REQUIRED PERMITS FROM THE CITY PUBLIC WORKS DEPARTMENT PRIOR TO ANY TREE REMOVAL/RELOCATION. THE CONTRACTOR SHALL PRUNE, ROOT PRUNE, AND SUPPORT ALL TREES THAT ARE ADJACENT TO TRENCH EXCAVATION. COST SHALL BE DEEMED INCIDENTAL TO THE TOTAL PROJECT COST. TREE TRIMMING AND REMOVAL PERMITS ON MIAMI DADE TRANSIT AGENCY PROPERTY SHALL BE ADMINISTERED BY THE CITY'S
- 20. CONTRACTOR SHALL IMPLEMENT AND ENFORCE ALL NPDES EROSION AND SEDIMENT CONTROL RULES AND REGULATIONS.
- 21. CONTRACTOR SHALL PLANT THE TREES OUTSIDE THE SIGHT TRIANGLE OF EACH DRIVEWAY OR AS DIRECTED BY THE CITY.
- 22. CONTRACT SHALL INCLUDE IN THE BID PRICE FOR CLEARING AND GRUBBING OF THE FOLLOWING ITEMS: STREET NAMES, CONCRETE DRIVEWAY PADS, ASPHALTIC DRIVEWAY PADS, SIDEWALK FLAGS TO BE REPLACED AND CURB RAMPS

ENVIRONMENTAL NOTES

ANY MATERIAL TO BE STOCKPILED FOR PERIODS GREATER THAN 24 HOURS SHALL BE PROTECTED BY APPROPRIATE EROSION CONTROL DEVICES.

- 2. THE CONTRACTOR SHALL REVIEW ENVIRONMENTAL REQUIREMENTS OF ANY PROPOSED STAGING AREAS WITH THE PROJECT ENGINEER (INSERT CONTACT INFORMATION HERE) AT LEAST SEVENTY-TWO (72) HOURS PRIOR TO USE.
- 3. CONTRACTOR SHALL NOT STAGE OR OPERATE EQUIPMENT WITHIN THE DRIPLINE OF TREES.
- 4. CONTRACTOR TO PROVIDE A CERTIFIED ARBORIST WHO WILL DETERMINE ANY ROOT PRUNING AND ANY OTHER TRIMMING ACTIVITIES. COST TO BE INCIDENTAL TO CONSTRUCTION, NO ADDITIONAL COMPENSATION WILL BE PROVIDED.
- 5. A NATIONAL POLITIANT AND DISCHARGE FUMINATION SYSTEM (NPDES) PERMIT IS REQUIRED. CONTACT FLYROSA ESTEVEZ OF CITY OF MIAMI PUBLIC WORKS NPDES SECTION STORMWATER FROSION AND SEDIMENT CONTROL DURING ONSTRUCTION SHALL BE IN ACCORDANCE WITH THE CITY'S MUNICIPAL SEPARATE STORM SEWER SYSTEM (MS4) PERMIT. A NPDES PERMIT FROM THE FDEP WILL ALSO BE REQUIRED

WHEN ENCOUNTERING OR EXPOSING ANY ABNORMAL CONDITION INDICATING THE PRESENCE OF A HAZARDOUS OR TOXIC WASTE, OR CONTAMINANTS, CEASE OPERATIONS IMMEDIATELY IN THE VICINITY AND NOTIFY THE LAP CITY OF MIAMI ENGINEER. THE PRESENCE OF TANKS OR BARRELS; DISCOLORED EARTH, METAL, WOOD, GROUND WATER, ETC.; VISIBLE FUMES; ABNORMAL DOORS; EXCESSIVELY HOT EARTH; SMOKE; OR OTHER CONDITIONS THAT APPEAR ABNORMAL MAY INDICATE HAZARDOUS OR TOXIC WASTES OR CONTAMINANTS AND MUST BE TREATED WITH EXTREME CAUTION.

MAKE EVERY EFFORT TO MINIMIZE THE SPREAD OF CONTAMINATION INTO UNCONTAMINATED AREAS, IMMEDIATELY PROVIDE FOR THE HEALTH AND SAFETY OF ALL WORKERS AT THE JOB SITE AND MAKE PROVISIONS NECESSARY FOR THE HEALTH AND SAFETY OF THE PUBLIC THAT MAY BE EXPOSED TO ANY POTENTIALLY HAZARDOUS CONDITIONS, PROVISIONS SHALL MEET ALL APPLICABLE LOCAL, STATE, AND FEDERAL LAWS, RULES, REGULATIONS OR CODES COVERING HAZARDOUS CONDITIONS AND WILL BE IN A MANNER COMMENSURATE WITH THE GRAVITY OF THE CONDITIONS.

THE LAP CITY OF MIAMI ENGINEER AND/OR CONTRACTOR WILL COORDINATE AND MOBILIZE A QUALIFIED CONTAMINATION ASSESSMENT, REMEDIATION (CAR) CONTRACTOR, QUALIFICATIONS OF SUCH CAR CONTRACTOR SHALL INCLUDE, BUT NOT BE LIMITED TO: EXPERIENCE AND PERSONNEL TO PREPARE CONTAMINATION ASSESSMENTS, PREPARE SITE ASSESSMENT REPORTS, REMEDIATION PLANS, INFLUENMENT REMEDIAL ACTION PLANS, RISK BASED CORRECTIVE ACTIONS, STORAGE TANKS SYSTEM REMOVAL, HIGHWAY SPILL RESPONSE AS WELL AS EXPERIENCE WITH INFRASTRUCTURE/CONSTRUCTION ACTIVITIES WITHIN (POTENTIALLY) CONTAMINATED AREAS SPECIFIC TO TRANSPORTATION SYSTEMS.

ALL THE WORK PERFORMED BY THE CAR CONTRACTOR SHALL BE PERFORMED IN COMPLIANCE WITH ALL APPLICABLE LOCAL, STATE AND FEDERAL REGULATIONS GOVERNING WORKER SAFETY AND ENVIRONMENTAL REGULATIONS, THIS IS TO INCLUDE OCCUPATIONAL EXPOSURE TO CONTAMINATED SOILS, GROUNDWATER, WASTES AND ATMOSPHERE DURING THE CONSTRUCTION OF ALL FEATURES INCLUDED IN THE CONSTRUCTION PLANS. IN ADDITION, THE CAR CONTRACTOR MUST BE STAFFED WITH FLORIDA LICENSED TECHNICAL PROFESSIONALS (GEOLOGISTS AND ENGINEERS) WHO WILL BE INVOLVED WITH THE PROJECT AND KNOWLEDGEABLE OF THE WORK ACTIVITIES CONDUCTED WITHIN THE IDENTIFIED CONTAMINATED AREAS AND WHO WOULD SIGN AND SEAL PROJECT REPORTS AS REQUIRED FOR SUBMITTAL TO THE APPROPRIATE ENVIRONMENTAL REGULATORY AGENCIES.

THE LAP CITY OF MIAMI ENGINEER WILL IMMEDIATELY NOTIFY THE FLORIDA DEPARTMENT OF TRANSPORTATION (FDOT) DISTRICT VI CONTAMINATION IMPACT COORDINATOR (DCIC) AT (305) 470-5228 AFTER ENCOUNTERING THE UNIDENTIFIED AREAS OF CONTAMINATION, PRELIMINARY INVESTIGATION BY THE CAR CONTRACTOR WILL DETERMINE THE COURSE OF ACTION NECESSARY FOR SITE SECURITY AND THE STEPS NECESSARY UNDER APPLICABLE LAWS, RULES, AND REGULATIONS FOR ADDITIONAL ASSESSMENT AND/OR REMEDIATION WORK TO RESOLVE THE CONTAMINATION ISSUE.

FOLLOWING COMPLETION OF THE PROJECT THE CAR CONTRACTOR SHALL BE REQUIRED TO PROVIDE COPIES OF ALL REPORTS SUBMITTED TO REGULATORY AGENCIES WASTE MATERIAL PROFILES MANIFESTS AND/OR DISPOSAL RECEIPTS FOR NG BUT NOT LIMITED TO GROUND WATER, WASTE WATER, SOILS, SOLID WASTES, SLUDGE, HAZARDOUS WASTES, AIR MONITORING RECORDS AND SAMPLE RESULTS FOR ALL MATERIALS TESTED AND ANALYZED TO THE LAP CITY OF MIAMI ENGINEER AND THE FDOT DCIC

- 7. NO STAGING OR ADDITIONAL ACTIVITIES FOR THIS PROJECT NOT DEPICTED ON THE CURRENT PLAN SUBMITTAL WILL BE ALLOWED WITHIN THE NATIONAL REGISTER-ELIGIBLE SPRING GARDEN HISTORIC DISTRICT (8DA6419) AND NW 11TH STREET ROW FROM NW 11TH COURT TO NW 8TH STREET ROAD: STA. 4+75.00 RT TO STA. 17+85.00 R
- 8. ARCHAEOLOGICAL MONITORING BY A PROFESSIONAL ARCHAEOLOGIST MEETING THE SECRETARY OF THE INTERIOR'S PROFESSIONAL QUALIFICATIONS STANDARDS AND APPROVED BY BOTH THE CITY OF MIAMI AND THE FOOT DISTRICT SIX CULTURAL RESOURCES COORDINATOR IS REQUIRED FOR SUBSURFACE EXCAVATION BETWEEN STATIONS 14480.00 TO STA 22+00.00. THE CONTRACTOR MUST COORDINATE WITH THE ARCHAEOLOGIST CONTRACTED BY THE CITY OF MIAMI, PROVIDING AT LEAST 72-HOURS' NOTICE PRIOR TO EXCAVATION.



REVISIONS EOR DATE BY DESCRIPTION Francisco J. Alonso, P.E. No 66918 T-Y-LIN INTERNATIONAL



CITY OF MIAMI CAPITAL IMPROVEMENTS PROGRAM 444 S.W. 2ND AVENUE, 8TH FLOOR MIAMI, FLORIDA 33130 (305) 416-1213 FAX (305) 416-1253

CITY OF MIAMI CAPITAL IMPROVEMENTS PROGRAM PROJECT NAME PROJECT No. OVERTOWN GREENWAY PHASE II

B-173648

GENERAL NOTES & LEGEND

SHEET NO.

2

\-M\Projects\EGSC-Overtown\Dwg\2018032 GEN NOTES & LEGEND - Standard\2018032 GEN NOTES & LEGEND - Plot Date:12.21.201

SUMMARY OF PAY ITEMS

8	ROADWAY			10
PAY ITEM	PAY ITEM DESCRIPTION UNI		PLAN QUANTITY	FINAL QUANTITY
101-1	Mobilization	LS	1	
102-1	Maintenance of Traffic	LS	1	
104-18	Inlet Protection	EA	4	
110-1-1	Clearing and Grubbing	L5	1	
110-4-10	Removal of Existing Concrete Pavement	SY	2,031	
160-4	Type B Stabilization	SY	2,796	
425-4	Inlet Adjust	EA		
425-5-1	Manhole Adjust	EA	6	
425-6	Valve Adjust	EA	2	
(Pull Box Adjust	EA	22	
520-2- AA	Concrete Curb	LF	20	
522-1	Sidewalk Concrete, 4" Thick	SY	2,395	
522-2	Sidewalk Concrete, 6" Thick	SY	137	
524-2-AB	Sidewalk Concrete, 9" Thick	SY	264	
527-1	Detectable Warning on Walking Surface Retrofit	SY	17	
	Lighting System	LS	1	
	Hardscape Complete (see landscape plans)	LS	1	,
580-1-1	Landscape Complete (see landscape plans, Small plants)	LS	1	
580-1-2	Landscape Complete (see landscape plans, Large plants)	LS	1	
Y .	Permitting Allowance	L5	1	

PAY ITEM NOTES

1. ALL DEMOLITION AND FENCE REMOVAL, WITH THE EXCEPTION OF THE REMOVAL OF EXISTING CONCRETE PAVEMENT, SHALL BE PAID UNDER CLEARING AND GRUBBING

SUMMARY OF PAY ITEMS

SIGNING AND PAVEMENT MARKING					
PAY I	TEM	PAY ITEM DESCRIPTION	UNIT	PLAN QUANTITY	FINAL QUANTITY
0711 11	1123	12" Solid Traffic Stripe (White)	LF	278	
0711 11	1125	24" Solid Traffic Stripe (White)	LF	161	
0711 11	1170	Directional Arrows	EA	2	
0711 11	1211	6" Solid Traffic Stripe (Yellow)	LF		
0700 20	0 11	Single Post Sign, F&I, Less than 12 sf	A5	6	
0700 02	2 40	Single Post Sign	AS	5	
0700 20	0.60	Single Post Sign Remove	AS	5	




		REVISIONS	EOR
DATE	BY	DESCRIPTION	
			Francisco J. Alonso, P.E.
1			No. 66918
			T-Y-LIN INTERNATIONAL



CITY OF MIA. CAPITAL IMPROVEMEN	
PROJECT NAME	PROJECT No.
OVERTOWN GREENWAY PHASE II NW 11 STREET	B-173648

SUMMARY OF PAY ITEMS

SHEET NO.

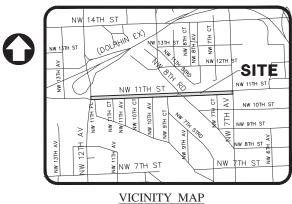

NOT TO SCALE

by scales determination in the subject, poperary on peerar of our in North-Out Control, following the Celevation N/A as per Federal Emergency Management Agency (FEMA) Community-Panel Number 120650, Map No. 120860312, Suffix L. Revised Date: 09-11-2009. An accurate Zoned determination should be made by the preparer of the map, the Federal Emergency Management Agency, or the Local Coverment Agency having jurisdiction over such matters prior to any judgments being made must be compared to the succession of the Zone as noted. The referenced Federal Emergency Management Agency Map states in the notes to the user that "this map is for

- The Survey depicted herein is not intended to show the location or existence of any Wetland or Jurisdictional areas, or areas of protected species of vegetation either natural or cultivated.
- Any use of this Survey for purposes other than which it was intended, without written verification, will the user's sole risk and without liability to the surveyor. Nothing herein shall be construed to give any rights or benefits to anyone than those certified to.
- Since no other information other than what is cited in the Sources of Data were furnished, the Client is hereby advised that there may legal restrictions on the Subject Property that are not shown on the Suney Map or contained within this Report that may be found in the Public Records of Mamil-Dade County, or the records of any other public and private entities as their jurisdictions may appear. The Surveyor makes no representation as to ownership or possession of the Subject Property by any entity or individual who may

Notice is hereby given that Sumhine State One Call of Florida, inc. must be contacted at 1-800-432-4770 at least 48 hours in advance of any construction, excavation or demolition activity within, upon, abutting or adjacent to the Subject Property. This Notice is given in compliance with the "Underground Tacility Damage Prevention and Safety Act," pursuant to Chapter 556-010-111 of the Florida Statutes.

ASPH.	Aspnait	PVC	Polyvinyl Chloride	20	water weter
BFP	Backflow Preventer	R/W	Right-of-Way Line	×	Irrigation Valve
€	Center Line	S=	Spread / Canopy	α <u>υ</u> β_	Concrete Light Pole
CONC.	Concrete	T	Electrical Transformer	×	Water Valve
C.B.S.	Concrete Block Structure	T.O.P.	Top of Pipe	x 10.00	Spot Elevation
CLF	Chain Link Fence	VCP	Vitrified Clay Pipe	> _{GPP}	Utility Concrete Power
C.S.	Concrete Slab	1'-20'-10'	Diameter-Height-Spread	-	Traffic Sign
C.P.	Concrete Porch	LECEN	D.		
CO	Cleanout	LEGEN	<u>D</u>		
C.W.	Concrete Walk				
DIP	Ductile Iron Pipe		Concrete		
EB	Electric Box		Metal Cover		
ELEV.	Elevation		Area Under Construction		
ENCR.	Encroachment	—-x—	Chain Link Fence		
F.F.E.	Finish Floor Elevation		Right of Way Lines		
FH	Fire Hydrant	8	Fire Hydrant		
GND.	Ground	E	Electric Wiring Box		
GP	Guard Post	*	Light Pole		
HDPE	High Density Polyethylene	Ш	Catch Basin		
ID.	Identification	(E)	Electric Manhole		
MP	Metal Pipe	(AH)	Unknown Manhole		
MH	Manhole	Ś	Sanitary Manhole		
O.R.B.	Official Record Book	Ō	Telephone Manhole		
P.B.	Plat Book	(S)	Water Manhole		
PG.	Page	مد	Palm (No Identified)		

Tree (No Identified)

BENCHMARK	DESCRIPTION	ELEVATION	
N-3012	NW 6 ST 48' North of centerline. NW 7 Ave 33' East of centerline. PK Nail and Aluminium washer in concrete catch basin.	3.56+0.26=3.82 (City of Miami Datum)	
C-320	NW 7 ST 32' North of centerline. NW n12 Ave 135' East of centerline. PK Nail and Brass washer in concrete in front of Traffic control Box.	15.01+0.26=15.27 (City of Miami Datum)	
ELEVATIONS AS SHOWN HEREON REFER TO THE CITY OF MIAMI DATUM			

SURVEYOR'S CERTIFICATE:

This is to certify to the herein named firm and/or persons that the "Boundary & Topographic Survey" of the herein described property is true and correct to the best of our knowledge and belief as surveyed under our direction. I further certify that this survey meets the Standards of Practice Requirements as set forth in Chapter 5.1.17, Florida Administrative Code, as adopted by the Florida Board of Professional Surveyors and Mappers pursuant to 472.027 Florida Statute.

NOTICE: Not valid without the signature and original raised seal of a Florida Licensed Surveyor and Mapper. Additions or deletions to Survey Maps by other than the signing party are prohibited without the written consent

TEL. (305) 265-5030 FAX. (305) 265-5033 EB = 5098 , LB = 5098

Project Name: **OVERTOWN**

GREENWAY PHASE 2 NW 11th STREET

BETWEEN NW 12th AVENUE AND nw 7th AVENUE

Property Owner: CITY OF MIAMI

R	evisions	
No.	Description	Date
1.	Revised Changed Datum to City of Miami	07-27-
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_		

SPECIFIC PURPOSE SURVEY

LAND SURVEYOR & MAPPER

Jorge R. Avifió, PSM No. 4996 Land Surveyor & Mapper


Project No.	17129.00
Scale:	1" = 20'
Date:	07/27/2018
Drawn:	E.O
Checked:	J.R.A.
Cubmittal	

Drawing Title:

Cad File:

SU-1

Sheet No. 1 of 2

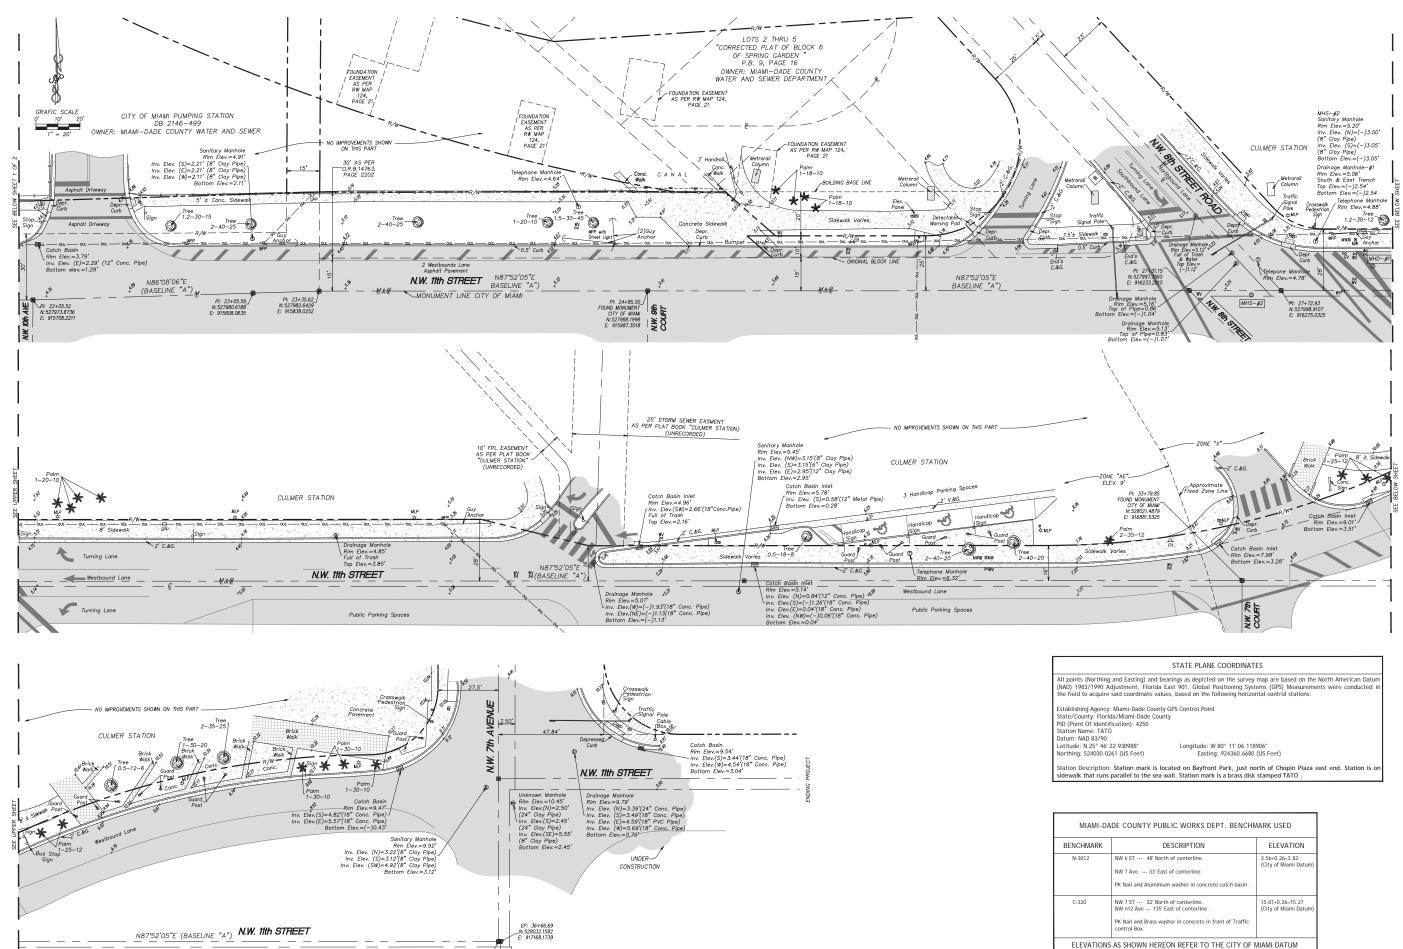



OVERTOWN GREENWAY PHASE 2

Project Name:

NW 11th STREET BETWEEN NW 12th AVENUE AND nw 7th AVENUE

Property Owner:

CITY OF MIAMI

F	Revisions	
No.	Description	Date
1.	Revised Changed Datum to City of Miami	07-27-18

WRITTEN DIMENSIONS ON THIS DRAWING SHALL HAN PRECEDENCE OVER SCALED DIMENSIONS. CONTRACTOR SHALL VERIFY AND BE RESPONSIBLE FOR ALL DIMENSIONS AND CONDITIONS ON THE JOE AND THIS OFFICE MUST BE NOTIFIED OF ANY VARIATION FROM THE DIMENSIONS.

> SPECIFIC PURPOSE SURVEY

LAND SURVEYOR & MAPPER

e R. Avifió. PSM No. 4996

Project No. 17129.00

Scale: 1" = 20'

Date: 07/27/2018

Drawn: E.O.

Checked: J.R.A.


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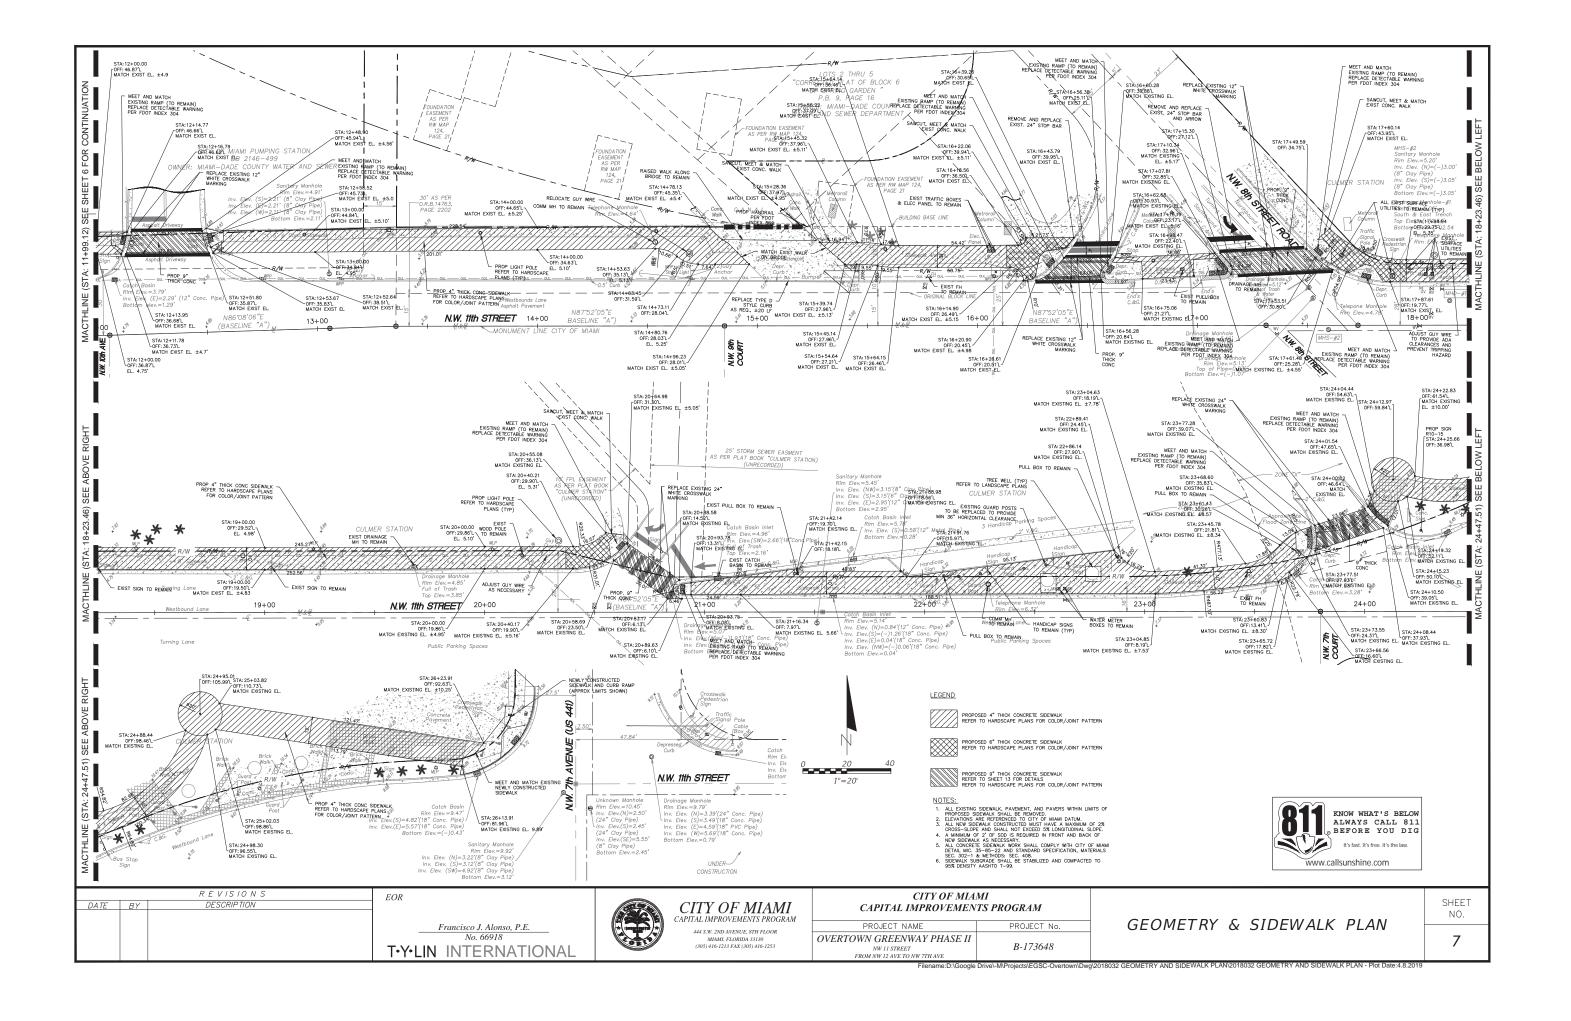
Submittal:

Drawing Title:

SU-2

Sheet No. 2 of 2



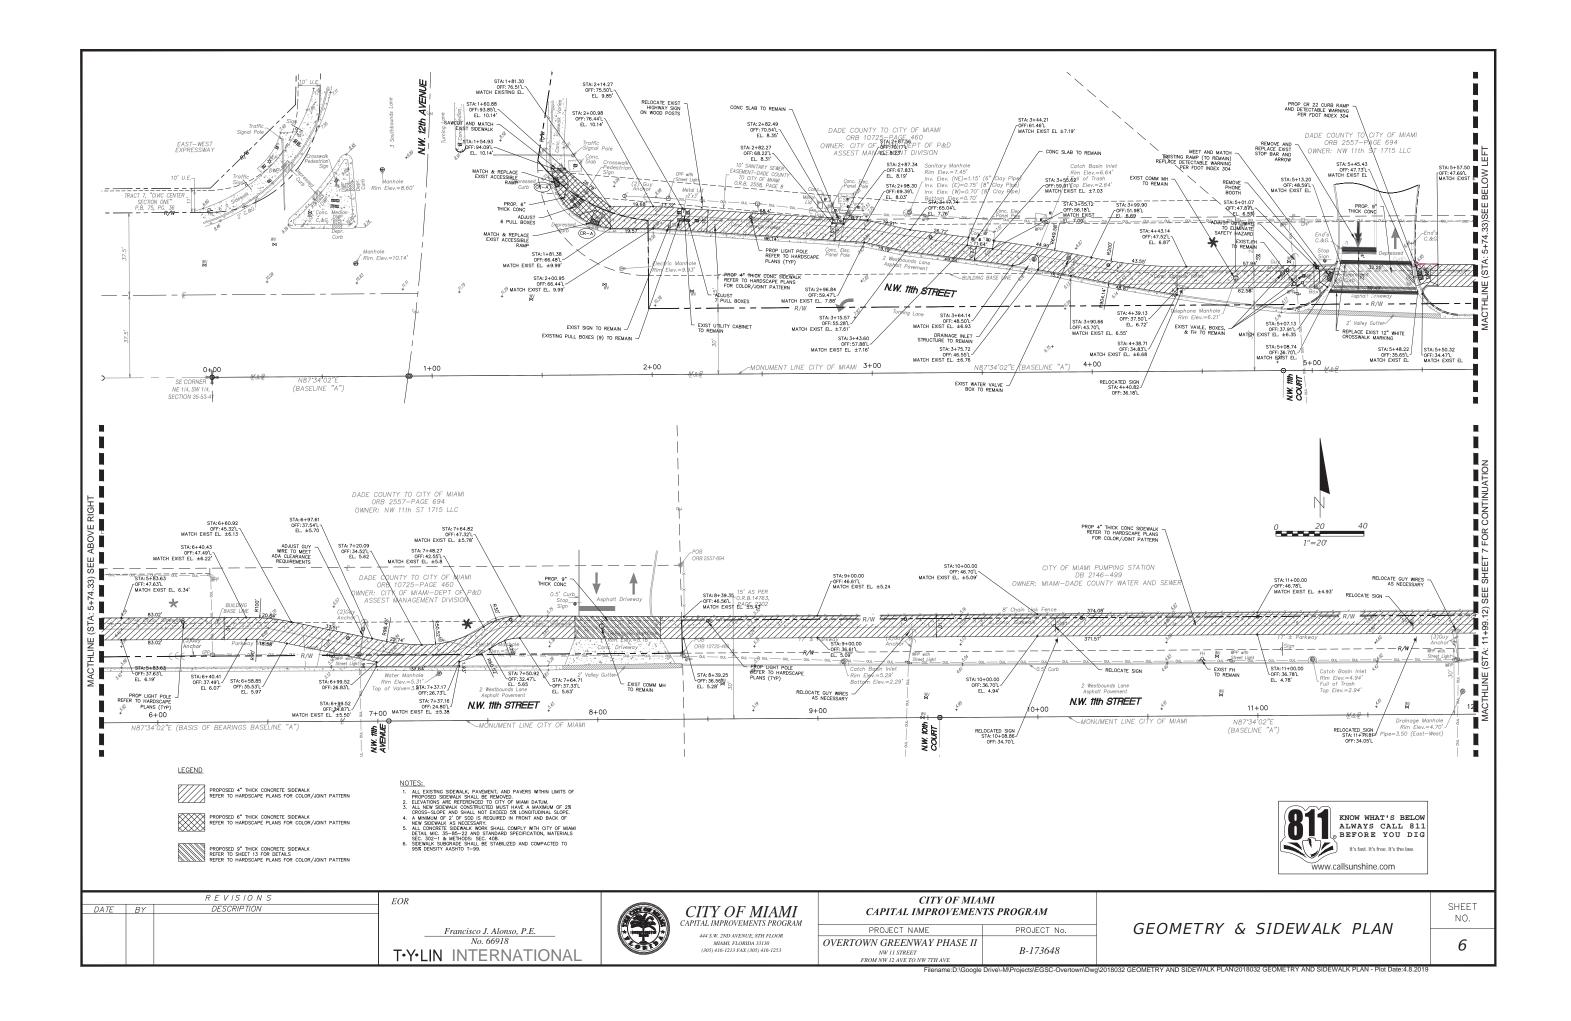

STORM WATER POLLUTION PREVENTION NOTES:

THE FOLLOWING NARRATIVE OF THE STORMWATER POLLUTION PREVENTION PLAN CONTAINS REFERENCES TO THE STANDARD SPECIFICATIONS FOR ROAD AND BRIDGE CONSTRUCTION, THE DESIGN STANDARDS, AND OTHER SHEETS OF THESE CONSTRUCTION PLANS. THE FIRST SHEET OF THE CONSTRUCTION PLANS KEY SHEET CONTAINS AN INDEX TO THE OTHER SHEETS. THE COMPLETE STORMWATER POLLUTION PREVENTION PLAN INCLUDES SEVERAL ITEMS: THIS NARRATIVE DESCRIPTION, THE DOCUMENTS REFERENCED IN THIS NARRATIVE, THE CONTRACTOR'S APPROVED EROSION CONTROL PLAN REQUIRED BY SPECIFICATION SECTION 104, AND REPORTS OF INSPECTIONS MADE DURING CONSTRUCTION.

- A. THE FOLLOWING NARRATIVE AND REFERENCED DOCUMENTS,
- B. THE CONTRACTOR'S APPROVED EROSION AND SEDIMENT CONTROL PLAN REQUIRED BY SPECIFICATION SECTION 104, CITY OF MIAMI PW BULLETIN No. 25 AND CITY ORDINANCE No. 13081,
- C. REPORT OF INSPECTIONS MADE DURING CONSTRUCTION.

1.0 SITE DESCRIPTION

1.A. NATURE OF CONSTRUCTION ACTIVITY:

THE PLAN DELINEATED IN THIS SWPPP IS FOR CONSTRUCTION ACTIVITIES WITHIN OVERTOWN GREENWAY NW 11TH STREET FROM NW 7TH AVENUE TO NW 12TH AVENUE. THE PROJECT INCLUDES CONSTRUCTION OF SIDEWALK IMPROVEMENTS AND INSTALLATION OF LANDSCAPING AND HARDSCAPE.

1.B. SEQUENCE OF MAJOR SOIL DISTURBING ACTIVITIES:

IN THE SECTION 104 EROSION & SEDIMENT CONTROL PLAN, THE CONTRACTOR SHALL PROVIDE A DETAIL SEQUENCE OF CONSTRUCTION FOR ALL CONSTRUCTION ACTIVITIES. THE CONTRACTOR SHALL FOLLOW THE SEQUENCE OF MAJOR ACTIVITIES DESCRIBED BELOW, UNLESS THE CONTRACTOR PROPOSES A DIFFERENT SEQUENCE THAT IS THE EQUAL OR BETTER AT CONTROLLING EROSION AND TRAPPING SEDIMENT AND IS APPROVED BY THE FINGINGER

INSTALL PERIMETER EROSION AND SEDIMENT CONTROLS AFTER CLEARING AND GRUBBING NECESSARY FOR INSTALLATION OF CONTROLS BUT BEFORE CLEARING AND GRUBBING OTHER AREAS OF THE SITE.

- CLEARING AND GRUBBING.
- 2. ASPHALT MILLING AND RESURFACING
- 3. DRAINAGE WORK

1.C. AREA ESTIMATES

TOTAL PROJECT AREA: 0.56 ACRES TOTAL AREA TO BE DISTURBED: 0.56 ACRES

1.D. RUNOFF DATA

Runoff Coefficients:

Before Construction: 0.78During Construction: 0.78After Construction: 0.98

1.E. SITE MAP

THE SHEETS CONSTRUCTION PLANS ARE BEING USED AS THE SITE MAPS. THE LOCATION OF THE REQUIRED INFORMATION IS DESCRIBED BELOW. THE SHEET NUMBERS FOR THE PLANS REFERENCED IN THIS SECTION ARE INDENTIFIED ON THE KEY SHEET OF THE PLANS.

- * DRAINAGE PATTERNS: THE DRAINAGE BASIN DIVIDES AND FLOW DIRECTIONS ARE SHOWN ON THE GRADING & DRAINAGE PLAN. THE FLOW ARROWS REPRESENT THE FLOW DIRECTION.
- * APPROXIMATE SLOPES: THE PLANS MAINTAINS A 2% TYPICAL CROSS SLOPE AS INDICATED ON THE TYPICAL SECTION.
- * AREAS OF SOIL DISTURBANCE: THE LIMITS OF SOIL DISTURBANCE ARE SHOWN ON THE TYPICAL SECTION SHEETS AND PLANS SHEETS.
- * AREAS NOT TO BE DISTURBED: ENTIRE PROJECT AREA TO BE DISTURBED.
- * LOCATIONS OF TEMPORARY CONTROLS: ROCK BAGS WILL BE LOCATED AROUND ALL EXISTING AND PROPOSED INLETS; TURBIDITY BARRIERS WILL BE LOCATED AT ANY BODIES OF WATER AFFECTED BY THIS PROJECT.
- * LOCATIONS OF PERMANENT CONTROLS: PERMANENT FEATURES ARE SHOWN ON THE CONSTRUCTION PLANS, WHICH GENERALLY CONSIST OF SOD, ASPHALT, CONCRETE, AND DRAINAGE STRUCTURES.
- * SURFACE WATERS: NONE
- * WETLAND AREAS: NONE
- * AREAS TO BE STABILIZED: NEW ROADWAY BASE AND SODDED AREAS

2.0 CONTROLS

2.A. EROSION AND SEDIMENT CONTROLS:

IN THE SECTION 104 EROSION AND SEDIMENT CONTROL PLAN, THE CONTRACTOR SHALL DESCRIBE THE PROPOSED STABILIZATION AND STRUCTURAL PRACTICES BASED ON THE CONTRACTORS TRAFFIC CONTROL PLAN. THE FOLLOWING RECOMMENDED GUIDELINES ARE BASED ON THE TRAFFIC CONTROL PLAN (TCP) OUTLINED IN THESE CONSTRUCTION PLANS. THE CONTRACTOR MAY CHOOSE TO ACCEPT THE FOLLOWING GUIDELINES OR MODIFY THEM IN THE SECTION 104 EROSION CONTROL PLAN, SUBJECT TO APPROVAL OF THE ENGINEER. AS WORK PROGRESSES, THE CONTRACTOR SHALL MODIFY THE PLAN TO ADAPT TO SEASONAL VARIATION, CHANGES IN CONSTRUCTION ACTIVITES AND THE NEED FOR BETTER PRACTICES. TO LIMIT THE TRANSPORT OF SEDIMENT FROM THE CONSTRUCTION AREA, THE CONTRACTOR, SHALL MINIMIZE THE SOIL AREAS EXPOSED AT ANY GIVEN TIME AND SHALL STABILIZE AREAS THAT WILL REMAIN IDLE FOR MORE THAN 7 DAYS. THE CONTRACTOR SHALL UTILIZE GRADING TECHNIQUES TO DIRECT RUNOFF TO AREAS WITH THE PROPER EROSION CONTROL FEATURES INSTALLED AND AWAY EDOM OPEN WATER OR OTHER SENSITIVE AREAS ADJACENT TO THE WORK SITE

2.A.1 STABILIZATION PRACTICES:

IN THE SECTION 104 EROSION & SEDIMENT CONTROL PLANS, THE CONTRACTOR SHALL DESCRIBE THE STABILIZATION PRACTICES PROPOSED TO CONTROL EROSION. THE CONTRACTOR SHALL INITIATE ALL STABILIZATION MEASURES AS SOON AS PRACTICAL, BUT IN NO CASE MORE THAN 14 DAYS. IN PORTIONS OF THE SITE WHERE CONSTRUCTION ACTIVITIES HAVE TEMPORARILY OR PERMANENTLY CEASED THE STABILIZATION PRACTICES PROPOSED BY THE CONTRACTOR SHALL INCLUDE AT LEAST THE FOLLOWING:

PERMANENT:

- * ASPHALT OR CONCRETE SURFACE.
- * SOD IN ACCORDANCE WITH ORDINANCE 12636.

2.A.2 STRUCTURAL PRACTICES:

IN THE SECTION 104 EROSION & SEDIMENT CONTROL PLANS, THE CONTRACTOR SHALL DESCRIBE THE STRUCTURAL PRACTICES TO CONTROL OR TRAP SEDIMENT AND OTHERWISE PREVENT THE DISCHARGE OF POLLUTANTS FROM EXPOSED AREAS OF THE SITE. ALL SEDIMENTS CONTROLS SHALL BE IN PLACE BEFORE ANY SOIL DISTURBING ACTIVITY UPSTREAM OF THE CONTROL. THE STRUCTURAL PRACTICES PROPOSED BY THE CONTRACTOR SHALL INCLUDE AT LEAST THE FOLLOWING:

TEMPORARY:

* ROCK BAGS IN ACCORDANCE WITH DESIGN STANDARD 102 AND SPECIFICATION SECTION 104.

PERMANENT:

- * CURB AND GUTTER
- * DRAINAGE STRUCTURES
- * S0D

2.B. STORM WATER MANAGEMENT:

DRAINAGE PATTERNS AND DIVIDES ARE INCLUDED ON THE DRAINAGE MAP INCLUDED IN THE DRAINAGE REPORT. STORM WATER IS CAPTURE BY PROPOSED INLETS AND RETAIN IN INFILTRATION TRENCHES

2.C. OTHER CONTROLS

THE CONTRACTOR SHALL PRACTICE GOOD HOUSEKEEPING BY INSTITUTING A CLEAN, ORDERLY CONSTRUCTION SITE; THE FOLLOWING CONTROLS SHALL BE IMPLEMENTED TO FURTHER REDUCE POLLUTION AT THE PROJECT SITE:

2.C.1. DISCHARGE OF MATERIAL TO SURFACE WATERS:

NO CONSTRUCTION MATERIAL SHALL BE DISCHARGE TO WATERS OF THE STATE UNLESS AUTHORIZED BY SECTION 40. PERMIT AND/OR CONSTRUCTION DEBRIS SHALL BE DISPOSED OF IN AN APPROVED UPLAND LOCATION. BUILDING MATERIAL SHALL NOT BE DISPOSED OF IN WETLANDS OR BURIED ON-SITE. IN THE SECTION 104 EROSION CONTROL PLAN, THE CONTRACTOR SHALL DESCRIBE THE PROPOSED METHODS TO PREVENT THE DISCHARGE OF SOLID MATERIALS, INCLUDING BUILDING MATERIAL. THE PROPOSED METHODS SHALL INCLUDE AT LEAST THE FOLLOWING, UNLESS OTHERWISE APPROVED BY THE ENGINEER.

- * PROVIDE LITTER CONTROL AND COLLECTION WITHIN THE PROJECT LIMITS DURING CONSTRUCTION ACTIVITIES.
- * DISPOSE OF ALL FERTILIZER OR OTHER CHEMICAL CONTAINERS ACCORDING TO EPA'S STANDARD PRACTICES AS DETAILED BY THE MANUFACTURER.
- * DISPOSE OF SOLID MATERIALS INCLUDING BUILDING AND COSNTRUCTION MATERIALS OFF THE PROJECT SITE BUT NOT IN SURFACE WATERS OR WETLANDS.

2.C.2. OFF-SITE VEHICLE TRACKING AND DUST CONTROL.

THE CONTRACTOR SHALL TAKE MEASURES TO INSURE THE CLEANUP OF THE SEDIMENTS THAT HAVE BEEN TRACKED BY VEHICLES OR HAVE BEEN TRANSPORTED BY WIND OR STORM WATER ABOUT THE SITE OR ONTO NEARBY ROADWAYS.

STABILIZED CONSTRUCTION ENTRANCES AND CONSTRUCTION ROADS, IF APPROPRIATE, SHALL BE IMPLEMENTED IN ORDER TO REDUCE OFF-SITE TRACKING. LOADED HAUL TRUCKS SHALL BE COVERED WITH TARPAULIN. EXCESS DIRT ON THE ROAD SHALL BE REMOVED DAILY. PROVIDE A STREET SWEEPING PLAN TO THE CITY INSPECTOR.

IN THE SECTION 104 EROSION CONTROL PLAN, THE CONTRACTOR SHALL DESCRIBE THE PROPOSED METHODS FOR MINIMIZING OFFSITE VEHICLE TRACKING OF SEDIMENTS AND GENERATING DUST. THE PROPOSED METHODS SHALL INCLUDE AT LEAST THE FOLLOWING UNLESS OTHERWISE APPROVED BY THE ENGINEER.

- * COVER LAODED HAUL TRUCKS WITH TARPAULINS.
- * REMOVE EXCESS DIRT FROM ROADS DAILY.
- * STABILIZE CONSTRUCTION ENTRANCES ACCORDING TO DESIGN STANDARDS 106. (CONTRUCTION ENTRANCES ARE ALREADY STABILIZED FOR THIS PROJECT)

${\it 2.C.3.} \ \underline{\it WASTE DISPOSAL, SANITARY SEWER OR SEPTIC TANK REGULATIONS:}$

THE CONTRACTOR SHALL DEMONSTRATE THE PROPER DISPOSAL OF ALL CONSTRUCTION WASTE GENERATED WITHIN THE PROJECT LIMITS. WASTE MAY INCLUDE, BUT NOT LIMITED TO, VEGETATION FROM CLEANING AND GRUBBING ACTIVITIES, PACKAGING MATERIAL, SCRAP BUILDING MATERIAL, LITTER FROM TRAVELING PUBLIC, SEWAGE FROM SANITARY FACILITIES, HERBICIDES AND PESTICIDES AND THEIR CONTAINERS, AND HYDROCARBON PRODUCTS SHALL BE DESIGNATE A WASTE COLLATION AREA ON SITE AND DELINEATE THE AREA ON THE SWPPP SITE MAP.

SANITARY SEPTIC FACILITIES SHALL BE PROVIDED AND MAINTAINED IN A NEAT AND SANITARY CONDITION, FOR THE USE OF THE CONTRACTOR'S EMPLOYEES AS NECESSARY TO COMPLY WITH THE REQUIREMENTS AND REGULATIONS OF THE STATE AND LOCAL BOARDS OF HEALTH. A LICENSED SANITARY WASTE MANAGEMENT CONTRACTOR AS REQUIRED BY THE STATE REGULATIONS WILL COLLECT ALL SANITARY WASTE FROM PORTABLE UNITS.

THE CONTRACTOR WILL PROVIDE LITTER CONTROL AND COLLECTION WITHIN THE PROJECT LIMITS DURING CONSTRUCTION ACTIVITIES.
CONTRACTOR WILL PROVIDE AN ADEQUATE NUMBER OF LITTER CONTAINERS WITH LIOS AT THIS STAGING STOCKPILE AND FIELD OFFICE
AREAS. WASTE COLLECTION WILL BE SCHEDULED SO THAT CONTAINERS ARE EMPTIED PRIOR TO OVERFLOW. SPILLED LITTER CONTAINERS
WILL BE CLEANED UP IMMEDIATELY



		REVISIONS	EOR
DATE	BY	DESCRIPTION	
			Francisco J. Alonso, P.E.
			No. 66918
			T-Y-LIN INTERNATIONAL
			ITITLIN INTERNATIONAL



CITY OF MIA. CAPITAL IMPROVEMEN	
PROJECT NAME	PROJECT No.
OVERTOWN GREENWAY PHASE II NW 11 STREET FROM NW 12 AVE TO NW 7TH AVE	B-173648

STORMWATER POLLUTION PREVENTION PLAN NOTES

SHEET NO.

STORM WATER POLLUTION PREVENTION NOTES CONTINUED:

2.C.4. FERTILIZERS AND PESTICIDES:

THE APPLICATION AND HANDLING OF HERBICIDES AND PESTICIDES SHALL BE IN COMPLIANCE WITH THE MANUFACTURES-RECOMMENDED METHOD AND IN ACCORDANCE WITH FDOT STANDARD SPECIFICATION FOR ROADS AND BRIDGE CONSTRUCTION. HERBICIDES AND PESTICIDES SHALL BE ONSITE IN THEIR ORIGINAL CONTAINERS WITH PRODUCT LABEL INTACT.

2.C.5 TOXIC/HAZARDOUS MATERIAL HANDLING

CONTRACTOR SHALL PROVIDE EQUIPMENT NECESSARY TO CONTAIN AND CLEAN UP SPILLS OF HAZARDOUS MATERIAL AFTER THEY OCCUR. SPILLED MATERIAL AND THE EQUIPMENT USED TO CLEAN UP THE SPILL SHALL NOT COME IN CONTACT WITH SURFACE WATERS OR BE INTRODUCED INTO STORM WATER. DISPOSAL OF SURPLUS PRODUCT WILL BE DONE ACCORDING TO MANUFACTURE RECOMMENDED METHOD.

CONTRACTOR SHALL PROVIDE A PROJECT SPECIFIC HAZARDOUS MATERIAL SPILL CONTROL PLAN TO ADDRESS THE HANDLING OF HYDROCARBON AND HAZARDOUS MATERIALS.

PETROLEUM PRODUCTS SHALL BE STORED IN COVERED AREAS WITH SECONDARY CONTAINMENT SURROUNDING CONTAINER.

TOXIC/HAZARDOUS MATERIAL EXPOSED DURING CONSTRUCTION ACTIVITIES SHALL BE HANDLE AS PER THE FDOT STANDARD SPECIFICATIONS FOR ROAD AND BRIDGE CONSTRUCTION.

2.D STATE AND LOCAL PERMITS TO BE APPLIED FOR:

* NPDES FROM THE CITY OF MIAMI PUBLIC WORKS DEPARTMENT

3.0 MAINTENANCE

IN THE SECTION 104 EROSION CONTROL PLAN, THE CONTRACTOR SHALL PROVIDE A PLAN FOR MAINTAINING ALL EROSION AND SEDIMENT CONTROLS THROUGHOUT CONSTRUCTION. ALL EROSION CONTROL MEASURES SHALL BE MAINTAINED IN GOOD WORKING ORDER BY THE CONTRACTOR. IF A CONTROL NEEDS REPAIR OR REPLACEMENT, IT WILL BE INITIATED WITHIN 24 HOURS OF REPORT AND RECORDED ON THE INSPECTION FORMS. MAINTENANCE SHALL CONTINUE UNTIL ALL ERODIBLE SOILS WITHIN THE CONTRIBUTING AREA HAVE BEEN STABILIZED. AT THIS POINT, THE CONTRACTOR SHALL REMOVE EXCESS SILT AT THE CONTROLS AND REMOVE THE TEMPORARY DEVICES. THE MAINTENANCE PLAN SHALL AT MINIMUM. COMPLY WITH THE FOLLOWING:

- * INLET PROTECTION (ROCK BAGS): THE CONTRACTOR SHALL INSPECT THE PROTECTED INLETS EVERY TWO WEEKS AND REPLACE THE ROCK BAGS IF NECESSARY OR WHEN EXCESSIVE POUNDING OCCURS; ELIMINATE BREACHES IN THE PROTECTION.
- * TURBIDITY BARRIER: MAINTAIN AS PER SECTION 104 OF THE SPECIFICATIONS.
- * STREET SWEEPING: DAILY CONTROL AND DUST PREVENTION WITH WATER TRUCK.
- * GRASSED AREAS: NEWLY SODDED AREAS AND ADJACENT AREAS DISTURBED BY CONSTRUCTION OPERATIONS SHALL BE REPAIRED AND MAINTAINED, WATERING AND MOWING AS NEEDED OR REQUIRED IN THE FDOT STANDARD SECIFICATIONS.

4.0 INSPECTIONS

QUALIFIED PERSONNEL SHALL INSPECT ALL THE CONTROL FEATURES AT LEAST ONE EVERY 7 CALENDAR DAYS AND WITHIN 24 HOURS OF THE END OF A STORM THAT IS 0.50 INCHES OR GREATER. TO COMPLY THE CONTRACTOR SHALL INSTALL AND MAINTAIN RAIGES AND RECORD THE DAILY RAINFALL. WHERE SITES HAVE BEEN PERMANENTLY STABILIZED, INSPECTIONS SHALL BE CONDUCTED AT LEAST ONCE EVERY WEEK. THE CONTRACTOR SHALL ALSO ENSURE THAT CONTROLS INSTALLED IN THE FIELD AGREE WITH THE LATEST STORMWATER POLLUTION PREVENTION PLAN (SWPPP). THE FOLLOWING ITEMS WILL BE INSPECTED:

- * POINTS OF DISCHARGE TO SURFACE WATERS OR WETLANDS: INSPECT TO DETERMINE IF CONTROLS ARE EFFECTIVE IN PREVENTING OR MINIMIZING THE DISCHARGE OF POLLUTANTS.
- * POINTS OF DISCHARGE TO MUNICIPAL SEPARATE STORM SEWER SYSTEMS (INLETS, ETC.): INSPECT TO DETERMINE IF CONTROLS ARE EFFECTIVE IN PREVENTING OR MINMIZING THE DISCHARGE OF POLLUTANTS.
- * DISTURBED AREAS OF THE SITE THAT HAVE NOT BEEN FINALLY STABILIZED: INSPECT FOR EVIDENCE OF POTENTIAL FOR DISCHARGING POLLUTANTS INTO SURFACE WATERS OR STORMWATER SYSTEMS.
- * AREAS USED FOR STORAGE OF MATERIALS THAT ARE EXPOSED TO PRECIPITATION: INSPECT FOR EVIDENCE OF POTENTIAL FOR DISCHARGING POLLUTANTS INTO SURFACE WATERS OR STORMWATER SYSTEMS.
- * STRUCTURAL CONTROLS: INSPECT FOR PROPER INSTALLATION AND OPERATION.
- * STORMWATER MANAGEMENT SYSTEMS: INSPECT FOR PROPER OPERATION, EVIDENCE OF FLOODING DUE TO SEDIMENTATION OR CONTROLS REQUIRING MAINTENANCE.
- * LOCATIONS WHERE VEHICLES ENTER AND EXIT THE SITE: INSPECT FOR EVIDENCE OF OFFSITE TRACKING.

THE CONTRACTOR SHALL INITIATE WITHIN 24 HOURS OF INSPECTION THAT INDICATES ITEMS ARE NOT IN GOOD WORKING ORDER BASED ON THE RESULTS OF THE INSPECTION, ALL MAINTENANCE OPERATIONS NEEDED TO ASSURE PROPER OPERATION OF ALL CONTROLS, BMPS OR MEASURES IDENFIFIED IN THIS SWPPP SHALL BE DONE IN A TIMELY MANNER, BUT NO LATER THAN 7 CALENDAR DAYS FOLLOWING THE INSPECTION. IF NEEDED, POLLUTION PREVENTION CONTROLS SHALL BE REVISED AS APPROPRIATE IF FAILURES IN THE PLAN ARE NOTED; THESE REVISIONS SHALL BE IMPLEMENTED NO LATER THAN 7 CALENDAR DAYS FOLLOWING THE INSPECTION.

A REPORT (USE FDOT FORM 650-040-03) SUMMARIZING THE SCOPE OF THE INSPECTION SHALL INCLUDE THE INSPECTOR'S NAME, QUALIFICATIONS, DATE, RAINFALL DATA, OBSERVATIONS RELATING TO THE SWPPP, AND ACTIONS TAKEN SINCE THE LAST REPORT. THE REPORT SHALL INDENTIFY ALL INCIDENTS OF NON-COMPLIANCE.

IF THERE ARE NO INCIDENTS OF NON-COMPLIANCE, THE REPORT SHALL CONTAIN A CERTIFICATION THAT THE FACILITY IS IN COMPLIANCE WITH THE SWPPP AND THE PERMIT. THE REPORT SHALL BE SIGNED AND FILED AS REQUIRED BY THE GENERIC PERMIT.

THE CONTRACTOR SHALL MAINTAIN A FILE CONTAINING THE CURRENT SWPPP, NOI SUBMITTAL, CERTIFICATIONS AND ALL THE SIGNED INSECTION REPORTS; THE NOTICE OF INTENT SUBMITTED AS REQUIRED BY CHAPTER 62-621, FAC, MUST BE POSTED AT THE SITE

5.0 NON-STORM WATER DISCHARGES:

IN THE SECTION 104 EROSION CONTROL PLAN, THE CONTRACTOR SHALL IDENTIFY ALL ANTICIPATED NON-STORM WATER DISCHARGES (EXCEPT FLOWS FROM FIRE FIGHTING ACTIVITIES) SUCH AS THOSE LISTED BELOW. THE CONTRACTOR SHALL DESCRIBE THE PROPOSED MEASURES TO PREVENT POLLUTION FROM THESE NON-STORM WATER DISCHARGES.

IF CONTAMINATED SOIL OR GROUNDWATER IS ENCOUNTERED DURING CONSTRUCTION, THE CONTRACTOR IS TO CEASE OPERATIONS IN THAT AREA. THE CONTRACTOR SHALL CONTACT THE CITY OF MIAMI PROJECT MANAGER.

A DEWATERING PERMIT IS REQUIRED TO REMOVED GROUNDWATER FROM THE CONSTRUCTION SITE.

- * CULVERT INSTALLATION METHODS
- * SLURRY DISPOSAL
- * DUST CONTROL
- * EQUIPMENT WASHOUT
- * PIPE DESILTING ACTIVITIES
- * IRRIGATION

6.0 CONTRACTOR SUBMITTAL:

IT IS THE RESPONSIBILITY OF THE CONTRACTOR TO DEVELOP AN EROSION CONTROL PLAN THAT PROVIDES A DETAILED DESCRIPTION OF ALL EROSION AND SEDIMENT CONTROLS, BMP'S AND MEASURES THAT WILL BE IMPLEMENTED AT THE CONSTRUCTION SITE FOR EACH ACTIVITY IDENTIFIED IN SECTION 1.B SEQUENCE OF MAJOR SOIL DISTURBING ACTIVITIES. CONTRACTOR IS RESPONSIBLE FOR PROVIDING TIMEFRAMES IN WHICH THE CONTROLS WILL BE IMPLEMENTED, MAINTAINED AND REMOVED. THIS INFORMATION SHALL BE CONSIDERED IN COMPLIANCE WITH THE FDEP GENERIC PERMIT FOR STORM WATER DISCHARGE FROM LARGE AND SMALL CONSTRUCTION SITES.

THE CONTRACTOR IS RESPONSIBLE FOR ENSURING THE FOLLOWING ITEMS ARE ON SITE:

- 1. COPY OF THE SWPPP WITH THE ORIGINAL CERTIFICATION SIGNATURES.
- 2. COPY OF THE CONTRACTOR'S EROSION CONTROL PLAN.
- 3. HAZARDOUS SPILL CONTROL PLAN WITH GUIDELINES ON CONTACTING THE 24-HOUR EMERGENCY RESPONSE PROGRAM FOR HAZARDOUS MATERIAL SPILLS. THIS SHALL INCLUDE COPIES OF DISCHARGE NOTIFICATIONS THAT HAVE OCCURRED WITHIN THE PROJECT LIMITS.
- 4. COMPLETE INSPECTION FORMS.



R E V I S I O N S

DATE BY DESCRIPTION

Francisco J. Alonso, P.E.
No. 66918


T•Y•LIN INTERNATIONAL



CITY OF MIAMI CAPITAL IMPROVEMENTS PROGRAM	
PROJECT NAME	PROJECT No.
TOWN GREENWAY PHASE II	D 150510

B-173648

NW 11 STREET FROM NW 12 AVE TO NW 7TH AVE STORMWATER POLLUTION PREVENTION PLAN NOTES SHEET NO.

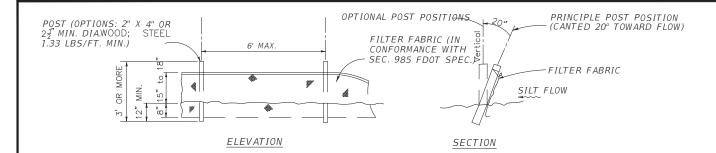

SILT FENCE DETAILS



TYPE III SILT FENCE PROTECTION AROUND DITCH BOTTOM INLETS.




NOTE: SPACING FOR TYPE III FENCE TO BE IN ACCORDANCE WITH CHART I, SHEET 1 OF 3 AND DITCH INSTALLATIONS AT DRAINAGE STRUCTURES SHEET 2 OF 3 PER INDEX 102

TYPE III SILT FENCE


Do not deploy in a manner that silt fences will act as a dam across permanent flowing watercourses.

Silt fences are to be used at upland locations and turbidity barriers used at permanent bodies of water.

SILT FENCE APPLICATIONS

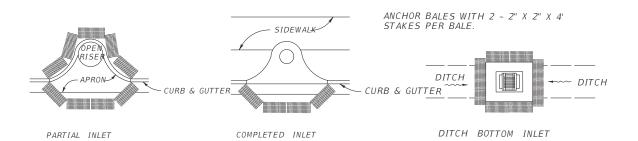

PROTECTION AROUND INLETS OR SIMILAR STRUCTURES

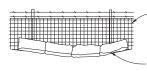

TYPE A OR B FENCE

NOTE: BALES TO BE STAKED AT THE DIRECTION OF THE ENGINEER.

- LOOSE SOIL PLACED BY SHOVEL AND LIGHTLY COMPACTED ALONG UPSTREAM FACE OF BALES.

STORM WATER POLLUTION PREVENTION PRACTICES: (FOR PROJECTS OF 1 ACRE OR MORE)

- 1. TREE PROTECTION AND PRUNING SHALL BE ACCOMPLISHED AS DETAILED IN SPECIAL PROVISIONS, THE CONSTRUCTION PLANS, AND OR PER TREE ORDINANCE 12636.
- 2. THE STORM WATER POLLUTION PREVENTION PLAN, SWPPP, SUBMITTED TO PUBLIC WORKS, SHALL DESCRIBE IN DETAIL HOW THE CONSTRUCTION EFFORT WILL BE PHASED WITH REGARDS TO MINIMIZING EROSION PROBLEMS BY THE USE OF TEMPORARY AND PERMANENT EROSION CONTROL MEASURES, FOR THE VARIOUS SEQUENCES OF CONSTRUCTION OPERATIONS. ANY MODIFICATIONS MUST BE APPROVED BY THE CITY OF MIAMI NPDES SECTION, DEPARTMENT OF PUBLIC WORKS.
- 3. ENVIRONMENTAL CONTROL FEATURES AS PROVIDED IN THE SWPPP, ARE TO BE INSTALLED AT ALL AREAS OF EXCAVATION OR FILL FOR DRAINAGE SYSTEM, OR STRUCTURE CONSTRUCTION PRIOR TO SUCH EXCAVATION OR FILL. INLET ENTRANCES ARE ALSO TO BE PROTECTED FROM SILTATION AS DETAILED ON SHEET 2 OF 4 OF MISC. 35-89-6.
- 4. ALL ENVIRONMENTAL CONTROL FEATURES ARE TO BE MAINTAINED THROUGHOUT THE LIFE OF THE PROJECT IN ACCORDANCE WITH N.P.D.E.S. REQUIREMENTS. THE CONTRACTOR MUST INSURE THAT ALL EROSION CONTROL FEATURES FUNCTION PROPERLY AT ALL TIMES.
- 5. ALL EROSION AND MATERIAL DEPOSITS MUST BE CONTAINED WITHIN THE PROJECT LIMITS.
- 6. ANY DAMAGED OR INEFFECTIVE ROCK BAGS ARE TO BE REPLACED WITH NEW ONES. THE LOCATION OF ROCK BAGS INSTALLATION IS AS MENTIONED IN THE SWPPP PLANS. THE PROJECT ENGINEER MAY SPECIFY OTHER AREAS AS NECESSARY.
- 7. DITCH BOTTOM INLETS SHALL BE PROTECTED FROM SEDIMENT INTAKE UNTIL PROJECT IS COMPLETE. ELEVATION OF GROUND OUTSIDE INLET TOP SHALL NOT BE HIGHER THAN INLET TOP. ROCK BAGS SHALL BE INSTALLED AROUND INLET TOP. COMPLETED INLETS IN PAVED AREAS SHALL ALSO BE PROTECTED WITH ROCK BAGS TO PREVENT SEDIMENT INTAKE.
- 8. CURB INLETS ALSO SHALL BE PROTECTED FROM SEDIMENT INTAKE UNTIL THE PROJECT IS COMPLETE. ALL EXPOSED SLOPED MATERIAL ADJACENT TO INLET, SHALL BE COVERED WITH EROSION CONTROL MATTING WITH OUTER LIMITS PROTECTED BY ROCK BAGS.
- 9. STOCKPILED MATERIAL SHALL NOT BE LEFT IN EROSION PRONE AREAS UNLESS PROTECTED BY COVER OR ROCK BAGS.
- 10. INSPECTION OF EROSION CONTROL MEASURES AND CONDITION OF ADJACENT PROPERTIES, SHALL BE PERFORMED DAILY BY THE CONTRACTOR'S REPRESENTATIVE AND THE PROJECT ENGINEER. DEFICIENCIES SHALL BE NOTED AND CORRECTED.
- 11. ANY OFFSITE SEDIMENT DISCHARGE TO A MUNICIPAL SEPARATE STORM WATER SYSTEM ARISING FROM THE CONTRACTOR'S ACTIVITIES IS NOT ALLOWED. REFER TO PUBLIC WORKS DEPARTMENT BULLETIN No. 25.
- 12. THE USE OF SANITARY SEWERS, FRENCH DRAINS, COVER DITCHES AND/OR ROCK DRAINS FOR THE DISPOSAL OF WASTEWATER IS EXPRESSLY PROHIBITED.

REFER TO PUBLIC WORKS DEPARTMENT BULLETIN No. 25. * NPDES - NATIONAL POLLUTION DISCHARGE ELIMINATION SYSTEM

STORM WATER POLLUTION PREVENTION PLAN (SWPPP)

B. EROSION & SEDIMENT CONTROL STABILIZATION	D. OTHER CONTROLS: OFFSITE VEHICLE TRACKING:	
PRACTICES:	HAUL ROADS DAMPENED FOR DUST CONTROL	
TEMPORARY SODDING	LOADED HAUL TRUCKS TO BE COVERED WITH TARPAULIN, O	R APPROVED EQUAL.
TEMPORARY GRASSING	EXCESS DIRT ON ROAD REMOVED DAILY	
PERMANENT PLANTING, SEEDING OR SEED	STABILIZED CONSTRUCTION ENTRANCE	
TEMPORARY MULCHING	CONCRETE TRUCK WASH AREA	
ARTIFICIAL COVERING	OTHER TREATMENT OF STORM WATER TO MEET WATER QUAR	LITY:
BUFFER ZONES	DEEP WELLS	
PRESERVATION OF NATURAL RESOURCES	CULVERTS FOR EMERGENCY OVERFLOW	NOW WHAT'S BELOW
OTHER	POLLUTION CONTROL STRUCTURES	ALWAYS CALL 811 BEFORE YOU DIG
	OTHER	It's fast. It's free. It's the law.

- E. GENERAL
- 1. APPROVED STATE, LOCAL PLANS OR STORM WATER PERMITS.
- 2. ALL OF THE CONTROLS SHALL BE MAINTAINED AT ALL TIMES.
- 3. ALL CONTROLS SHALL BE INSPECTED DAILY.
- 4. APPLY FERTILIZERS AND PESTICIDES ACCORDING TO STANDARD SPECIFICATIONS, DESIGN AND SPECIAL PROVISIONS.
- 5. REPORT NON-STORM WATER DISCHARGE (INCLUDING SPILL) (305) 416-1200.
- 6. VISIT www.dep.state.fl.us/water/stormwater/npdes/

- 1				
			REVISIONS	EOR
	DATE	BY	DESCRIPTION	
				Francisco J. Alonso, P.E
				No. 66918
				T-Y-LIN INTERNATIONAL



CITY OF MIA. CAPITAL IMPROVEMEN	
PROJECT NAME	PROJECT No.
VERTOWN GREENWAY PHASE II	R-173648

C. STRUCTURAL PRACTICES:

__SAND BAGGING

FROM NW 12 AVE TO NW 7TH AVE

STORMWATER POLLUTION PREVENTION PLAN DETAILS

SHEET NO.

10

Data:9 22 2019

www.callsunshine.com

TRAFFIC CONTROL NOTES:

GENERAL NOTES:

- 1. THE TRAFFIC AND TRAVEL WAYS SHALL NOT BE ALTERED BY THE CONTRACTOR TO CREATE A WORK ZONE UNTIL ALL LABOR AND MATERIAL ARE AVAILABLE FOR THE CONSTRUCTION IN THAT AREA.
- 2. REGULATORY SPEED ESTABLISHED WITHIN WORK ZONE TRAVEL WAYS SHALL BE THE EXISTING POSTED SPEED (20MPH).
- 3. AS DETERMINED BY THE CONSTRUCTION PROJECT MANAGER, THE CONTRACTOR SHALL COVER WORK ZONE SIGNS WHEN CONDITIONS NO LONGER WARRANT THEIR USE. COST OF COVERING AND UNCOVERING THE SIGNS SHALL BE INCIDENTAL TO THE PROJECT AT NO ADDITIONAL COST TO THE CONTRACT.
- 4. CONTRACTOR SHALL REMOVE, RELOCATE OR COVER ANY EXISTING OR PROPOSED SIGNS THAT CONFLICT WITH THE TRAFFIC CONTROL PLANS. WHEN THE CONFLICT NO LONGER EXISTS, THE CONTRACTOR SHALL RESTORE THE SIGNS TO THEIR ORIGINAL POSITION. COST OF TEMPORARILY COVERING OR REMOVING/RELOCATING AND RESTORING THE SIGNS SHALL BE INCIDENTAL TO THE PROJECT AT NO ADDITIONAL COST TO THE CONTRACT.
- 5. EACH EXISTING STREET NAME AND STOP SIGN AFFECTED BY CONSTRUCTION SHALL BE RELOCATED AND MAINTAINED IN AN APPROPRIATE LOCATION FOR THE DURATION OF THE PROJECT. WHEN NO LONGER AFFECTED BY CONSTRUCTION, THESE SIGNS SHALL BE RESTORED TO THEIR ORIGINAL POSITION. COST OF TEMPORARILY RELOCATING AND RESTORING THE SIGNS SHALL BE INCIDENTAL TO THE PROJECT AT NO ADDITIONAL COST TO THE CONTRACT.
- 6. CONTRACTOR SHALL BE RESPONSIBLE FOR THE IMMEDIATE REMOVAL OF STORMWATER FROM ROADWAYS UTILIZED FOR MAINTAINING TRAFFIC THRU
 THE WORK ZONE IN A MANNER APPROVED BY THE CONSTRUCTION PROJECT MANAGER. COST FOR REMOVING THE WATER SHALL BE DEEMED
 INCIDENTAL TO THE PROJECT COST.
- 7. THE TRAFFIC CONTROL PLAN SHALL COMPLY WITH FDOT INDEX 600 SERIES.
- 8. ALL WORK SHALL BE PERFORMED DURING DAYTIME ON WEEKDAYS FROM 8:00AM TO 6:00PM (NO INTERRUPTION OF TRAFFIC IS PERMITTED) AND FROM 9:00AM TO 5:00PM ON SATURDAY.
- 9. CONTRACTOR SHALL NOTIFY LAW ENFORCEMENT AND FIRE PROTECTION SERVICES TWENTY-FOUR (24) HOURS IN ADVANCE OF ANY DETOURS, IN ACCORDANCE WITH SECTION 336.07 OF FLORIDA STATUTES.
- 10. CONTRACTOR MUST PROVIDE FLASHER ARROW BOARD FOR ANY LANE THAT IS CLOSED OR DIVERTED
- 11. THE CONSTRUCTION SITE IS LOCATED WITHIN AN ACTIVE COMMERCIAL/ENTERTAINMENT DISTRICT AND ADJACENT TO A PUBLIC SCHOOL. THE CONTRACTOR SHALL STRICTLY COMPLY WITH THE MAINTENANCE OF TRAFFIC AND NOTIFICATION REQUIREMENTS FOR THIS PROJECT.
- 12. A SEPARATE CITY OF MIAMI PUBLIC WORKS MAINTENANCE OF TRAFFIC PERMIT SHALL BE REQUIRED PRIOR TO CONSTRUCTION
- 13. SUITABLE ACCESS TO PRIVATE PROPERTY SHALL BE PROVIDED AT ALL TIMES.
- 14. CONTRACTOR SHALL CONTACT MIAMI DADE TRANSIT (MDT) AND REQUEST A SPOTTER FOR ANY WORK WITHIN 30' OF ANY MDT FACILITY. THE COST OF THIS SHALL BE INCLUDED IN PAY ITEM 102-1, "MAINTENANCE OF TRAFFIC".

DROP OFFS:

1. THE CONTRACTOR SHALL PROTECT THE WORK ZONE WITH DEVICES APPROVED BY THE CITY OF MIAMI PUBLIC WORKS WHEN DROP OFFS EXCEED 3" ADJACENT TO TRAVEL WAYS.

MARKINGS:

- 1. THE CONTRACTOR SHALL REMOVE ANY EXISTING OR TEMPORARY PAVEMENT MARKINGS THAT CONFLICT WITH THE TRAFFIC CONTROL PLANS. GRINDING OR MILLING WITHOUT ASPHALT OVERLAY SHALL ONLY BE PERMITTED IN NON-TRAFFIC AREAS AS DESIGNATED BY THE CONSTRUCTION PROJECT MANAGER. PAVEMENT MARKINGS SHALL BE REPLACED AT THE TIME TRAFFIC CONTROL PLANS ARE NO LONGER AFFECTED BY THEIR PLACEMENT. COST OF REMOVAL AND REPLACEMENT OF PAVEMENT MARKINGS SHALL BE INCIDENTAL TO THE PROJECT AT NO ADDITIONAL COST TO THE CONTRACT. USE OF BLACK PAINT TO COVER EXISTING AND/OR TEMPORARY PAVEMENT MARKINGS IS PROHIBITED.
- 2. TEMPORARY PAVEMENT MARKING SHALL BE PAINT.

WORK ZONE LIMITS:

1. THE LENGTH OF AN OPEN TRENCH, ALONG NW 11 TERRACE FROM NW 3 AVENUE TO NW 2 AVENUE, SHALL NOT EXCEED 500 FEET. PROPERTY ACCESS SHALL BE MAINTAINED AT ALL TIMES.

PEDESTRIANS, BICYCLES, AND WHEELCHAIRS:

- 1. AT THE END OF EACH WORK DAY OR WHENEVER THE WORK ZONE BECOMES INACTIVE, ANY DROP OFF ADJACENT TO THE PEDESTRIAN, BICYCLE, AND WHEELCHAIR TRAVEL PATHS SHALL BE BACKFILLED FLUSH WITH THE SAID PATHS OR PROTECTED WITH BARRICADES, TEMPORARY CONCRETE BARRIER WALL, OR APPROVED HANDRAIL. COST OF BACKFILLING DROP OFF SHALL BE INCIDENTAL TO THE PROJECT AT NO ADDITIONAL COST TO THE CONTRACT
- 2. PEDESTRIAN, BICYCLE, AND WHEELCHAIR TRAFFIC SHALL BE MAINTAINED AND GUIDED USING APPROVED WARNING LIGHTS, SIGNING, AND CHANNELIZATION DEVICES ON AT LEAST ONE SIDE OF THE PROJECT AT ALL TIMES THROUGHOUT THE PROJECT LIMITS. THE TRAVEL PATH SHALL BE A MINIMUM OF 4 FEET WIDE WITH A SMOOTH SURFACE THAT IS NOT SLICK AND IT SHOULD BE RAMPED AS NECESSARY FOR CONTINUITY. COST TO CONSTRUCT AND MAINTAIN THE TRAVEL PATH AS REQUIRED SHALL BE INCIDENTAL TO THE PROJECT AT NO ADDITIONAL COST TO THE CONTRACT.

TRAFFIC CONTROL PHASES:

TBD

PROJECT INFORMATION SIGN

1. A PROJECT INFORMATION SIGN IS TO BE INSTALLED PRIOR TO CONSTRUCTION ALONG NW 11TH STREET.



		REVISIONS	EOR
DATE	BY	DESCRIPTION	
			Francisco J. Alonso, P.E.
			No. 66918
			T-Y-LIN INTERNATIONAL



CITY OF MIA CAPITAL IMPROVEMEN	
PROJECT NAME	PROJECT No.
OWN GREENWAY PHASE II	B-173648


FROM NW 12 AVE TO NW 7TH AVE


TRAFFIC CONTROL NOTES

SHEET NO.


11

Filename:D:\Google Drive\-M\Projects\EGSC-Overtown\Dwg\2018032 TRAFFIC CONTROL NOTES - Standard\2018032 TRAFFIC CONTROL NOTES - Plot Date:12.21.2018

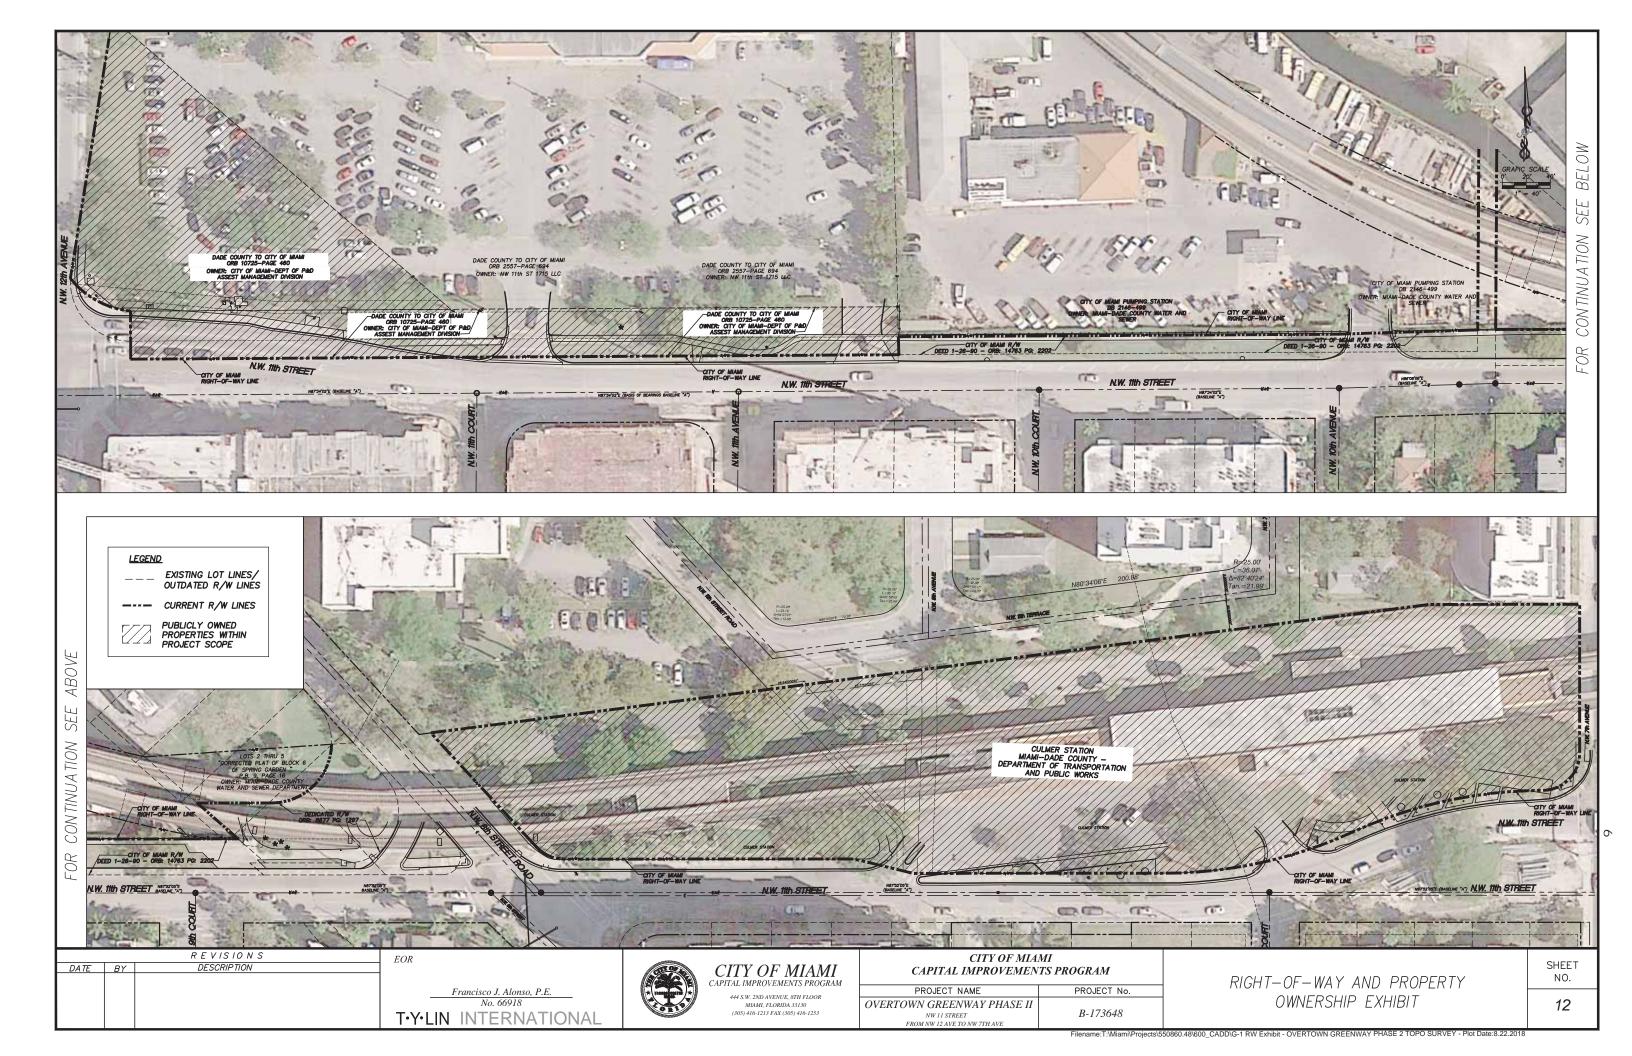

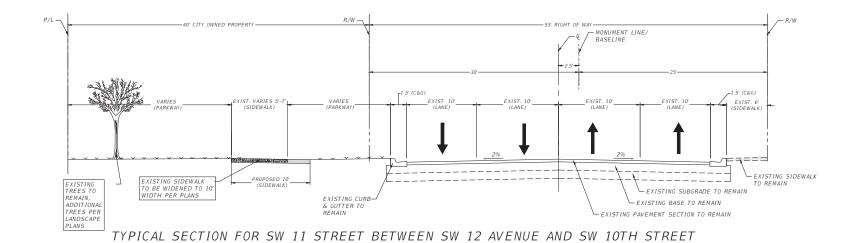

FROM STA. 1+00 TO STA. 8+39

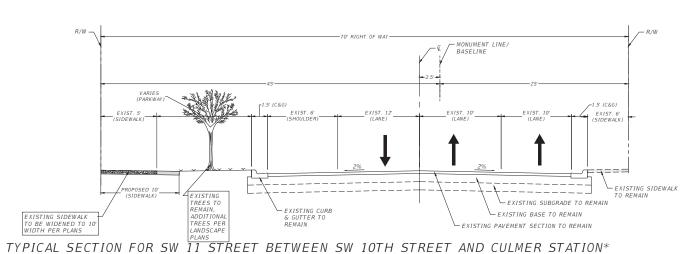


FROM STA. 8+39 TO STA. 17+50


N.T.S

DESIGN SPEED = 35 MPH *NOTE:EAST OF STA. 17+50, PROJECT IS WITHIN MDCTPW PROPETY, CULMER STATION

DESIGN SPEED = 35 MPH

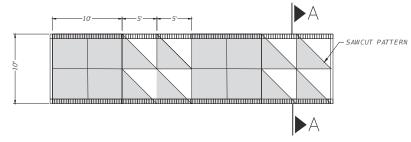

TYPICAL SIDEWALK REFER TO SHT H3.0 FOR SIDEWALK COLORS

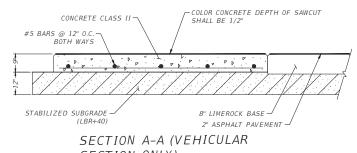

SECTION ONLY)


		REVISIONS	EOR
DATE	BY	DESCRIPTION	
			Francisco J. Alonso, P.E.
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			T-Y-LIN INTERNATIONAL




CITY OF MIA CAPITAL IMPROVEMEN	
PROJECT NAME	PROJECT No.
VERTOWN GREENWAY PHASE II	B-173648

TYPICAL SECTIONS &	
DETAILS	


SHEET	
NO.	

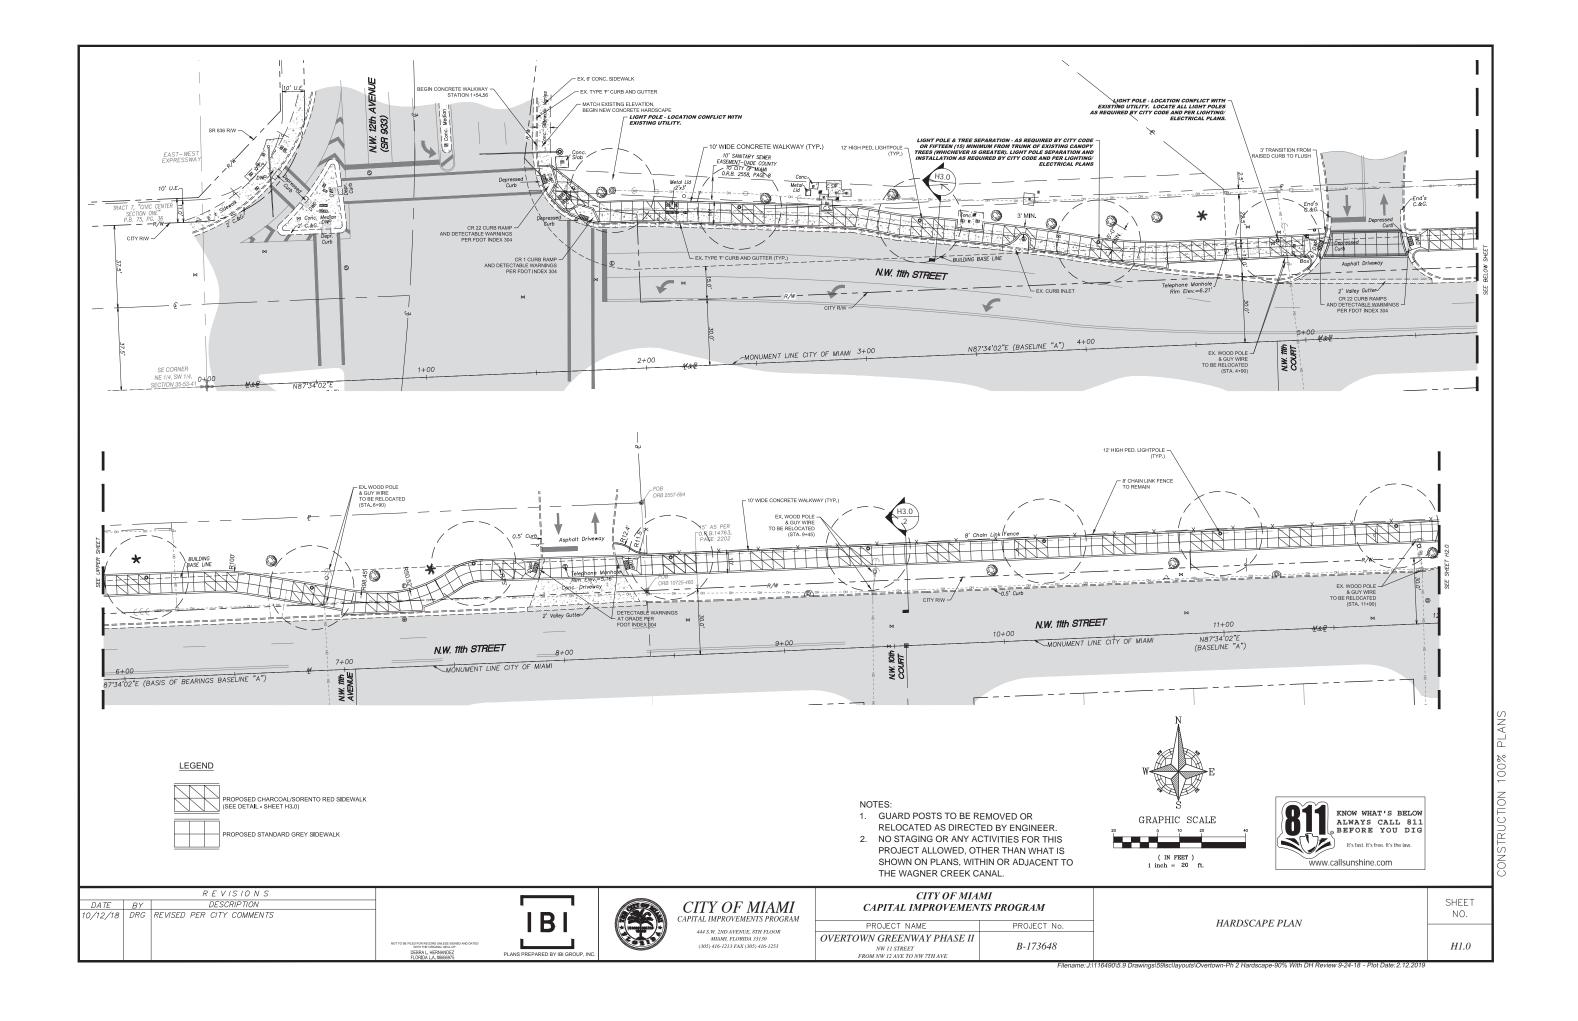

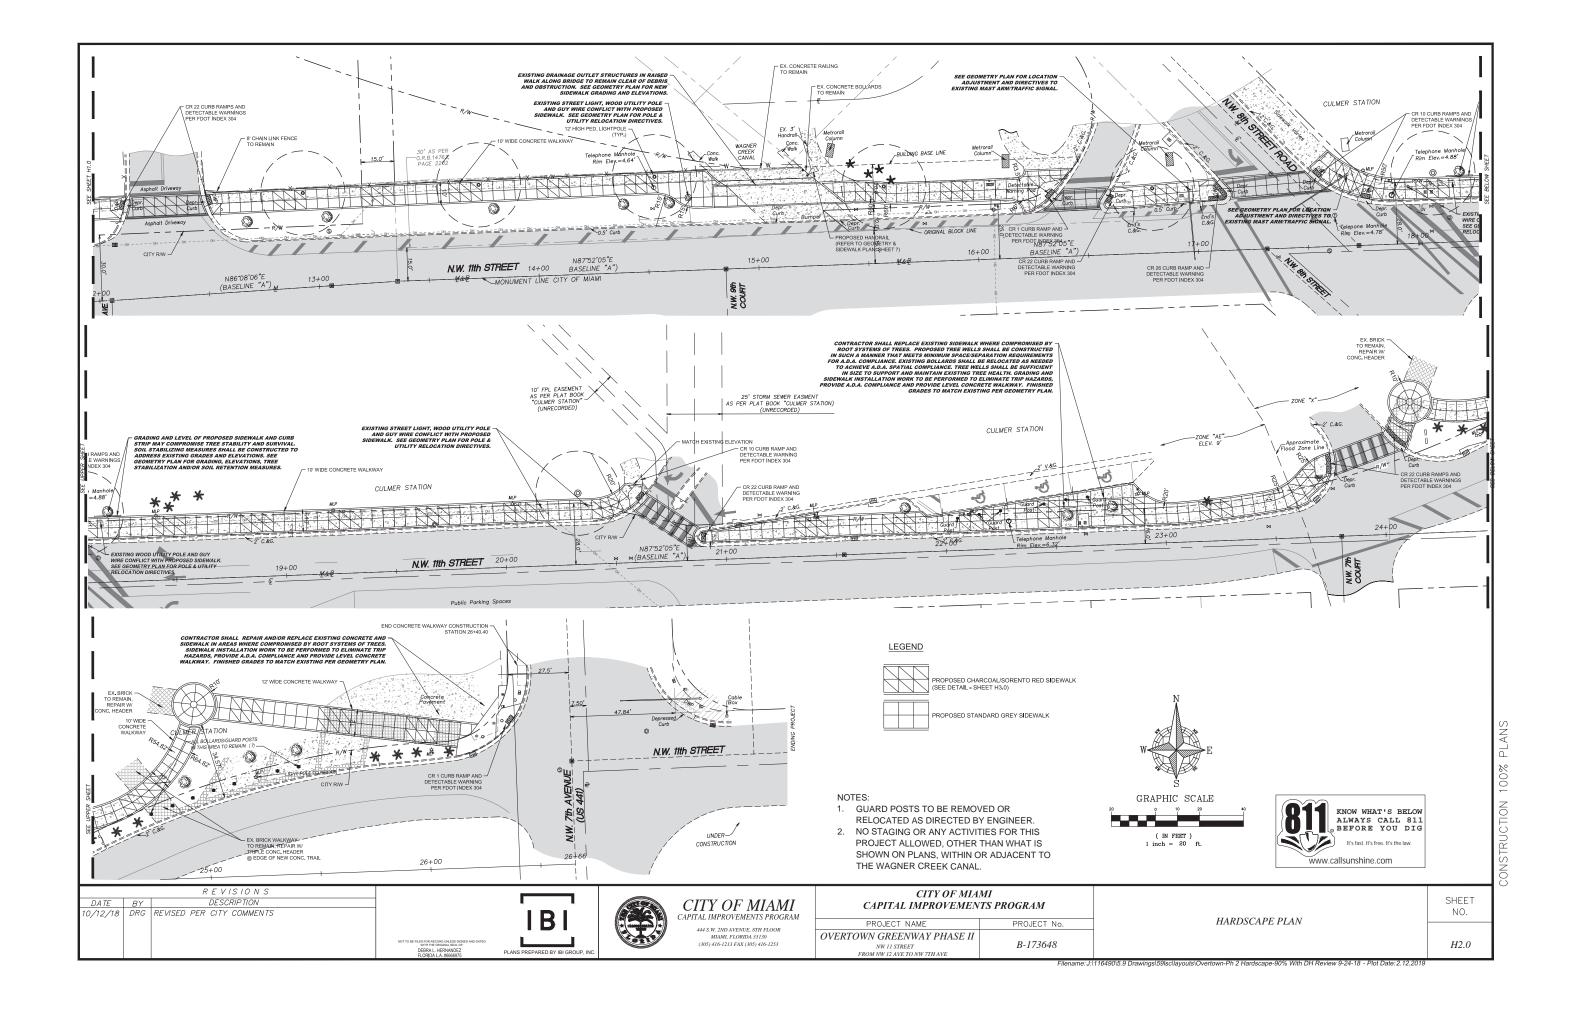

- FOR USE ADJACENT TO CONCRETE OR FLEXIBLE PAVEMENT. EXPANSION JOINT, PREFORMED JOINT FILLER AND JOINT SEAL ARE REQUIRED BETWEEN CURBS AND CONCRETE PAVEMENT ONLY.
- CONTRACTION JOINTS CONTRACTION JOINTS SHALL BE PLACED AT EQUAL SPACES (10" MAX.) BETWEEN NORMAL EXPANSION JOINTS. CONTRACTION JOINTS SHALL BE CUT IN THE UPPER I/, OF CURB AND GUTTER WITHIN 24 HOURS OF PLACEMENT.
- ENDS IF VERTICAL CURB SHALL TRANSITION FROM FULL TO ZERO HEIGHTS IN 3 FEET.
- 4. ALL CONCRETE SHALL BE A MINIMUM 3,500 PSI AT 28 DAYS.


TYPE 'D' CURB DETAIL N.T.S.

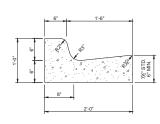

NOTE:


WHEN USED ON HIGH SIDE OF ROADWAYS, THE CROSS SLOPE OF THE GUTTER SHALL MATCH THE CROSS SLOPE OF THE AUACENT PAVEMENT AND THE THICKNESS OF THE LIP SHALL BE 6°, UNLESS OTHERWISE SHOWN ON PLANS.


TYPE 'F' CURB & GUTTER DETAIL

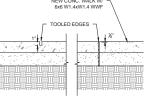


- EXPANSION JOINTS SHALL BE LOCATED AT ALL CONCRETE
 WALK INTERSECTIONS, AT ALL DOOR OPENINGS AND AT 12'
 O.C. MAXIMUM.
- EXPANSION JOINT (¼" PREMOLDED ASPHALT STRIP) SHALL BE SET ¼" BELOW TOP OF WALK. SCORE MARK (1" DEPTH) SHALL BE 4' (MAX.) O.C.
- 3. ALL CONCRETE SHALL BE A MINIMUM 3,500 PSI AT 28 DAYS. 4. REFER TO GEOMETRY PLAN FOR THICKNESS OF CONCRETE.

CONCRETE SIDEWALK DETAIL

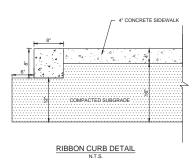

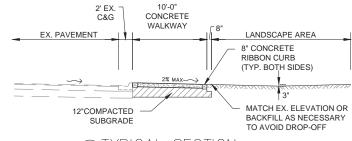


TYPICAL SECTION

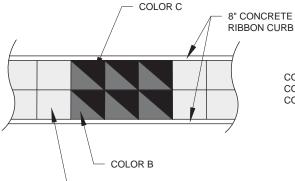


COLOR A: STANDARD GREY CONCRETE COLOR B: CHARCOAL (SCOFIELD C-24 OR EQUAL)


COLOR C: SORENTO RED (SCOFIELD 5059 OR EQUAL)

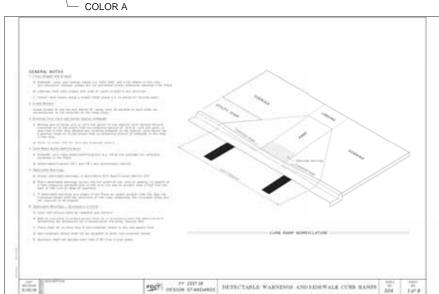

TYPICAL SIDEWALK

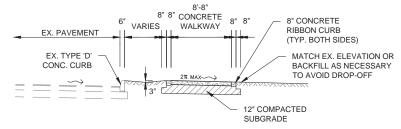

TYPICAL SECTION

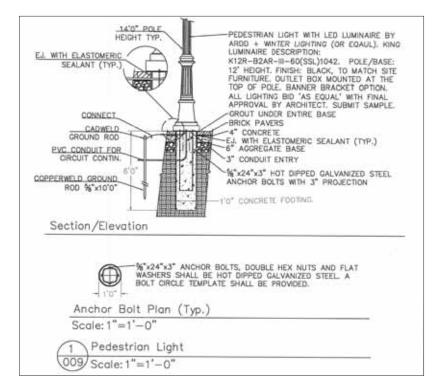



REVISIONS DESCRIPTION DATE BY 10/12/18 DRG REVISED PER CITY COMMENTS

IBI PLANS PREPARED BY IBI GROUP.



CITY OF MIAMI CAPITAL IMPROVEMENTS PROGRAM 444 S.W. 2ND AVENUE, 8TH FLOOR MIAMI, FLORIDA 33130 (305) 416-1213 FAX (305) 416-1253


CITY OF MIA. CAPITAL IMPROVEMEN	
PROJECT NAME	PROJECT No.
OVERTOWN GREENWAY PHASE II NW 11 STREET FROM NW 12 AVE TO NW 7TH AVE	B-173648


HARDSCAPE DETAILS

SHEET NO.

H3.0


Filename: J:\116490\5.9 Drawings\59lsc\layouts\Overtown-Ph 2 Hardscape-90% With DH Review 9-24-18 - Plot Date: 2.12.201

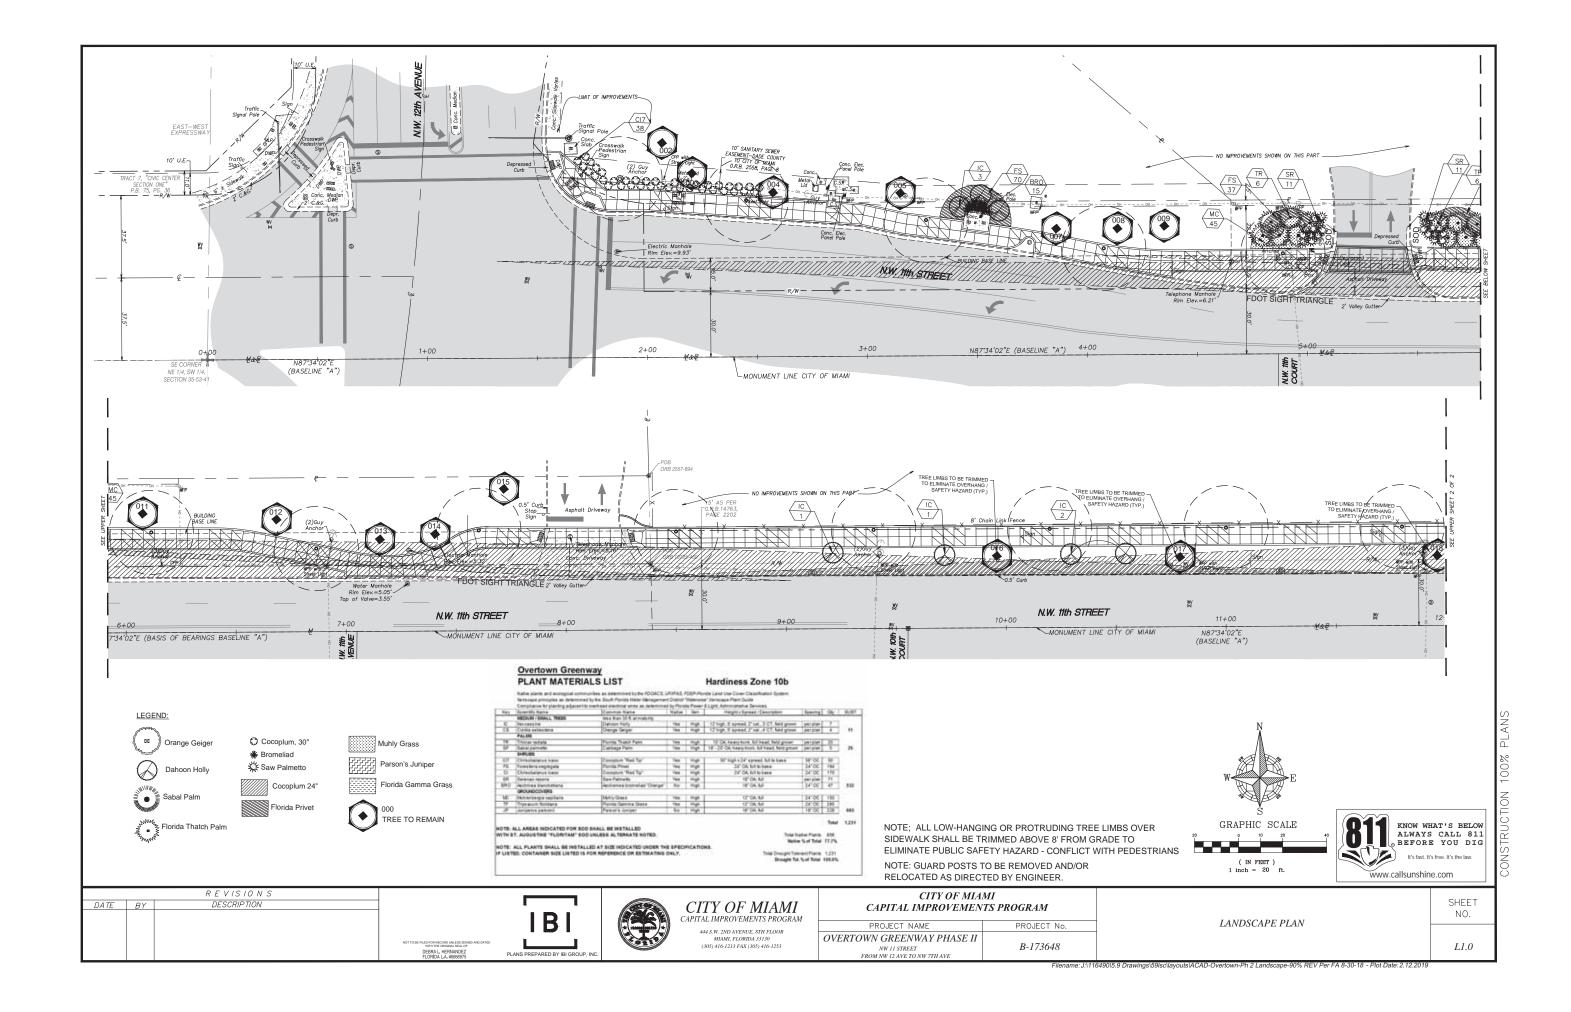

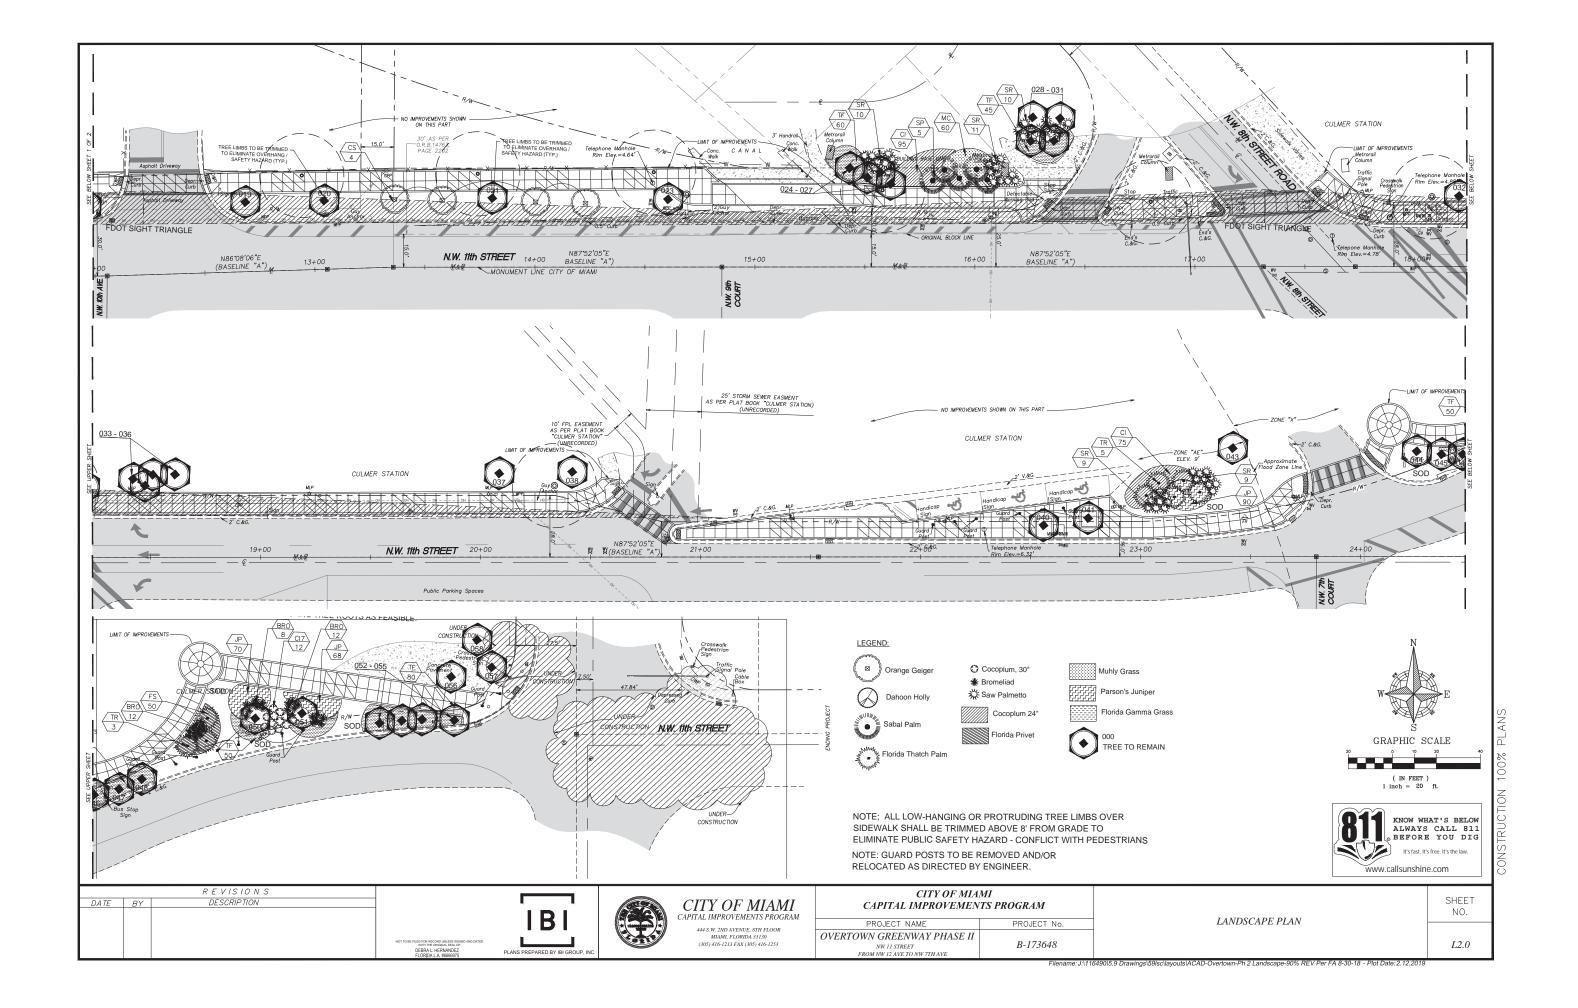

NO.

L3.0

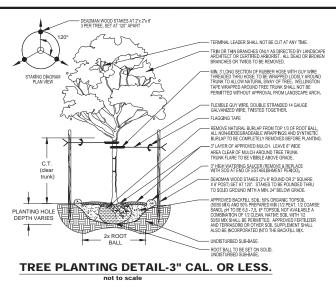


TERMINAL LEADER SHALL NOT BE CUT AT ANY TIME

WRAP TRUNK WITH BURLAP LINNER BATTENS

3" HIGH WATERING SAUCER (REMOVE & REPLACE WITH SOD AT END OF ESTABLISHMENT PERIOD).

- UNDISTURBED SUB-BASE.


TRIM OR THIN BRANCHES ONLY AS DIRECTED BY LANDSCAPE ARCHITECT OR CERTIFIED ARBORIST. ALL DEAD OR BROKEN BRANCHES OR TWIGS TO BE REMOVED.

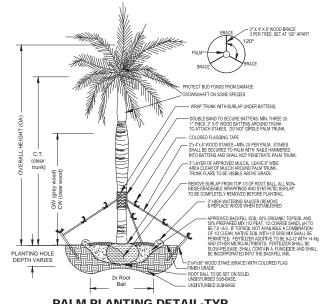

PALM PLANTING DETAIL-TYP. not to scale Ast 2. . 4 t. . 4 t. BY, THE AUTHORITY OF THE SOUTH FLORIDA FIRE PREVENTION THIS DETAIL SHALL APPEAR ON ALL LANDSCAPE PLANS AND/OR APPROVED CONSTRUCTION OR AVINASS FOR PUBLIC SAFETY REGULATIONS. SOD ONLY SOD ONLY


FIRE HYDRANT CLEAR ZONE DETAIL

PROTECT FIRE FIGHTING EQUIPMENT

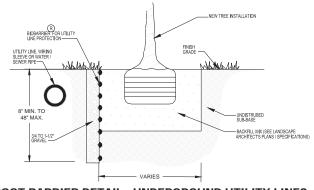


ROOT BARRIER DETAIL - UNDERGROUND UTILITY LINES

not to scale

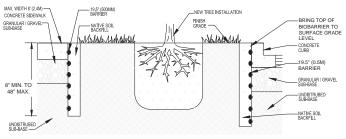

ROOT BARRIER DETAIL - PAVING / CURBING

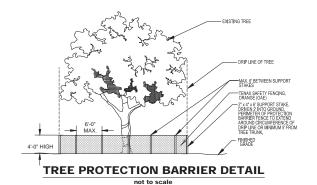

GENERAL NOTES, LANDSCAPE INSTALLATION SPECIFICATIONS

REFER TO SITE PLAN FOR SITE DATA AND UTUITIES. REFER TO ARCHITECTURAL PLANS FOR BUILDING FOOTPRINTS, ARCHITECTURAL INFORMATION AND DESIGNATION OF ELEVATIONS, REFER TO BRIGGATION PLANS FOR RECURBED MATERIALS, SPECIFICATIONS, DETAILS AND COORDINATION ITEMS. REFER TO BRIGGATION FLANS FOR RECURBED MATERIALS, SPECIFICATIONS, DETAILS AND COORDINATION ITEMS, REFER TO WATER AND SEWER PLANS FOR ADDITIONAL/DIMERGROUND AND ADDRESSED AND SOME SEWER PLANS FOR SEWER PLANS FOR ADDRESSED AND SOME SEWER PLANS FOR SEWER PLANS

PLANT MATERIALS ARE SPECIFIED FOR COMPLIANCE WITH MINIMUM CODE REQUIREMENTS AND GOVERNING AGENCY REVIEW COMMENTS AS OF THE DATE OF SUBMITTAL. SUBCONTRACTORS ARE BOUND TO THE GENERAL CONTRACTOR AND ARE TO ASSUME ALL OBLIGATIONS AND RESPONSIBILITES BY WHICH THE GENERAL CONTRACTOR IS BOUND TO THE OWNER. BOTH SHALL BE FAMILIAR WITH AND HAVE FULLY INVESTIGATED ALL LOCAL CODES AND CORDINANCES.

LANDSCAPE PROPOSALS SHALL PROVIDE UNIT COSTS AND SHALL INCLUDE: EXCAVATIONS, PLANT MATERIAL LISTED, DELIVE INSTALLATION, LANDROP, TIME'S OD, SEEDING, TOP SOIL, & PINE CRANDING, SOIL BACKFILLS SOIL SPIELEBEATS, FOLIAR SHAR FERTILIZERS, GUYING AND STAKING, REQUIRED PRIVAING, CLEAN-UP, WATERING AND ALL TAXES AND FEES NECESSARY TO SUCCESSILLY ESTABLISH THE PROPOSED LANDSCAPE AND ECOLOGICAL COMMUNITIES.

THE CONTRACTOR/BIDDER SHALL HAVE CAREFULLY READ AND FULLY UNDERSTAND ALL DRAWINGS (TREE PRESERVATION, LANDSCAPE AND RIREGATION, PLUS RELATED ENGINEERING AND ARCHITECTURAL), DETAILS, SPECIFICATIONS AND NOTES OF SUCH AND SCHOOL AND ARCHITECTURAL DETAILS SPECIFICATIONS. AND NOTES OF SUCH AND ARCHITECTURAL DRAWN THE COMMENT AND ARCHITECTURAL DRAWN THE COMMENT AND ARCHITECTURAL DRAWN THE COMMENTATION OF THE CHARGE CONTRACTOR OF THE CHARGE COMMENT AND ARCHITECTURAL DRAWN THE COMMENTATION WITH RELATED TRADES, PROPERLY SEQUENCING WORK AND OFFICIAL ADDRAWN. SO SWORN.

2. THE CONTRACTOR SHALL CUT, CLEAR, STUMP GRIND, EXCAVATE AND REMOVE ALL EXOTIC, INVASIVE AND DESIGNATED TREES FROM THE SITE AND AREAS THAT HAVE EVIDENCE OF PREVIOUSLY EXISTING TREES AND/OR PALMS; INCLUDES REMOVING DEBRIS, LITTER AND STONES OVER 17 DIAMETER.

3. THE CONTRACTOR SHALL REFER TO ALL TIREE MANAGEMENT PLANS, DETAILS AND SPECIFICATIONS IN CONJUNCTION WITH THE STEEPPROJECT TO LOCAL AND TAG ANY AND ALL EMSTING TREES AND/OR PALMS PROPOSED FOR PRESERVATION OR RELOCATION. PLAN SELECTION OF ALL REFUERS CALL DIRECTIVES AND AS SHOWN ON THE TIREE WARAGEMENT PLANS RECARRION EAL TIREE OR PAUM SELECTION.

GENERAL NOTES, LANDSCAPE INSTALLATION SPECIFICATIONS (cont.)

4. THE CONTRACTOR IS RESPONSIBLE FOR ANY DAMAGE TO UNDERGROUND UTILITIES WHICH ARE PROPERLY MARKED OR FOR WHICH HE HAS NOT OBTAINED PROPER MARKINGS INFOUGH THE ONE CALL SYSTEM — 72 HOURS BEFORE DIGGING — CALL TOLL FREE 1 (800) MS 242-2772 OR FROM LOCAL UTILITY DEPARMENTS. ALL ELECTRICAL, OSS, TELEPHONE, FIBER OPIDES, CRELE, WATER AND SEWER SERVICES LOCATED ON—SITE, ON ADJACENT PROPERTIES WITHIN 10' AND WITHIN ADJACENT R.O.W.'S SHALL BE CLEARLY MARKED.

6. THE CONTRACTOR SHALL PROVIDE PROPER TRANSPORT AND DELIVERY OF PLANT MATERIAL. TO THE JOB SITE. PLANT MATERIAL SHALL NOT BE DROPPED, SCARED OR OTHERWISE DAMAGED AT ANY TIME. DAMAGED PLANT MATERIALS SHALL BE REJECTED BY THE OWNER OR OWNER'S REPRESENTATIVE, REMOVED AND REPLACED BY THE CONTRACTOR AT THE CONTRACTOR'S EMPOISE. ANY PLANTS OTHER THAN PL. #1 GRADE OR WITH HIDIOATIONS OF DISEASE, INSECT INFESTATION, BROKEN BRANCHES, LACK OF WATER, GROUNG OR SCRARING AT DELIVERY SHALL BE REJECTED.

7. THE CONTRACTOR SHALL PROVIDE CERTIFIED ST, AUGUSTINE "LORITAM" SOD, LINLESS OTHERWISE INDICATED, TO ALL OPEN OR DISTURBED AREAS MISBET THE PROJECT BOUNDAMES, NOT RECEIVING PLANT MATERIAL, OR OTHER FORM OF GROUNDCOVER, LUMBO, OR NON-LUMBO, THE CONTRACTOR MULL PROVIDE SOO TO ALL DAMAGED THEY AREAS, TO EDEC OF PAVEMENT AND TO THE DODG OF WATER AT ALL WATER BODIES. ALL SOO SEAMS WILL BE BUTT JOINTS WITH ADJACENT ROWS STAGEFEED AND ALL EDGE PIECES ABUTTING TIGHTLY, LEAVING NO GARS, THE CONTRACTOR SHALL REPRAY AND REPLACE ALL SOO ON ADJACENT PROPERTIES DAMAGED BY LANDSCAPE WASTALLATION WORK, AND SHALL NOTIFY THE OWNER OF THE ADJACENT PROPERTY, AND GETAIN PERMISSION TO PERFORM SOO REPLACE.

6. THE CONTRACTOR SHALL PROVIDE IMPORTED ORGANIC BACKFILL MIX AS NOTED ON THE PLANTING DETAILS WHICH WILL BE FREE OF ALL DEBRIS AND STONES OVER 1" DIAMETER. BACKFILL MIX WILL BE SANITIZED FROM HARMFILL BIOLOGICAL ORGANISMS, INCLUDING ON MANIFORM AND ANALYSICS AND EXPENSE OF THE PROPRIES SECREBIOD IN THE PRICE OF FLAM PARTIES OF THE PROPRIES OF THE

9. THE CONTRACTOR WILL PROVIDE FERTILIZER FOR ALL PLANTS UPON INSTALLATION AS SPECIFIED ON THE PLANTING DETAILS. FERTILIZER WILL BE THOROUGHLY INCORPORATED INTO THE BACKFILL MIX.

I. UNLESS OFFERING DICTATED BY CITY OR COUNTY CODE, THE CONTRACTOR SHALL LOCATE ALL TREES WITH A MATURE HEIGHT OF OVER 20" NO CLOSER THAN 15 FEET TO ANY LIGHT POLE. THE CONTRACTOR MAY FELL ADJUST POLE THE TO ANY LIGHT POLE. THE CONTRACTOR MAY FELL ADJUST POLE AND FOLE THE CONTRACTOR MAY FELL ADJUST POR SENTANTIAN OF TREES AND PAULS FOR ESTAT IT WHEN CORDINATED WITH AND CONSENT GIVEN BY THE OWNER OR OWNER'S REPRESENTATIVE. THE LANDSCAPE/JRRIGATION CONTRACTOR SHALL NOT PROCEED WITH WORK UNITED STATES AND CONTRACTOR SHALL NOT PROCEED WITH WORK UNITED STATES AND CONTRACTOR SHALL NOT PROCEED WITH WORK OWNERS OF THE OWNER OWNERS OWNERS.

12. THE CONTRACTOR SHALL INSURE THAT ALL PLANT MATERIAL LOCATED WITHIN THE SIGHT TRIANGLE DISTANCE AREAS AT ROADWA' INTERSECTIONS AND ACCESS POINTS PROVIDE AN UNOBSTRUCTED CROSS VISIBILITY AT A HORIZONTAL LEVEL BETWEEN 30" AND 8' IN HEIGHT. SEE LANDSCAPE PLANS FOR SIGHT TRIANGES.

13. THE CONTRACTOR SHALL INSURE THAT ALL TREES OR PAUMS LOCATED ADMACRAT TO ANY OVERHEAD POWER UNES BE INSTALLED IN ACCORDANCE WITH LIGHDAY POWER AND UGHT'S TROUBT THE RIGHT HALCE "GUIDELINES. ANY INSTANCES OF INSUFFICIENT SEPARATION BETWEEN TREES OR PALMS AND OVERHEAD LINES SHALL BE BROUGHT TO THE ATTENTION OF THE LANDSCAPE ARCHITECT FOR RESOLUTION BEFORE INSTALLATION.

BOTH THE TREE CANOPY AND PALM FRONDS FROM OBSTRUCTING ANY PORTION OF TRAFFE SIGNS. THE LANDSCAPE/RERGATION CONTRACTOR SHALL NOT PROCEED WITH MORK UNTIL TRAFFIC SIGNAGE AND GUARDRAILS ARE COMPLETELY STAKED-OUT TO CONFIRM SEPARATION AND CLEAR VISIBILITY OF SIGNS.

THE CONTRACTOR WILL PROVIDE "WILT-PRUF" OR OTHER APPROVED SURFACANT TO BE SPRAYED ON ALL PROPOSED TREES AND AS IN AREAS OF SUSTAINED WINDS OF MORE THAIN TO KNOTS AND ALL COASTAL AREAS, ACCORDING TO THE MANUFACTURER'S MEMERIAGINGS, TO PREVENT WINDSHIPM AND EXCESSIVE WATER LOSS THROUGH TRANSPRIATION.

16. THE CONTRACTOR SHALL INTERIM SUPPLEMENTAL IRRIGATION, I.E. RECULAR THOROUGH, DEEP WATERING, TO ALL INSTALLED PLANT MATERIAL UNTIL SUCH TIME AS THE CITY'S OR COUNTY'S FINAL INSPECTION, ACCEPTANCE AND PERMIT CLOSE-OUT. IN THE EVENT THAT AN IRRIGATION SYSTEM IS NOT PROVIDED, THE CITY SHALL BE REPORTISELE OF PROVIDING SUPPLEMENTAL WATER TO LANDSCAPING AS RECEDED TO MAINTAIN REASONABLE HEALTH, AND DURING TIMES OF EXTREME DROUGHT.

17. THE CONTRACTOR SHALL PROVIDE ROOT BARRIER AT A VERTICAL DEPTH OF 18" MIN. TO 48" MAX. FOR ANY SHADE TREES OR LARGE PALMS WHICH ARE INSTALLED AS FOLLOWS: LESS THAN FIVE (5) FEET FROM ADJACENT ASPHALT OR CONCRETE PAYMENT, WINH CURRED PARKING INSLANDS LESS THAN MINE (6) FEET INTERFOR WIDTH OR WITHIN SX (6) FEET PROXIMITY TO LUDGERGOUND UTILITY OR INFRASTRUCTURE. ROOT BARRIER SHALL BE "BOGGARRIER", "DEEPROOT PARTINERS, LP", OR APPROVED EQUAL INSTALLED FOR MANUFACTURER'S RECOMMENDATIONS. SEE DETAIL, THIS PAGE.

18. THE CONTRACTOR SHALL PROVIDE GUYING OR STAKING TO ALL TREES AND PALMS ACCORDING TO THE DETAILS SHOWN IN THIS SHEET, GUYING AND STAKING REQUIREMENTS MIL, BE STRICTLY ENFORCED THROUGHOUT CONSTRUCTION AND THE WARRANTY PERIOD. ALL TREES AND PALMS WILL BET FULWING VERTIL AT TIME OF INSPECTION. ALL GLYING OR STAKING SHALL BE REMOVED AFTER NINE MONTHS OR AT THE END OF HURRICANE SEASON, WHICHEVER IS GREATER.

19. THE CONTRACTOR SHALL PROVIDE APPROVED MULCH TO ALL TREES, SHRUBS AND PLANT BEDS. CONTRACTOR SHALL INSTALL MULCH AT A DEPTH OF 3", MIN., AND MAINTAIN A 46" DIAMETER RING AROUND FREE STANDING TREES ALL TREES SHALL HAVE A 6" WIDE RING CLEAR OF WILLCH AROUND THE TIER TRINK. DO, NOT MULCH ANDIAL FLOWER BEDS. APPROVED WILLCH WILL HOW. DO NOT WILLCH ANDIAL FLOWER BEDS. APPROVED WILLCH WILL HOW. ON COMPRESS STERRIZED NATURAL GELLUGSE FRAGMENTS AS RECOMMENDED BY SEWID XERISCAPE PLANT GUIDE II AND WHICH COMPRESS WITH AL APPLICABLE LAND DEVELOPMENT, COMING AND BUILDING CODES.

20. THE CONTRACTOR WILL WITH ALL QUOTITIONS OF PROPOGAL/AUSEBLEANS, PROVIDE A BRONG LETTER AND WRITTEN REPUNCTIONS WERRANTY FOR ALL INSTALLED HANN HANDEN FIRM HAN ENDERFORM, AND ACCEPTANCE BY THE WINTER WARRANTY SHALL BE FOR 1 YEAR FOR ALL TREES AND PALMS, 120 DAYS FOR SHRUBS. WHERE INCREMENTAL COMPLETION CRETIFICATION FOR CSS ARE ISSUED, CONTRACTOR HAY PETITION OWNER & AUTHORITY OF ACCEPT WORK IN CORRESPONDING INCREMENTAL SECTIONS. ALL PLANT MATERIAL BE THE RESULT OF AN "ACCT OF GOO". "ACCT OF GOO"."

DEATH TO PLANT MATERIAL BE THE RESULT OF AN "ACCT OF GOO"."

"ACCT OF GOO!" AND THE PROPERTY OF THE STATE OF THE PROPERTY OF THE PLANT WARRANTY SHOULD IT BE CONFIRMED THAT DAMAGE OR DEATH TO PLANT MATERIAL BE THE RESULT OF AN "ACCT OF GOO"."

23. THE CONTRACTOR ACCEPTS THE LANDSCAPE PLAN, PLANT LIST, QUANTITIES AND SPECIFICATIONS CONTAINED HEREIN AS REQUIRED FOR SITE PLAN APPROVIAL, ZONNO AND LANDSCAPE PERMITTING. FINAL ARCHITECTURE, ENGINEERING IN PLANS AND UTILITY PROVIDERS AND CONTRACTOR SHALL REPORT IN WRITING ANY AND ALL DESIGN CONFLICTS TO THE LANDSCAPE ARCHITECT FOR RESOLUTION, AND AS REQUIRED BY CODE.

SIGNATURE OF CONTRACTOR/BIDDER

COMPANY NAME. ADDRESS & PHONE


CONTRACTOR AND/OR LANDSCAPE & IRRIGATION PROFESSIONAL MUST HAVE THIS <u>SIGNED</u> DRAWING IN THE BUILDING PERMIT SET OF PLANS AND THE JOB SITE SET OF PLANS AT ALL TIMES.

KNOW WHAT'S BELOW ALWAYS CALL 811 BEFORE YOU DIG It's fast. It's free. It's the law www.callsunshine.com

2" X 4" X 8" WOOD BRACE 3 PER TREE, SET AT 120" APART

SPREAD

BRACING DIAGRAI PLAN VIEW

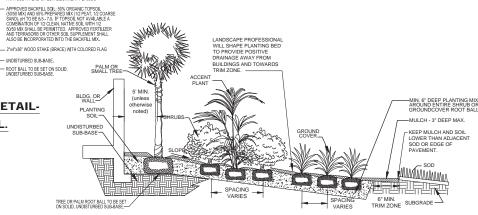

7'-6" 7'-6"

PLANTING BED - SHRUB INSTALLATION DETAIL - CROSS-SECTION

REVISIONS DESCRIPTION DATE BY


LARGE TREE PLANTING DETAIL-


GREATER THAN 3" CAL.






CITY OF MIAMI CAPITAL IMPROVEMENTS PROGRAM	
PROJECT NAME	PROJECT No.
OVERTOWN GREENWAY PHASE II	B-173648

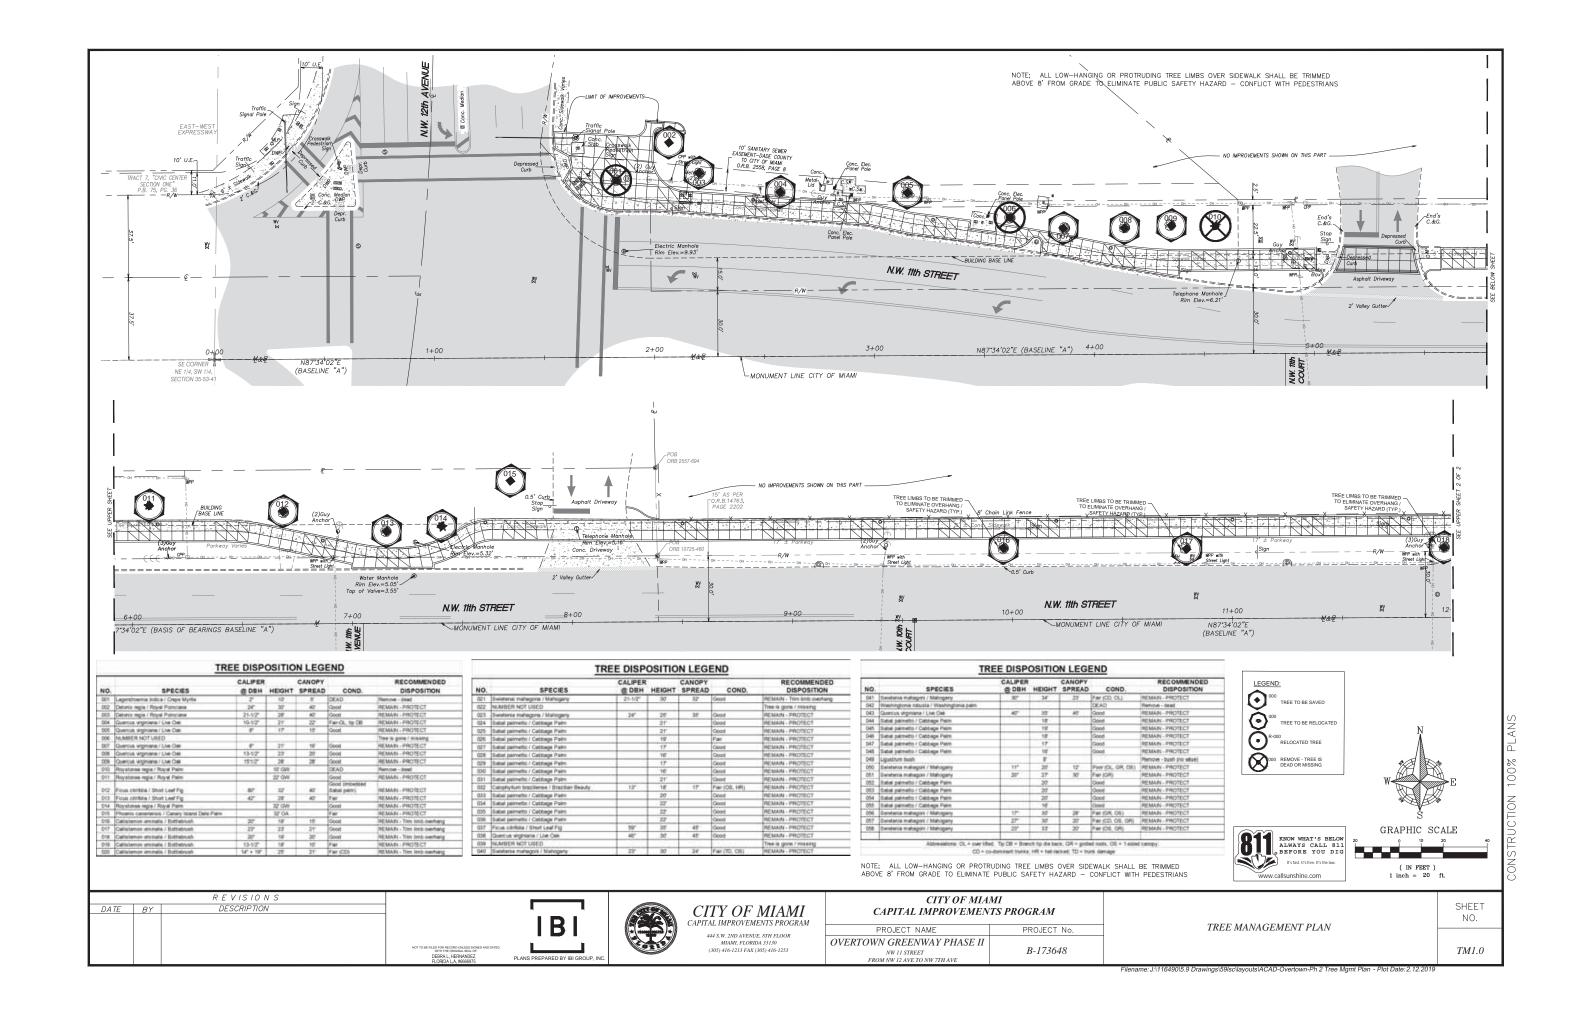

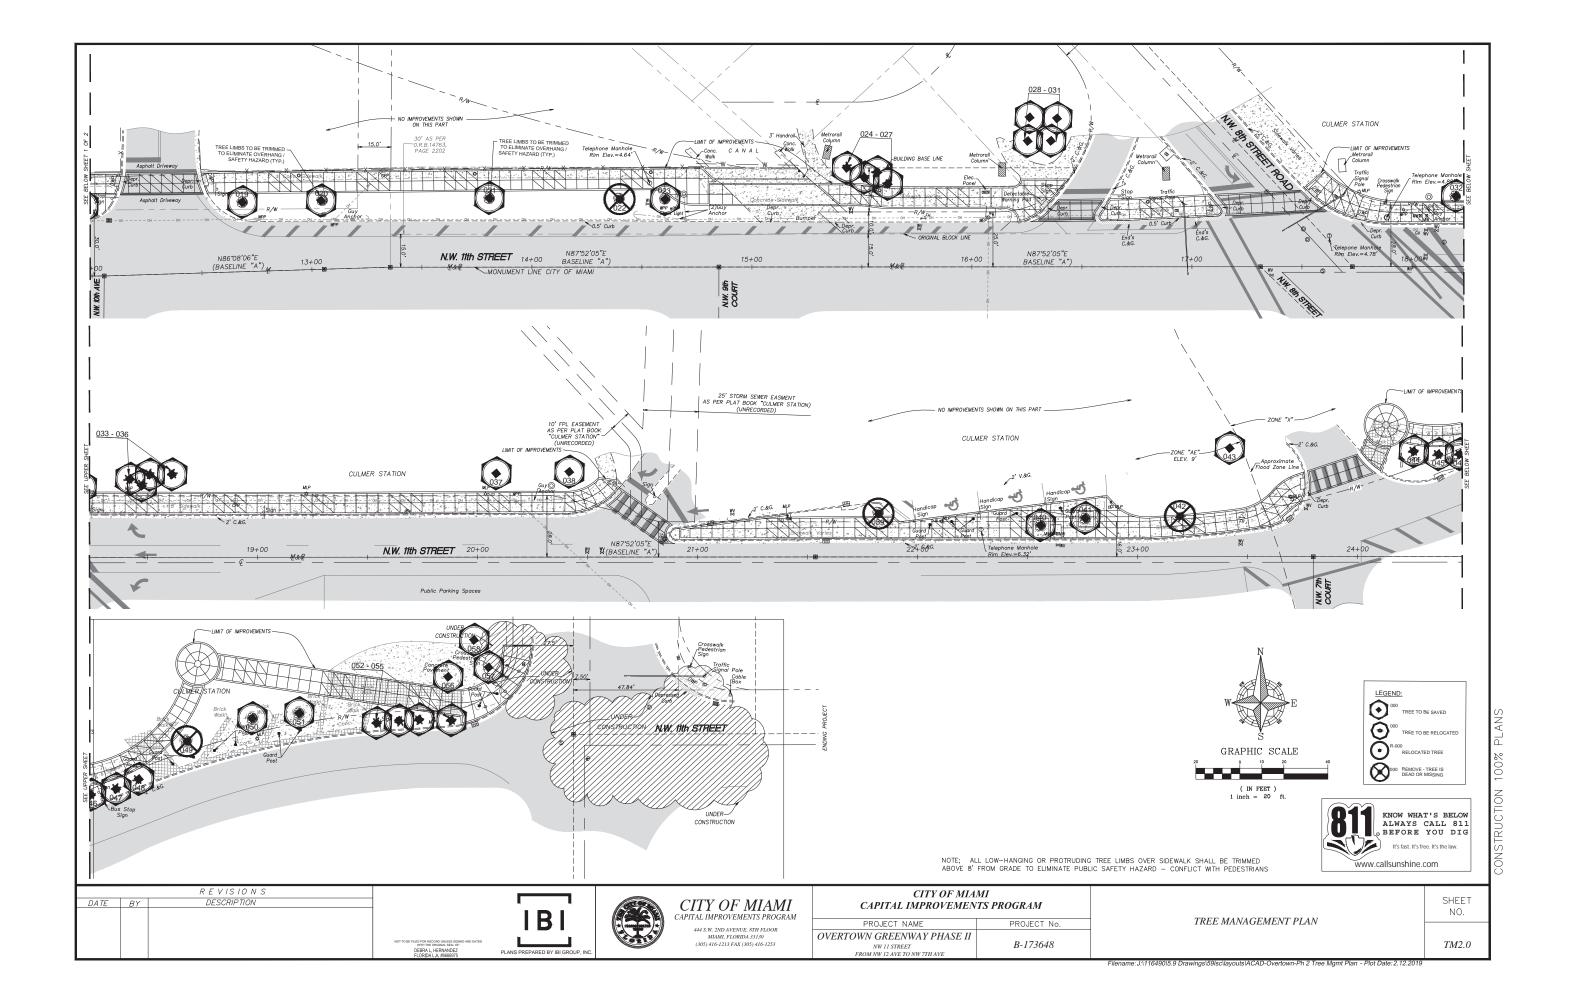

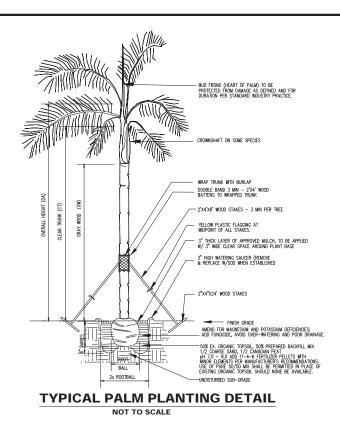


- DO NOT CUT LEADER PAINT ALL AUTHORIZED CUTS OVER 1/2" DIAMETER WITH APPROVED TREE PAINT. YELLOW PLASTIC FLAGGING AT MIDPOINT OF ALL GUY STRAPS. MUST VALUE OF THE PROPERTY OF - 3" THICK LAYER OF APPROVED MULCH, TO BE APPLIED W/ 3" WIDE CLEAR SPACE AROUND PLANT BASE 3" HIGH WATERING SAUCER (REMOVE & REPLACE W/SOD AT END OF ESTABLISHMENT PERIOD. WOOD STAKE OF SUITABLE SIZE & LENGTH TO STABILIZE TREE, MIN. 2" X 4" X 24". FINISH GRADE REMOVE BURLAP FROM TOP 1/3 OF ROOT BALL. SOR EX. ORGANIC TOPSOIL, 50X PREPARED BACKFILL MIX (1/3 MUOK, 1/3 CANADIAN PEAT, 1/3 FIRE SAND) ph 8.5 – 7.5, NOT 1-3 FERTILIZER FELLETS WITH MINOR ELEMENTS FER MANUFACTORERS RECOMMENDATIONS. USE OF PURE 30/50 MIX SHALL BE PERMITTED IN PLACE EXISTING ORGANIC TOPSOIL SHOULD MONE BE AVAILABLE. -TERRASORB INCORPORATED INTO BACKFILL ACCORDING TO MANUFACTURERS RECOMMENDATIONS ROOT BALL 2x ROOT BALL

GENERAL:

The CONTRACTOR will remove all existing exotic tree species located within the project boundaries when exempt from local county removal permits and required for removal. Such exotic species are not included for calculations of tree caliper/canopy replacement. Exotic species shall be as determined by the US—EPA; Florida Department of Environmental Protection; and the Florida EPPC (Florida Exotic Pest Plant Council) Category 1. Statutory law prevails over local ordinance.

GENERAL TREE MANAGEMENT NOTES AND SPECIFICATIONS TREE PROTECTION, RELOCATION & REMOVAL NOTES

- 1. The Tree Management Plan, sheet TM-1.0 may be based on or contain elements or features from the certified "Property and Tree Survey' prepared by a Florida registered surveyor. Coordinates of tree locations, identification of species, description of size and health of same is conditional on the accuracy and completeness of survey data. The Tree Management Plan does not warrant the accurate location of trees in relation to proposed development
- 2. The GENERAL CONTRACTOR is responsible for ensuring that the on-site tree relocation activity or management of trees
- 3. The GENERAL CONTRACTOR shall protect every tree to be preserved/saved by installing a barrier around the individual trees, groups of trees or entire preserve area in accordance with the tree protection detail on this sheet. The barrier shall be a minimum of five feet (5') radius from the tree trunk or following the drip—line (edge of tree canopy), whichever is greater. The barriers shall be placed prior to clearing, shall remain in place and in good condition for the duration of construction AND until receipt of certificate of occupancy from the permitting agency.
- 4. The GENERAL CONTRACTOR is responsible to prevent spillage into protected trees of concrete, mortar, slurry, contaminated water and/or noxious chemicals from construction activity and is responsible for daily clean—up of debris inside and at the perimeter of the tree protection barriers. The GENERAL CONTRACTOR shall provide financial compensation to the Owner or jurisdiction for accidental damage to protected trees and/or for careless damage to protected trees by their crews, subcontractors and trades. Compensation to the Owner will be calculated from the ISA tree value provided by a Certified Arborist or the City or County of recorded jurisdiction, plus legal fees, professional time and expenses incurred to recover damages.
- The LANDSCAPE CONTRACTOR will provide backfill mix as noted on the planting details. Backfill mix will be free of al debris & stones over 1" diameter and sanitized of nematodes & parasites. Alternative backfill material as noted in details on this page may be used. Native sand or sandy soil may be used for backfilling palms only, and must be approved by Landscape Architect or Certified Arborist prior to installation.
- All plant material proposed in sandy soils or fast draining sites will receive 'Terrasorb' or other approved soil supplement (humectant and hygroscopic compounds), thoroughly incorporated into the backfill mix according to the manufacturer's recommendations and as noted on details, this page.
- 7. All trees and palms will be guyed or staked according to the details as shown, or by alternative methods as required by the jurisdictional city or county. Guying & staking requirements will be strictly enforced. All trees and palms will be plumb in all directions at time of inspection.
- 8. All transplanted trees and palms will receive mulch approved by the Landscape Architect and which complies with all applicable land development, zoning and building codes. Depth of mulch will be 3" at time of inspection. A 36" ring of mulch, measured radially from trunk center, with a 6" clear zone of mulch around the tree or palm base shall be provided and maintained around all trees and palms.
- 9. No fertilizer other than specified in details, this page, shall be applied to any tree or palm at time of transplant. Additional fertilization shall be applied after 60 to 90 days from date of transplant.
- 10. All trees and palms in areas of sustained winds of more than 10 knots, and all coastal areas, will be sprayed with Wilt—Pruf' or other approved surfactant, according to the manufacturer's recommendations, to prevent windburn and excessive

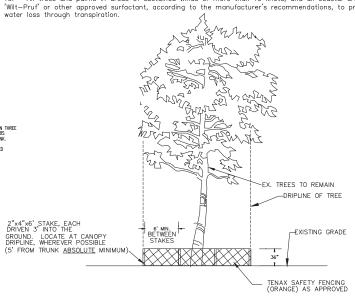

TREE PROTECTION BARRIER NOT TO SCALE



- 11. The LANDSCAPE CONTRACTOR is responsible for any damage to underground work which is properly marked or for which he has not obtained proper marking through the ONE CALL SYSTEM — 48 HOURS BEFORE DIGGING — CALL TOLL FREE 1 (800) 432—4770, markings from local utility departments, or from the General Contractor.
- 12. The LANDSCAPE CONTRACTOR will provide written care instructions for the first year to the Owner's representative at the time of the substantial completion inspection and prior to final acceptance.
- 13. The Superintendent or Crew Chief on job site will have a minimum of two (2) years experience.

TREE RELOCATION PROCESS

The tree relocation contractor shall be licensed and insured per State or County regulations, and shall be approved by the Certified Arborist of Record for the project, or Landscape Architect prior to acceptance of contract.

ANSI PREPARATION, EQUIPMENT, IRRIGATION & BARRIER GUIDELINES

The General Contractor and Tree Professional shall refer to and comply with the <u>AMERICAN NATIONAL STANDARDS INSTITUTE</u> (<u>ANSI</u>) <u>specification A-300</u> for all tree relocation work as a condition of license approval from Broward County - Dept. of Preservation and Environmental Protection (BC-DPEP).

TREE PREPARATION, FERTILIZATION AND PEST CONTROL

Tree preparation to be performed three weeks prior to first stage of root pruning schedule. Application of water solubile tank mix applied through ground drench. Fertilizer to include supplemental mycorrhizae and macro/micro nutrient treatment in mix. During first application on appropriate systemic insecticide also shall be applied to inhibit infestation of Borers or Beetles due to stressful conditions of relocation process.

Additional application of fertilization treatment shall be performed at end of first week of root pruning schedule and at end of third phase of root pruning schedule

A second application of systemic insecticide shall be applied in same manner at third phase of root pruning schedule.

CANOPY CLEANING

Remove dead, diseased and damaged tree branches or palm fronds. Lesser tree branches that rub on major branches. hernove dead, alseased and admigled reb brainities or paint include. Sees the brainities that the of intopio brainities, branches with V—crotches or included bark and other visibly weak branches may be removed if necessary to the health and survival of the tree. All debris shall be disposed of in a manner that will comply with all applicable land development, zoning and building codes, either by hauling or chipping.

Prune palm roots for anticipated root ball of 18" radius (36" diameter) minimum. Prune tree roots for anticipated root ball of 24" radius (48" diameter) minimum for all trees less than 6" caliper at DBH. Root ball size for trees greater than 6" caliper measured at DBH will be determined based on 8" minimum of root ball diameter for each inch of trunk diameter

At no time shall the use of an axe to cut roots be accepted. All root cuts shall be performed either by hand pruning shears or sharpened shovel for smaller roots, or by saw for larger roots.

TREES W/ 8" CALIPER OR LESS

Root pruning schedule for trees w/ 8" coliper or less: Prune 35% of root ball at week one. Prune additional 35% of root ball at week six; then remaining 30% of root ball to be pruned at week twelve. Tree root system will be hardened off and eligible for final dig of root system, root ball containment and transport at end of Week eighteen (six weeks from final root

TREES W/ 8" CALIPER OR GREATER

Root pruning schedule for trees w/ 8" coliper or greater: Prune 25% of root ball at week one. Prune additional 25% of root ball at week six; prune additional 25% of root ball at week six; prune additional 25% of root ball at week twelve, then remaining 25% of root ball to be pruned at week eighteen. Tree root system will be hardened off and eligible for final dig of root system, root ball containment and transport at end of Week twenty-four (six weeks from final root prune). Deviation from this schedule and/or option to prepare trees for transport after week eighteen shall be approved by the Owner or Certified Arborist prior to commencement of any relocation activities.

For trees 18" caliper or greater, minimum hardening time from root pruning prior to relocation shall be 12 weeks.

The preferred method of irrigation shall be an overhead mist system. This method is effective in alleviateing loss of canopy and insure sufficient moisture to root ball. Schedule for irrigation shall be daily and shall take place between the hours of 5:00 a.m. and 10:00 a.m. Any deviation from this method, shall be presented in writing to the Owner or Certified Arborist for approval prior to commencement of any root pruning activities.

VERIFICATION

Root ball on each tree shall be inspected by Certified Arborist prior to scheduling of final relocation to determine presence of active and viable new root growth.

TREE AND PALM MOVING

Excavate proposed locations an adequate depth to accommodate the root ball of the identified tree or palm.

Preparation of root ball prior to commencement of relocation shall be to cut the botom roots of the tree. This shall be performed by mechanical means and physical cuts of the roots only and at no time shall the root ball be pulled from the

The root ball shall be contained by any means necessary to preserve the integrity of the root ball for it to remain intact. The method of containment shall be determined by the Certified Arborist and shall be on an individual basis for each tree or

The method of transport for tree relocation shall be determined by the Certified Arborist, and shall be decided on a case by case basis dependent upon actual site conditions. Prior to commencement of tree relocation activities, the Tree Relocation Contractor may submit, in writing, a method of transport to the Owner or Certified Arborist for evaluation and approval.

REVISIONS DESCRIPTION DATE BY

TYPICAL TREE PLANTING DETAIL

NOT TO SCALE

IBI



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CITY OF MIAMI CAPITAL IMPROVEMENTS PROGRAM PROJECT NAME PROJECT No OVERTOWN GREENWAY PHASE II B-173648

TREE MANAGEMENT DETAILS AND SPECIFICATIONS

SHFFT NO.

TM3.0