

CITY OF MIAMI - LIFE QUEST RENOVATIONS FOR 1075 N.E. 149th STREET

City of Miami Department of Community Development BID SET - January 9th 2017

Miami-Dade County - Alteration Level 2

Owner's Representative:
Dollila Pinkhasov
Contract Compliance Analyst
City of Miami

Mayor Tomas P. Regalado

> Chairman Leon Hardemon

<u>Vice-Chairman</u> **Ken Russell**

Commissioner


Frank Carollo

Commissioner
Wifredo (Willy) Gort

Commissioner Francis Suarez

City Manager

Daniel J. Alfonso

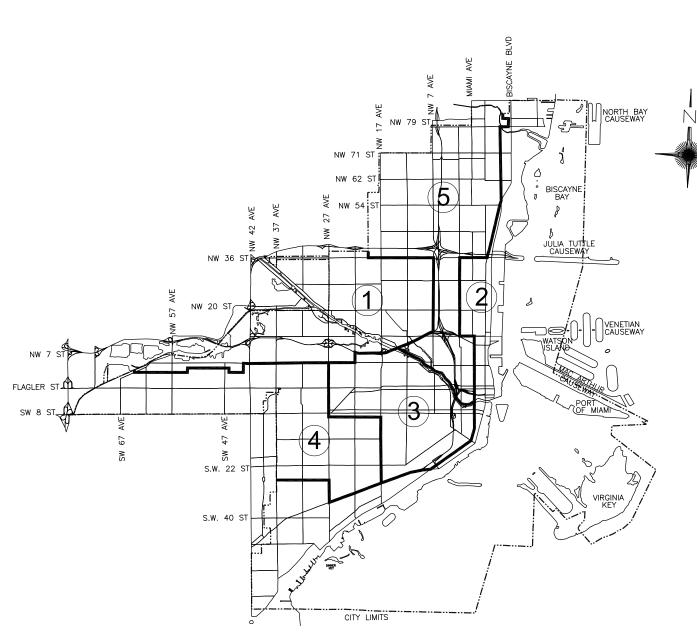

NE-150ts I'St NE-450th-St NE-1450th-St

LOCATION MAP

N.T.S.

1075 N.E. 149th Street



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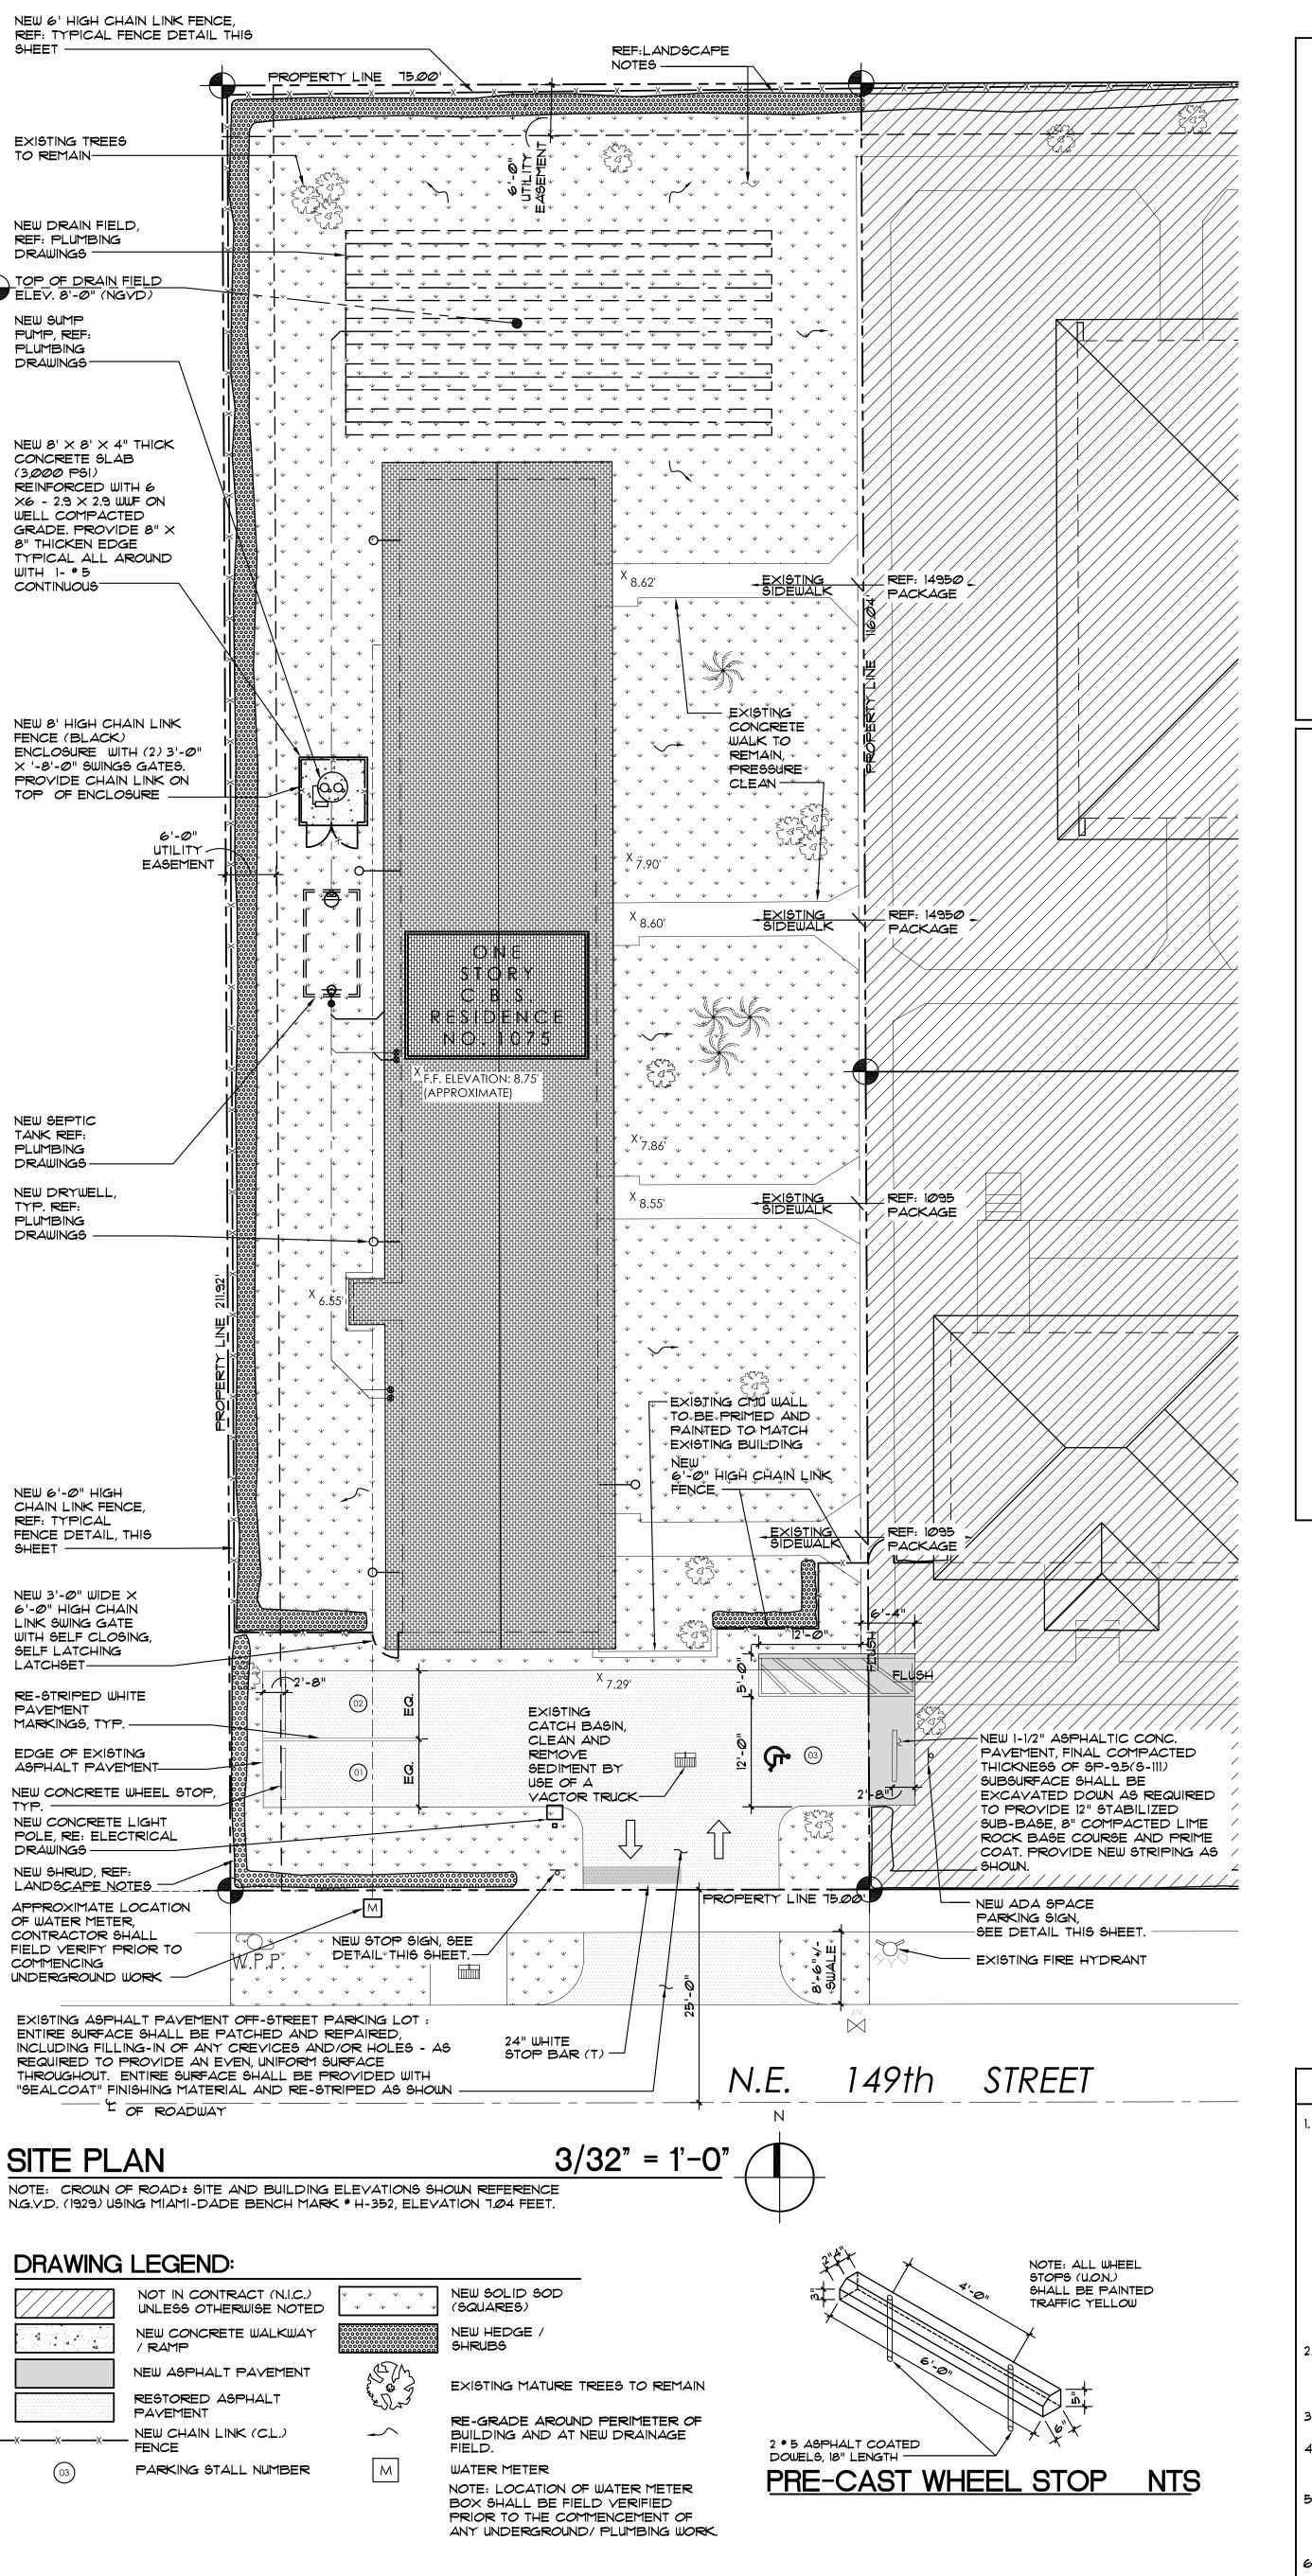
MECHANICAL, ELECTRICAL, PLUMBING ENGINEER:


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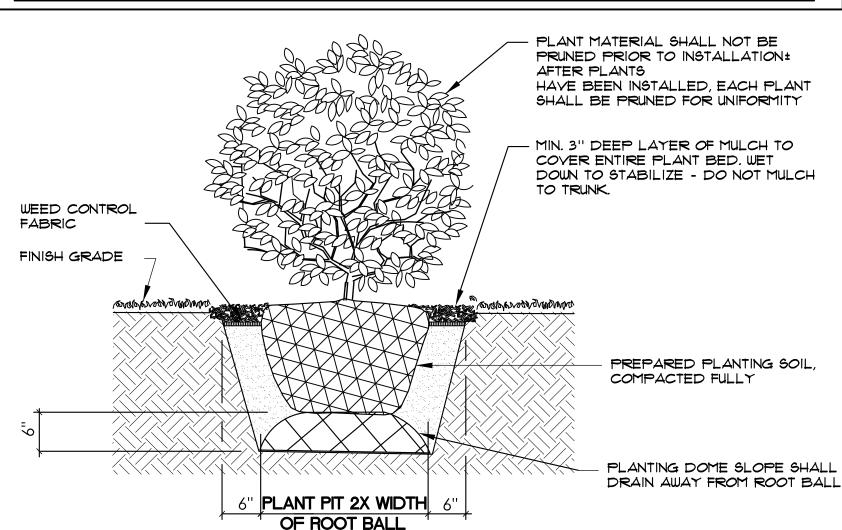




HANDICAP SIGN SHALL COMPLY WITH FLORIDA ACCESSIBILITY CODE FOR BUILDING CONSTRUCTION, LATEST EDITION AND WITH THE LATEST REQUIREMENTS OF GOVERNMENT BODIES HAVING JURISDICTION. ALL SIGNS SHALL COMPLY WITH MIAMI DADE PUBLIC WORKS STANDARD DETAILS "R 18.1"

REFERS TO NEW CHAIN LINK (C/L) FENCE AS DETAILED BELOW AND AS SHOWN IN THE SITE PLAN. EXISTING CHAIN LINK FENCE SHALL BE COMPLETELY REMOVED. SUBMIT SHOP DRAWINGS AND POWDER COATED COLOR SAMPLE PROVIDE ROUND FOR ARCHITECT'S APPROVAL FENCE DOME CAP-10'-0" 2-7/8" O.D. × Ø.11Ø MAX. TYPICAL TERMINAL POST, TYP. AT ENDS, CORNERS AND GALY. STEEL LINE POSTS, 2-3/8" GATES. -O.D. × Ø.11Ø -FENCE FABRIC, SEE FABIC NOTES 1/4" × 3/4" FLAT STRETCHER BAR -TOP, INTERMEDIATE AND BOTTOM RAILS -NEW CROSS-RAIL W/ TENSION WIRE AT ENDS CORNERS AND GATES ---FINISH GRADE CONCRETE FOUNDATION. SLOPE TOP OF CONCRETE FOR DRAINAGE 18" DIA. (X) 3'-6" CONCRETE FOOTING 12" DIA. (X) 3'-6" (TYP. AT TERMINAL CONC. FOOTING (TYP. AT LINE POST) -1. FENCE SHALL BE 2" (BLACK) FABRIC VINYL EXTRUDED 8 GUAGE WITH KNUCKLE DOWN AT TOP AND BOTTOM. 2. ALL FRAMEWORK AND COMPONENTS SHALL BE (BLACK) POWDER COATED. 3. PEDESTRIAN GATES SHALL HAVE (BLACK) FORK LATCHES. REFERENCE SITE PLAN FOR OF LOCATION OF PEDESTRIAN

TYPICAL FENCE DETAIL

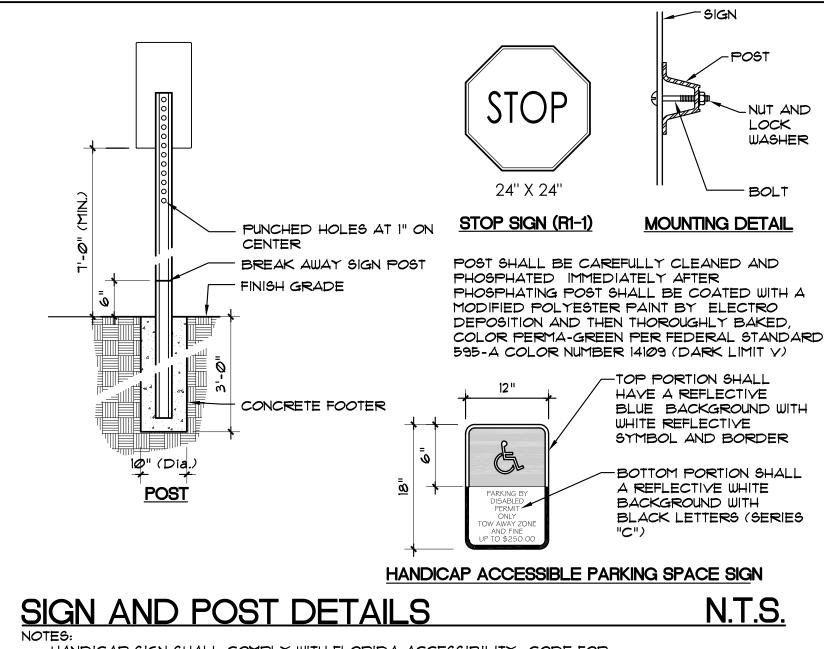

TYPICAL SHRUB INSTALLATION

LANDSCAPE NOTES

ALL PERVIOUS SURFACES (WITHIN PROPERTY LINES) SHALL 7. NEW HEDGE:
BE CLEARED OF ALL DELETERIOUS MATERIAL, PROVIDE COCOPLUM HEDGE, 3 GALLON (24" INCLUDING ALL SOD, WEEDS, ROCK MATERIAL - NOT SUITABLE FOR INSTALLATION OF NEW SOLID SOD (SQUARES) AND SHRUBS. ENTIRE LOT SHALL BE GRADED AS REQUIRED TO PROVIDE AN EVEN, UNIFORM SURFACE WHICH SHALL SLOPE AWAY FROM BUILDING. FOR CONDITION OF SOD AND SHRUBS/HEDGES THROUGHOUT THE CONSTRUCTION PHASE AND SHALL WATER ALL SODDED AND PLANTED AREAS AS NECESSARY TO ENSURE ALL ARE THRIVING, UP TO ISSUANCE OF SUBSTANTIAL COMPLETION. ALL LANDSCAPE WORK SHALL BE WARRANTED FOR

PERIOD OF ONE YEAR FROM SUBSTANTIAL COMPLETION. ALL PLANT MATERIAL SHALL BE GRADED FLORIDA *1 OR BETTER, AS DEFINED IN THE GRADES AND STANDARDS FOR NURSERY PLANTS, PART I AND II, BY THE STATE OF FLORIDA, DEPARTMENT OF AGRICULTURE.

ALL LANDSCAPE MATERIAL SHALL COMPLY WITH COUNTY CITY OR LOCAL ORDINANCES. YERIFY THE EXISTENCE OF UNDERGROUND UTILITIES WITH OWNER'S REPRESENTATIVE PRIOR TO THE INSTALLATION OF ANY PLANT MATERIAL.

ALL (EXISTING) TREES AND NEW HEDGE / SHRUBS SHALL RECEIVE A 3" DEEP LAYER OF SHREDDED EUCALYPTUS MULCH. PROVIDE A 24" WIDE STRIP OF SHREDDED EUCALYPTUS MULCH BETWEEN SOD AND HEDGE / SHRUBS. 5. ALL SHRUBS SHALL BE A MINIMUM OF 18" TALL AT TIME OF INSTALLATION.

(x) 24") AT 2' ON CENTER, AS SHOWN. REFER TO LANDSCAPE NOTES AND INSTALLATION DETAIL THIS SHEET. NEW PLANTING: ALL PERVIOUS SURFACES (WITHIN PROPERTY LINES) SHALL BE CLEARED OF ALL

DELETERIOUS MATERIAL, INCLUDING ALL SOD, WEEDS, ROCK AND MATERIAL(S) - NOT SUITABLE FOR INSTALLATION OF NEW SOLID SOD (SQUARES) AND SHRUBS. ENTIRE LOT SHALL BE GRADED AS REQUIRED TO PROVIDE AN EVEN, UNIFORM SURFACE WHICH SHALL SLOPE AWAY FROM BUILDING. ENTIRE LOT / PROPERTY SHALL BE PROVIDED WITH NEW ST. AUGUSTINE SOLID SOD AS PER LANDSCAPE NOTES THIS SHEET.

PROVIDE 3" (DEEP) TOPSOIL MIX FOR ALL SODDED AREAS CONSISTING OF 80% SAND AND 20% MUCK THOROUGHLY MIXED BY A COMMERCIAL SHREDDER. MIXTURE SHALL BE FREE OF ROCKS, ROOTS BRANCHES AND OTHER SIMILAR MATTER. ALL SITE AREAS NOT COVERED BY BUILDING. PAYING, SIDEWALKS, AND HEDGES / SHRUBS ARE TO BE SODDED.

10. SOLID SOD SHALL BE ST. AUGUSTINE

SCOPE OF WORK

SCOPE OF WORK CONSISTS OF THE COMPLETE DEMOLITION AND REMOVAL OF ALL EXISTING INTERIOR COMPONENTS AND SELECTED EXTERIOR COMPONENTS INCLUDING, BUT NOT LIMITED TO, ALL INTERIOR FRAME PARTITIONS, FURRING, ALL GYPSUM WALLBOARD CLADDING THROUGHOUT ALL NTERIOR SPACES - WALL AND CEILINGS, ALL TRIM, ALL CABINETWORK, ALL DOORS AND FRAMES (INTERIOR AND EXTERIOR) AND ALL WINDOWS. EXTERIOR DEMOLITION AND REMOVAL INCLUDES, BUT IS NOT LIMITED TO, SHINGLE ROOF SYSTEM, INCLUDING TRIM, AND ALL FRAMING. SELECTED SITE DEMOLITION TASKS ARE IDENTIFIED IN THE DRAWINGS. ADDITIONALLY ALL PLUMBING FIXTURES, INCLUDING ALL ACCESSORIES AND TRIM, SHALL BE COMPLETELY REMOVED.

NEW CONSTRUCTION CONSISTS OF MIAMI-DADE COUNTY ALTERATION LEVEL 2 NEW IMPACT RESISTANT WINDOWS AND DOORS, NEW RAILING, NEW GYPSUM WALLEBOARD FRAFIELIPER PHIDIS VAND LEYFERM BALLEBOARD FOR STANE AT CEILINGS AND EXTERIOR MASONRY WALLS. NEW INTERIOR WORK ALSO INCLUDES ALL NEW CABINETWORK, DOORS AND FRAMES, TRIM AND ALL FINISHES. NEW SITE WORK INCLUDES CLEARING OF EXISTING PERVIOUS/SODDED AREAS, PRIVACY HEDGES AT PERIMETER AND NEW CHAIN-LINK FENCE WITH

COMPLETE (DEMOLITION AND NEW WORK) MECHANICAL, ELECTRICAL AND PLUMBING (MEP) SCOPE IS IDENTIFIED IN THE CONSTRUCTION DOCUMENTS FOR THOSE DISCIPLINES.

SAID GENERAL NOTES MAY NOT FULLY DESCRIBE ALL OF THE REQUIREMENTS FOR AN ITEM. THEREFORE, THE CONTRACTOR SHALL READ AND VERIFY THE CONTRACT DOCUMENTS, INCLUDING BUT NOT LIMITED TO THE PLANS, SPECIFICATIONS, GENERAL TERMS AND CONDITIONS, AND THE SUPPLEMENTAL TERMS AND CONDITIONS, TO FULLY UNDERSTAND AND COMPLY WITH ALL THE REQUIREMENTS THEREIN. THE CONTRACTOR IS RESPONSIBLE FOR REMOVING ALL UTILITY MARKINGS ONCE THE WORK IS COMPLETED. CONTRACTOR SHALL USE SPECIAL CARE WHEN REMOVING THE UTILITY MARKINGS. THE REMOVAL METHOD NEEDS TO BE SUCH THAT IT DOES NOT DAMAGE THE SURFACES OF THE EXISTING WORK ALREADY IN PLACE . IF WATER-BLASTING OLDER ASPHALT PAVEMENT, CARE NEEDS TO BETAKEN TO NOT DISCOLOR THE ASPHALT OR PLISH THE AGGREGATE. IF THE REMOVALS ARE ON OLDER CONCRETE SURFACES, THE ENTIRE SURFACEOF A PANEL OR SECTION NEEDS TO BE BLASTED TOSHOW UNIFORM COLOR THROUGHOUT THAT SAME PANEL OR SECTION. IN ANY CASE (ASPHALT OR CONCRETE SURFACE), THE METHOD NEEDS TO BE SUCH THAT A SLICK SURFACE IS NOT LEFT BEHIND. FINAL PAYMENT TO THE CONTRACOTR MAY BE WITHHELD UNITL THE UTILITY MARKS ARE PROPERLY REMOVED.

GENERAL NOTES ON THE PROJECT PLANS AND DRAWINGS ARE SOLELY TO AID AND ASSIST THE CONTRACTOR WITH THE FIELD OPERATIONS FOR THE PROJECT

THE GENERAL NOTES AND CONSTRUCTION DOCUMENTS HEREWITH SHALL APPLY TO THE WORK OF THIS PROJECT, AND SHALL BE CAREFULLY REVIEWED BY THE CONTRACTOR AND ALL HIS SUBCONTRACTORS. THE CONTRACTOR SHALL COORDINATE EACH OF THE SUBCONTRACTORS' WORK WITH OTHER SUBCONTRACTORS' WORK ASSOCIATED WITH THIS PROJECT.

4. THE CONTRACTOR AND ALL SUBCONSTRACTORS SHALL VERIFY ALL EXISTING CONDITIONS & DIMENSIONS AT THE JOBSITE. THE CONTRACTOR SHALL

AACOO 2746 COORDINATE ACTUAL FIELD CONDITIONS WITH THE WORK SPECIFIED IN THE CONSTRUCTION DOCUMENTS PRIOR TO BIDDING AND ANY CONSTRUCTION, AND SHALL NOTIFY THE ARCHITECT IMMEDIATELY IF ANY DISCREPANCIES ARE ENCOUNTERED. BY SUBMISSION OF A BID FOR CONSTRUCTION, THE CONTRACTOR AND HIS SUBCONTRACTORS ACKNOWLEDGE PERFORMING THE ABOVE INSPECTION, AND INCLUDE IN IT'S PROPOSAL ALL COSTS AND/OR FEES PERTAINING TO THE COMPLETION OF THE PROJECT AS INTENDED IN THE BIDDING CONSTRUCTION DOCUMENT SET AND ANY ADDENDA. THESE COSTS MIGHT INCLUDE, BUT ARE NOT LIMITED TO, THE REMOVAL, RELOCATION, AND/OR REPAIR OF ANY EXISTING OBJECTS OR OBSTRUCTIONS WHICH MAY BE ENCOUNTERED IN PERFORMING THE

5. ALL WORK SHALL COMPLY WITH THE LATEST EDITION OF ALL NATIONAL, STATE AND LOCAL CODES HAVING JURISDICTION, THE FLORIDA BUILDING CODE, AND WITH THE REQUIREMENTS OF THE UTILITY COMPANIES WHOSE SERVICES SHALL BE UTILIZED. ALL MODIFICATIONS REQUIRED BY ANY OF THESE ENTITIES SHALL BE IMMEDIATELY BROUGHT TO THE ATTENTION OF THE ARCHITECT. RESULTING CHANGES, MAY BE SHOWN, AS DETERMINED BY THE ARCHITECT, ON REVISED DRAWINGS ISSUED TO THE CONTRACTOR. ANY ADJUSTMENTS TO CONSTRUCTION FEES SHALL TAKE PLACE AT THIS TIME, AND SUBMITTED FOR CONSIDERATION

AND APPROVAL OF THE ARCHITECT AND OWNER. 6. THE CONTRACTOR AND EACH SUBCONTRACTOR SHALL MAKE ARRANGEMENTS FOR, OBTAIN, AND PAY, FOR ALL PERMITS, TESTS, INSPECTIONS, AND APPROVALS REQUIRED FOR IT'S PORTION OF THE WORK. THE CONTRACTOR AND EACH SUBCONTRACTOR SHALL BE RESPONSIBLE FOR NOTIFYING THE ARCHITECT OF ALL MANDATORY BUILDING INSPECTIONS REQUIRED BY THE BUILDING DEPARTMENT TO BE MADE BY THE ARCHITECT OR ANY OF HIS ENGINEERS UPON ISSUANCE OF THE PERMIT. THE CONTRACTOR MUST CONTACT

INSPECTION AND INITIAL THE INSPECTION LOG AS REQUIRED BY THE FLORIDA BUILDING CODE. THE CONTRACTOR SHALL MAINTAIN RECORDS OF DEVIATIONS FROM THE DRAWINGS AND PREPARE AS-BUILT RECORD DRAWINGS SHOWING. CORRECTLY AND ACCURATELY ALL CHANGES AND DEVIATIONS MADE DURING CONSTRUCTION TO REFLECT THE WORK AS IT WAS ACTUALLY CONSTRUCTED. REFER TO FRONT END

THE ARCHITECT OR ENGINEER PRIOR TO SCHEDULING THE INSPECTION WITH THE BUILDING INSPECTOR SO THAT THE ENGINEER CAN CONDUCT THE SAME

SPECIFICATIONS FOR FURTHER INFORMATION AND REQUIREMENTS PERTAINING TO THE AS-BUILT DRAWINGS/ DOCUMENTATION. 9. THE CONTRACTOR SHALL PROVIDE, INSTALL, AND MAINTAIN ALL BARRICADES, BARRIERS, AND DUST CONTROL SYSTEMS NECESSARY TO PROTECT THE HEALTH AND SAFETY OF THE PERSONS USING OR OCCUPYING ADJACENT ROW AND/OR SITES.

10. WRITTEN DIMENSIONS AND NOTES ARE TYPICAL FOR ALL SIMILAR CONDITIONS, UNLESS OTHERWISE SPECIFIED IN THE CONSTRUCTION DOCUMENTS. DO NOT SCALE DRAWINGS. IF REQUIRED DIMENSIONS OR NOTES ARE NOT INDICATED, THE CONTRACTOR SHALL NOTIFY THE ARCHITECT FOR RESOLUTION. THE CONTRACTOR AND SUBCONTRACTORS SHALL BE RESPONSIBLE FOR ANY CUTTING, FITTING, AND PATCHING THAT MAY BE REQUIRED TO PROPERL'

COMPLETE THE WORK OF HIS CONTRACT. NO SUBCONTRACTOR SHALL ENDANGER THE WORK OF ANY OTHER SUBCONTRACTOR. THE CONTRACTOR SHALL SUBMIT PRODUCT APPROVALS, SHOP DRAWINGS, SAMPLES, AND EQUIPMENT SPECIFICATION SHEETS AS CALLED FOR IN THE CONSTRUCTION DOCUMENTS INCLUDING, BUT NOT LIMITED TO, THE FOLLOWING: PREFABRICATED TRUSSES, WINDOWS, DOORS, ELECTRICAL AND MECHANICAL EQUIPMENT, PLUMBING FIXTURES, CABINETRY, AND FINISHES. ALL SUBMITTALS SHALL BE DELIVERED TO THE OWNER OR ARCHITECT TO ALLOW FOR REVIEW. PROCUREMENT AND/OR FABRICATION SHALL NOT COMMENCE UNTIL SUBMITTALS ARE REVIEWED AND APPROVED BY THE OWNER, ARCHITECT, AND/OR ENGINEER.

13. ALL REQUIRED LAB TESTS PERTAINING TO THE PROJECT SHALL BE PERFORMED AT THE SOLE EXPENSE OF THE CONTRACTOR, AND BY A LICENSED TESTING LABORATORY UNDER THE SUPERVISION OF A FLORIDA REGISTERED ENGINEER. TEST RESULTS SHALL BE SUBMITTED EACH TIME A TEST IS COMPLETED. 14. THE CONTRACTOR AND ALL APPLICABLE SUBCONTRACTORS SHALL FURNISH AND BE SOLEY RESPONSIBLE FOR ALL TEMPORARY BRACING AND SHORING REQUIRED TO MAINTAIN THE PLUMBNESS AND STABILITY OF STRUCTURAL ELEMENTS. THIS SHALL APPLY EVEN TO THOSE STRUCTURAL MEMBERS NOT INDICATED

IN THE CONSTRUCTION DOCUMENTS. 15. NO STRUCTURAL MEMBER SHALL BE CUT, REMOVED, AND/OR MODIFIED (UNLESS SPECIFIED IN THE CONSTRUCTION DOCUMENTS) WITHOUT THE WRITTEN CONSENT OF

THE ARCHITECT OR THE STRUCTURAL ENGINEER. 16. AFTER COMPLETION OF CONSTRUCTION, ALL WORK AREAS SHALL BE LEFT CLEAN AND FREE OF ANY JOINT COMPOUND, PLASTER, STUCCO AND PAINT SMEARS OR

SPLATTERS. THE BUILDING IS TO BE BROOM CLEANED. THE SITE SHALL BE CLEAN OF ALL CONSTRUCTION DEBRIS AND MATERIALS. ALL LANDSCAPE SHALL BE IN-PLACE, TRIMMED, MOWED AND OTHERWISE IN FINAL CONDITION. 17. CABINET MANUFACTURER SHALL FIELD MEASURE EXACT LOCATION OF ALL CABINETRY AND ELECTRICAL RECEPTACLES AT THE JOBSITE PRIOR TO THE FABRICATION OF ANY CABINETRY. 18. ALL PAVEMENT MARKINGS SHALL BE THERMOPLASTIC (T) EXCEPT FOR THE 6" WHITE LINES ON EITHER SIDE OF A PARKING SPACE AND THE 6" BLUE LINES FOR

ACCESSIBLE SPACES

CONCRETE SIDEWALKS: PROVIDE SQUARE FOOTAGE UNIT COST TO REPLACE ALL DAMAGED SECTIONS OF EXISTING ON-GRADE CONCRETE SIDEWALKS, INCLUDING, AT A MINIMUM, ANY SURFACE CRACKS EXCEEDING 1/4" IN WIDTH AND DEPTH. COST SHALL BE PROVIDED FOR ENTIRE WIDTH OF SIDEWALK, WHICH ENCOMPASSES THE DAMAGED AREA(S)

SIDEWALK SHALL MATCH EXISTING FINISH, WIDTHS AND THICKNESS (4" MINIMUM, 6" AT DRIVEWAYS). PROVIDE 6X6X10 WIRE WELDED MESH AT DRIVEWAYS. PROVIDE 1/8" X 1-1/2"(DEEP) SAWED JOINTS @5'-O" O.C. MAXIMUM AND 1/4" OPEN JOINTS WITH 1/2" RADIUS TOP EDGES AT CHANGE OF DIRECTION AREAS.

2. STUCCO REPAIRS PROVIDE SQUARE FOOTAGE UNIT COST FOR STUCCO REPAIRS AS FOLLOW:

a. LOCATE EXPOSED STUCCO WALL AREAS WITH EXTENSIVE CRACKING, DELAMINATION FROM THE SUBSTRATE AND/OR SUBSTRATE EXPOSURE b. AT DELAMINATED AREAS, REMOVE STUCCO SURFACING, CLEAN SUBSTRATE APPLY PRIME AND/OR BONDING COMPOUND, APPLY STUCCO RESURFACING TO MATCH EXISTING THICKNESS AND TEXTURE.

c. AT CRACKS, CLEAN OUT LOOSE MATERIALS, PRIME INSIDE SURFACES. FOR LARGE CRACKS, FILL WITH STUCCO PATCHING LEVELING MATERIALS. FOR SMALL CRACKS, FILL CRACK WITH COMPATIBLE SEALANT AND STRIKE FLUSH WITH ADJACENT SURFACES.

3. BOARD AND/OR PLYWOOD ROOF SHEATHING PROVIDE COSTS TO REPLACE ALL DAMAGED ROOF SHEATHING SECTIONS WITH SAME. BOARD SHEATHING COSTS SHALL BE SUBMITTED IN LINEAR FOOTAGE (L.F.), PLYWOOD SHEATHING COSTS SHALL BE SUBMITTED IN SQUARE FEET (S.F.).

CODE COMPLIANCE STATEMENTS

HUD SECTION 504 STATEMENT: AT LEAST ONE BUILDING UNIT TYPE (I.E. : EFFICIENCY AND/ OR NUMBER OF BEDROOMS) HAVE BEEN MODIFIED AND RENOVATED TO COMPLY WITH FBCA 2010, MOBILITY SECTIONS 233.2 AND COMMUNICATION SECTION 233.3, TO THE GREATEST EXTENT POSSIBLE -IN COMPLIANCE WITH


2. THIS PROJECT IS FUNDED THRU THE FEDERAL GOVERNMENT AND IS COVERED BY TITLE II OF THE ADA

d. UPON COMPLETION OF REPAIR AND ADEQUATE CURING TIME, PAINT ENTIRE WALL SURFACE.

ALTERNATE BID ITEMS

CONTRACTOR SHALL PROVIDE AN ADD ALTERNATE BID PRICE FOR MILLING AND RESURFACING ONE-INCH (I") MINIMUM DEPTH FOR PARKING FIELD & DRIVE WITH A FINAL COMPACTED THICKNESS OF SP-95 (S-III)

2. CONTRACTOR SHALL PROVIDE AN ADD ALTERNATE BID PRICE FOR REMOVAL OF THE EXISTING STUCCO (ALL SIDES) BY SANDBLASTING DOWN TO THE CMU SUBSTRATE AND PROVIDING A NEW 2 COAT STUCCO SYSTEM (MINIMUM OVERALL THICKNESS 5/8"). ALL NEW STUCCO SURFACES SHALL BE PRIMED AND PAINTED. REMOVE GRADING AROUND PERIMETER OF BUILDING TO ALLOW FOR PROPER AND COMPLETE REMOVAL OF EXISTING STUCCO AND TO ALLOW FOR NEW STUCCO APPLICATION 12" BELOW FINISH GRADE MINIMUM.

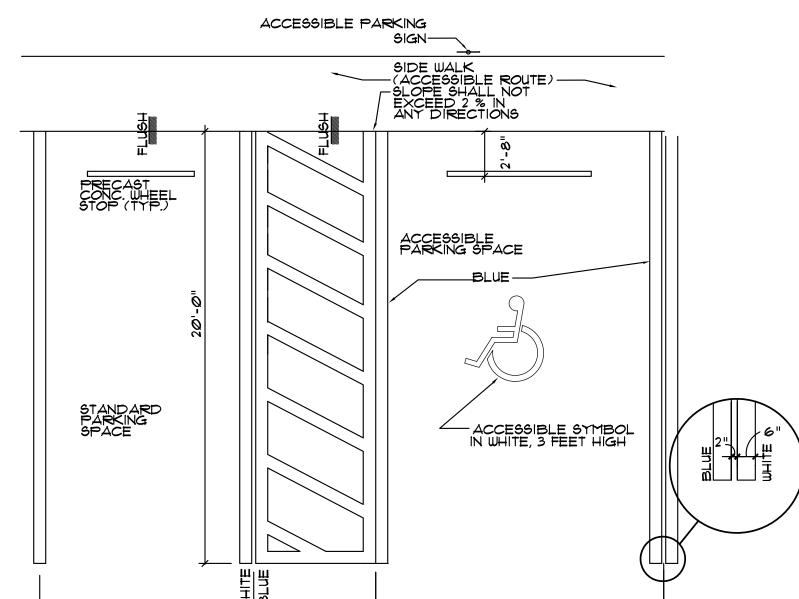

ACCESSIBLE PARKING SPACE DETAIL

1/4"=1'-0"

12'-0"

FHA GUIDELINES

ALL DWELLING UNITS SHALL COMPLY WITH THE

FOLLOWING ITEMS: BUILDING ENTRANCE SHALL BE ON AN ACCESSIBLE ROUTE. . PUBLIC AND COMMON USE AREAS SHALL BE ACCESSIBLE. 3. ALL DOORS WITHIN EACH UNIT SHALL COMPLY WITH ACCESSIBILITY. 4. ALL UNITS SHALL PROVIDE ACCESSIBLE ROUTE INTO AND THROUGH THE DWELLING 5. LIGHT SWITCHES, ELECTRICAL OUTLETS, THERMOSTATS, AND OTHER ENVIRONMENTAL CONTROLS SHALL BE ACCESSBILE. a. LIGHT SWITCHES AND THORMOSTATES SHALL BE LOCATED AT 48" MAXIMUM A.F.F. b. ELECTRICAL OUTLETS SHALL BE LOCATED AT 15" MIN. A.F.F. 6. REINFORCE BATHROOM WALL AREAS FOR FUTURE INSTALLATION OF GRAB BARS AROUND TOILETS AND SHOWERS AND BATHTUBS. GC TO PROVIDE RECORD HAS BEEN LOCATED. 7. KITCHENS AND BATHROOMS SHALL PROVIDE WHEELCHAIR MANEUVERABILITY.


Warning -PRIOR TO DIGGING

LOCATED.

12 HOURS PRIOR TO DIGGING THE CONTRACTOR SHALL COORDINATE ALL SUCH WORK WITH ALL UNDERGROUND UTILITY SERVICES COMPANIES TO VERIFY LOCATION OF ALL UNDERGROUND UTILITIES. ADDITIONALLY THE CONTRACTORS SHALL CONTACT SUNSHINE STATE ONE CALL OF FLORIDA, INC. (1-800-432-4770) TO ASSURE THAT ALL UTILITIES HAVE BEEN IDENTIFIED AND

LEGAL DESCRIPTION LOT 2 OF "ETHEL WOOD" ACCORDING TO THE PLAT THEREFORE, AS RECORDED IN PLAT BOOK 10 AT PAGE 59 OF THE PUBLIC RECORDS OF

MIAMI-DADE COUNTY , FLORIDA

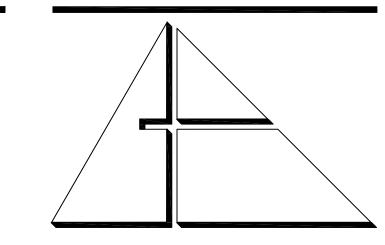

ALLEGUEZ ARCHITECTURE, INC. ARCHITECTURE PLANNING INTERIOR DESIGN

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> CITY OF MIAMI LIFE QUEST **RENOVATIONS**

1075 NE 149 ST


Owner's Representative Dollila Pinkhasov City of Miami Department of Community Developmen (305) 416-2184 444 SW 2nd Avenue

MIAMI, FL. 33130

DRAWING TITLE:

SITE PLAN SCOPE OF WORK GENERAL NOTES


AND DETAILS

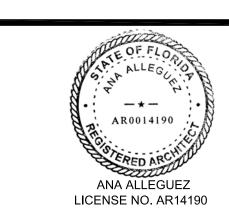

JANUARY 9TH,

CAD DRAWING NAME: 1075 A-1.0.DWG

SHEET NO.

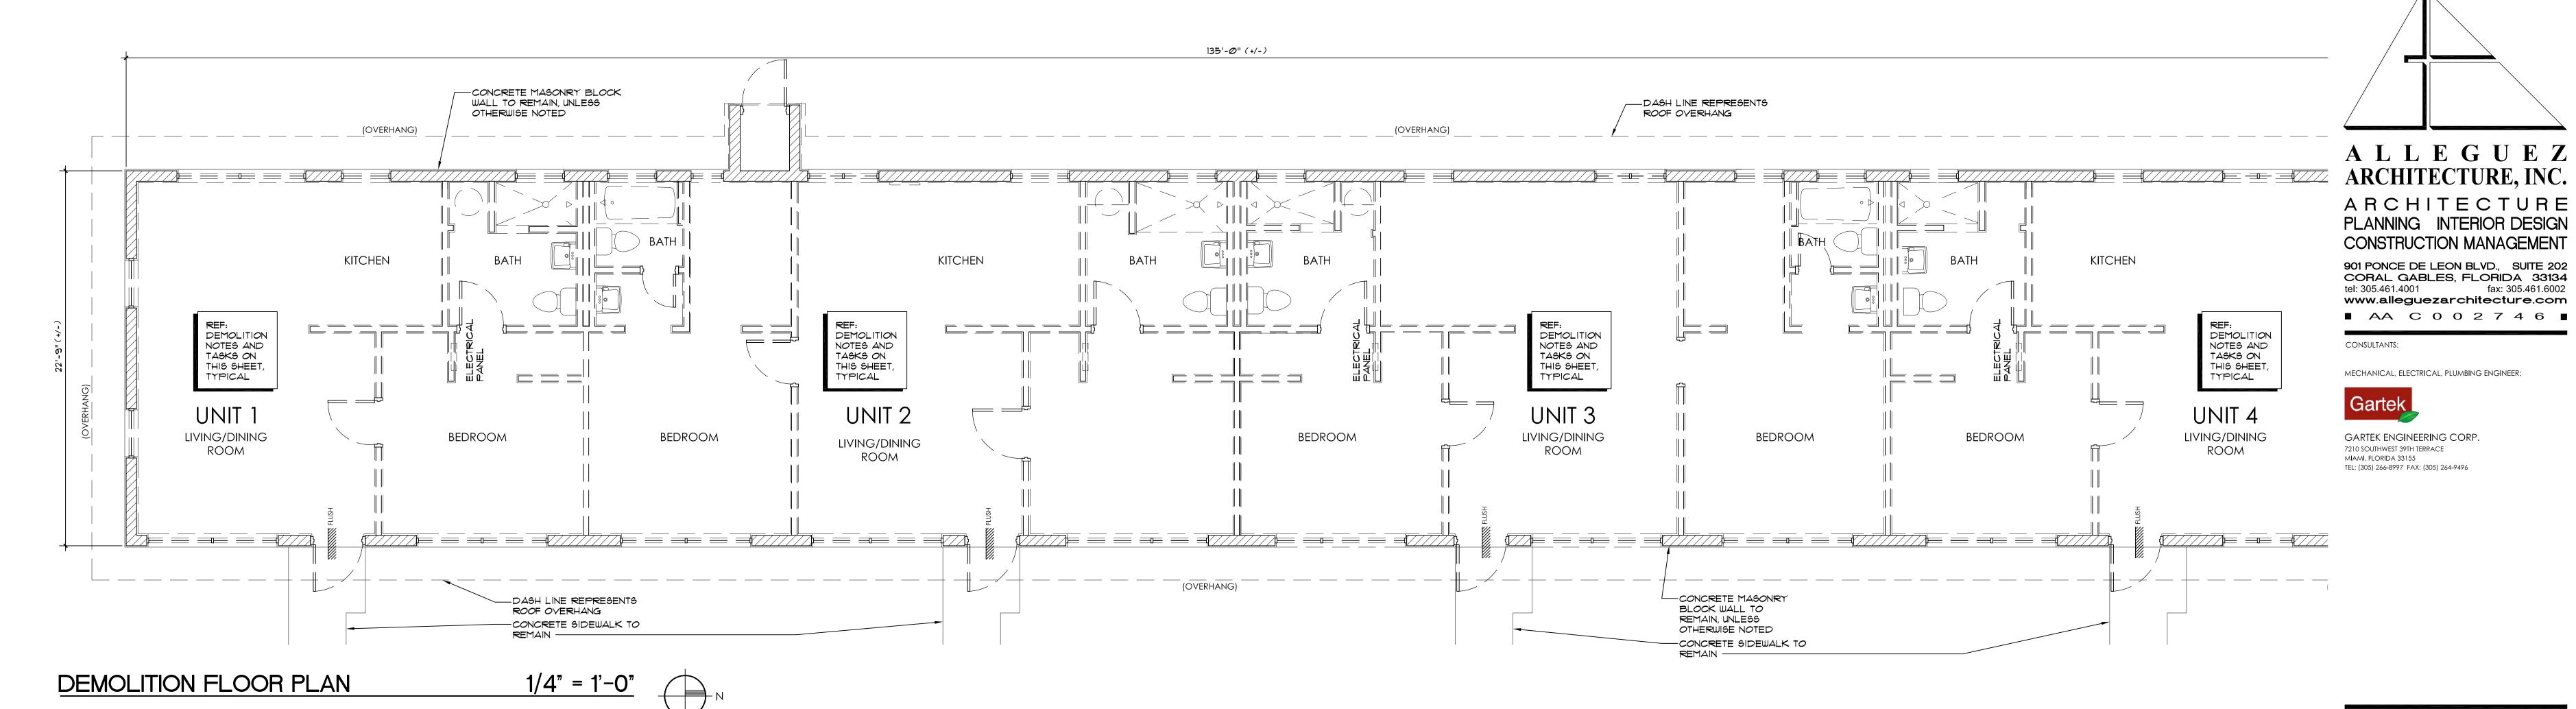

GENERAL DEMOLITION NOTES

- THE CONTRACTOR SHALL EXERCISE CARE DURING DEMOLITION AND REMOVAL TO ASSURE THAT ITEMS SCHEDULED FOR DEMOLITION ARE PROPERLY REMOVED AND ITEMS TO REMAIN ARE PROTECTED FROM DAMAGE.
- 2. THE CONTRACTOR SHALL PROVIDE ALL SHORING AND TEMPORARY SAFEGUARDS AND WARNING SIGNS - AS REQUIRED.
- 3. ALL FINISHES AND SURFACES TO REMAIN WHICH ARE DAMAGED DURING DEMOLITION AND/OR DURING NEW CONSTRUCTION SHALL BE REPAIRED AND REPLACED TO THE SATISFACTION OF THE ARCHITECT AT NO ADDITIONAL COST TO THE OWNER. 4. THE CONTRACTOR SHALL FIELD VERIFY ALL DIMENSIONS AND EXISTING CONDITIONS PRIOR TO COMMENCEMENT OF WORK AND SHALL ADVISE THE ARCHITECT OF ANY DISCREPANCIES IN WRITTEN
- FORM WITHIN THREE DAYS. 5. ACTUAL EXISTING DIMENSIONS SHALL GOVERN.
- 6. DEMOLITION FLOOR PLAN DEPICTS CURRENT/EXISTING BUILDING LAYOUT-EXTERIOR, INCLUDING WINDOWS AND DOORS AND INTERIOR, INCLUDING PARTITION CONFIGURATION, PLUMBING FIXTURES 1. ALL DEMOLISHED MATERIALS SHALL BE DISPOSED OF IN A PROPER MANNER OFF SITE OTHERWISE NOTO FOR SALVAGE.
- 8. THE CONTRACTOR SHALL IMMEDIATELY NOTIFY THE ARCHITECT OF ANY UNANTICIPATED CONDITIONS AND OR DISCREPANCIES.
- 9. THE CONTRACTOR SHALL REPAIR DAMAGES TO ANY UTILITIES AT NO COST TO THE OWNER.
- 10. THE CONTRACTOR SHALL ERECT FENCES AROUND THE WORK AREA AS REQUIRED TO PREVENT ACCESS BY UNAUTHORIZED PERSONS
- II. THE CONTRACTOR SHALL ERECT FENCES AROUND THE WORK AREA AS REQUIRED TO PREVENT ACCESS BY UNAUTHORIZED PERSONS
- 12. REMOVE EXISTING BUILDING ELEMENTS WHERE INDICATED ON THE PLAN, REMOVE ADDITIONAL INCIDENTAL EXISTING BUILDING ELEMENTS WHERE REQUIRED TO ACCOMMODATE NEW CONSTRUCTION. REMOVE AND MODIFY EXISTING CEILINGS WHERE INTERFACING WITH NEW CEILINGS.

DEMOLITION TASKS

- REMOVE SITE PERIMETER CHAIN LINK (C. L.) FENCING COMPLETELY, INCLUDING ALL CONCRETE POST FOOTINGS
- REMOVE ALL SOD AND SHRUBS THROUGHOUT ENTIRE SITE UNLESS OTHERWISE NOTED. REFER TO LANDSCAPE NOTES FOR TOPSOIL REQUIREMENTS
- 3. ALL EXISTING UNITS ROOM/PARTITION LAYOUTS ARE SAME/SIMILAR TO CORRESPONDING NEW LAYOUTS.
 4. DEMOLITION TASKS INCLUDED HEREIN APPLY TO ALL FOUR (4) INDIVIDUAL UNITS.
- 5. REMOVE ALL FRAME AND GYPSUM BOARD PARTITIONS, INCLUDING FURRING AND GYPSUM BOARD
- 6. REMOVE ALL GYPSUM BOARD AND FURRING CEILING (AT UNDERSIDE OF ROOF TRUSSES) THROUGHOUT ALL INTERIOR SPACES.
- . REMOVE ALL MILLWORK AND ALL ARCHITECTURAL TRIM WORK.

ON EXTERIOR CMU WALLS, THROUGHOUT ALL INTERIOR SPACES.

- B. REMOVE ALL INTERIOR WOOD DOORS AND FRAMES AND ALL EXTERIOR DOORS AND WOOD
- 9. REMOVE ALL ALUMINUM FRAMES AND GLASS WINDOWS (IN EXTERIOR MASONRY WALLS).
- 10. REMOVE ALL ARCHITECTURAL FINISHES INCLUDING VCT AND TILE FLOOR FINISHES. 11. REMOVE RAMP STEEL PIPE RAILING.
- 12. REMOVE ENTIRE SHINGLE ROOF SYSTEM DOWN TO PLYWOOD AND OR WOOD PLANK SHEATHING
- SUBSTRATE, INCLUDING WOOD FASCIA AND SOFFIT. 13. CONTRACTOR SHALL DISCONNECT ALL UTILITIES.
- 14. REMOVE ALL ELECTRICAL DEVICES
- 15. REMOVE ALL PLUMBING FIXTURES AND ASSOCIATED PLUMBING LINES
- 16. THE EXISTING SEPTIC TANK SHALL BE ABANDON PER THE FLORIDA ADMINISTRATIVE CODE 64E-3.011, SECTION 2. SEE PLUMBING DRAWINGS FOR FURTHER INFORMATION. THE GENERAL

CONTRACTOR SHALL BE RESPONSIBLE FIELD VERIFY THE LOCATION OF THE EXISTING SEPTIC TANK.


CITY OF MIAMI LIFE QUEST RENOVATIONS 1075 NE 149 ST

Owner's Representative: Dollila Pinkhasov

City of Miami Department of Community Development (305) 416-2184 444 SW 2nd Avenue MIAMI, FL. 33130

DRAWING TITLE:


DEMOLITION FLOOR PLAN

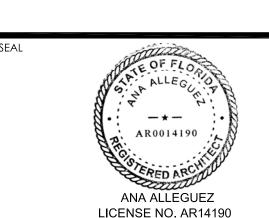



DATE: JANUARY 9TH,

REVISED:

CAD DRAWING NAME: 1075 A-1.1.DWG

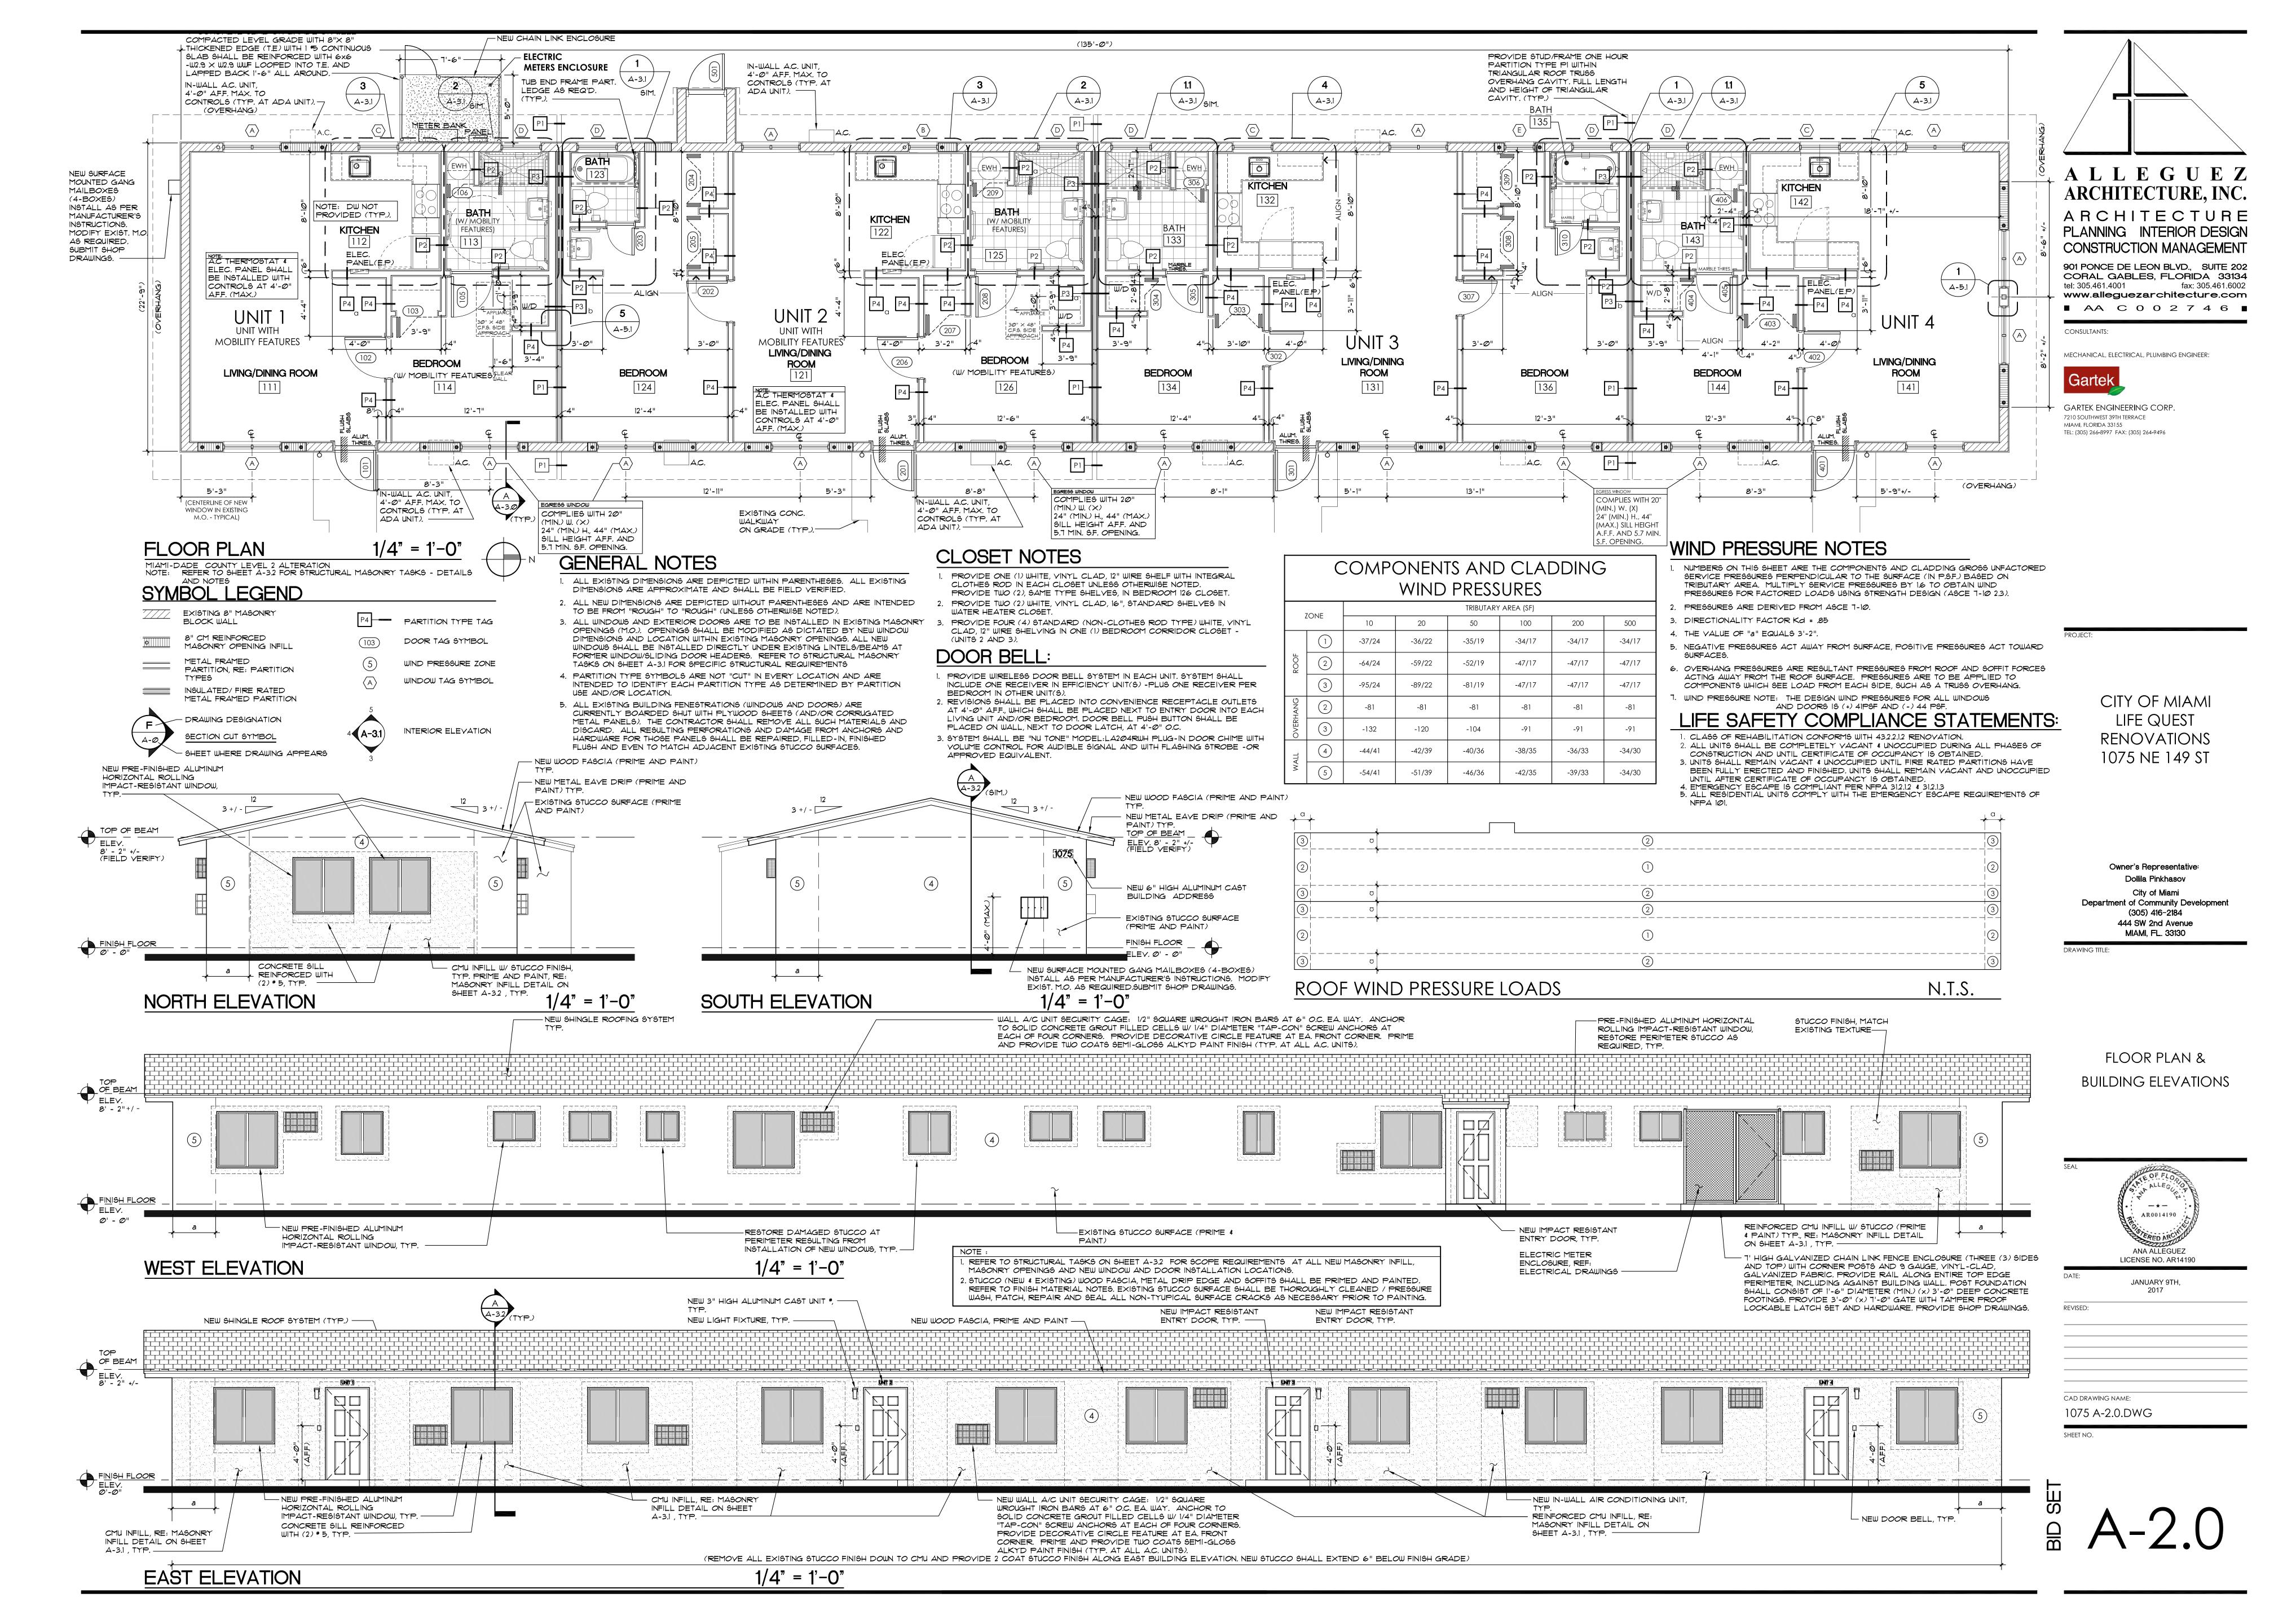

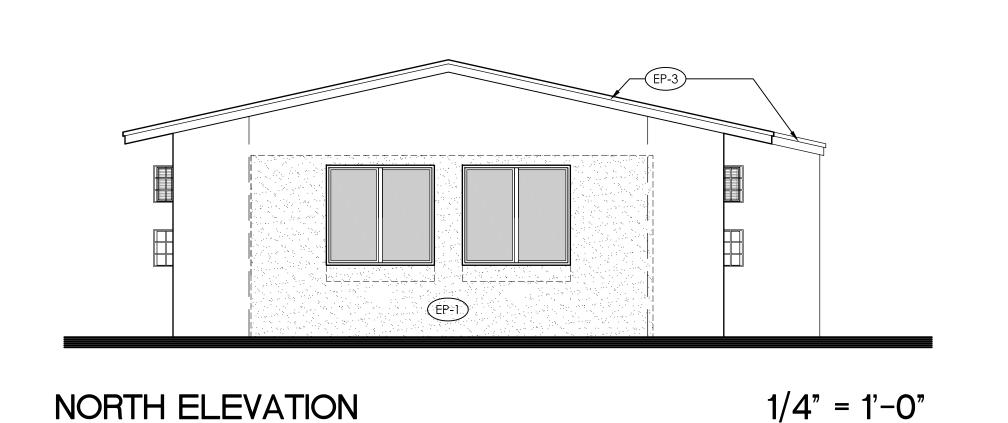

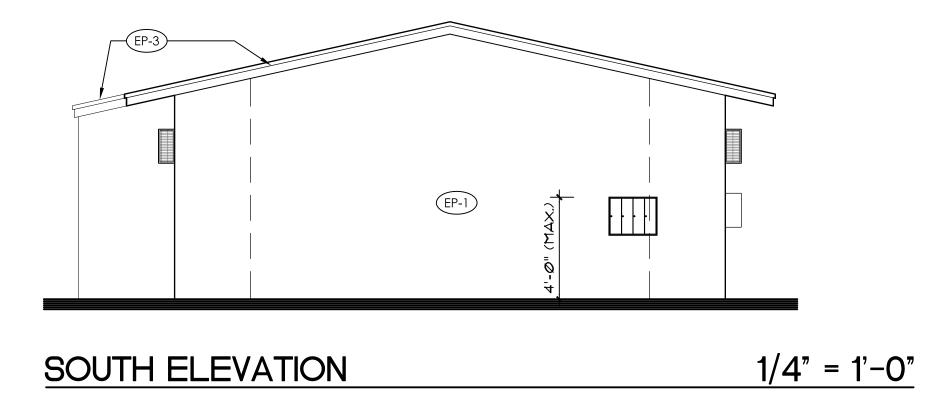

SYMBOL LEGEND

(EP-1) DENOTES PAINT COLOR


	ERIOR FINISHE HEDULE	ES
MARK	COLOR	REMARKS
EP-1	MISTY SW 6232	FIELD COLOR
EP-2	EXTRA WHITE SW 7006	FASCIA AND SOFFIT

EP-3 EXTRA WHITE SW 1006

1. PROVIDE MOCKUP PAINT SAMPLES 4' imes 4' SQUARE FOR EACH COLOR OF PAINT TO BE APPROVED BY OWNER.

DOORS

- 2. DO NOT PAINT OVER CODE-REQUIRED LABELS SUCH AS UNDERWRITERS LABORATORIES (UL) AND FACTORY MUTUAL (FM), NAME EQUIPMENT IDENTIFICATION, PERFORMANCE RATING, OR NOMENCLATURE PLATES.
- 3. PAINT WARRANTY: SIX (6) YEARS WARRANTY FOR LABOR AND MATERIAL FROM THE
- PAINT MANUFACTURER. 4. SHOP DRAWING SUBMITTAL:
- a. SUBMIT MANUFACTURER PRODUCT SAFETY DATA, MANUFACTURER'S TECHNICAL INFORMATION, INCLUDING PAINT LABEL ANALYSIS AND APPLICATION INSTRUCTIONS FOR EACH MATERIAL PROPOSED FOR USE:
- b. SAMPLES: PROVIDE COLOR CHIPS FOR REVIEW BY ARCHITECT. C. SUBMIT PAINT MANUFACTURER'S PROPOSED 6 YEAR WARRANTY
- 5. PHASE PROJECT TO ALLOW A MINIMUM OF 28 DAYS FOR STUCCO AND PLASTER TO CURE PROPERLY. IF PAINTING BEGINS BEFORE THE 28 DAY CURING PERIOD, THEN A MOISTURE AND 19H TEST SHALL BE MADE ACCORDING TO ASTM D4262 AND ASTM D4269. 6. DO NOT PAINT OVER FACTORY-FINISHED OR INSTALLER-FINISHED SPECIFIED ITEMS, CONCEALED SURFACES, FINISHED METAL MATERIAL (SUCH AS ANODIZED ALUMINUM, STAINLESS STEEL, BARE
- OPERATING PARTS AND CODE REQUIRED LABELS. 1. BASIS OF DESIGN IS SHERWIN WILLIAMS OR APPROVED EQUIVALENT. REFER TO FINISH MATERIAL NOTES ON SHEET A-3.1 FOR PAINT

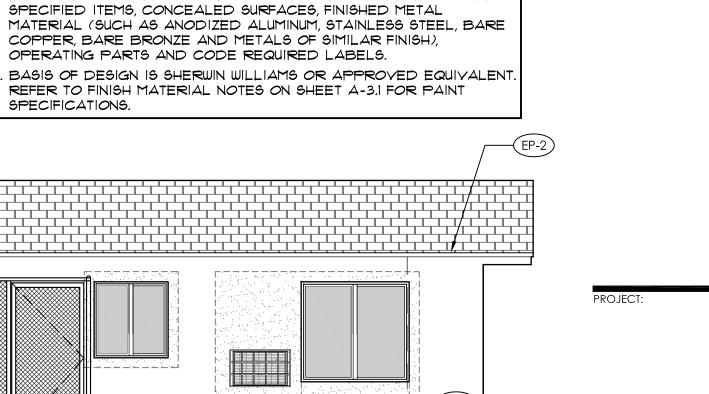

CITY OF MIAMI LIFE QUEST RENOVATIONS 1075 NE 149 ST

ALLEGUEZ

ARCHITECTURE, INC.

ARCHITECTURE

PLANNING INTERIOR DESIGN

CONSTRUCTION MANAGEMENT

901 PONCE DE LEON BLVD., SUITE 202

CORAL GABLES, FLORIDA 33134

www.alleguezarchitecture.com

■ AA C 0 0 2 7 4 6 ■

MECHANICAL, ELECTRICAL, PLUMBING ENGINEER:

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TEL: (305) 266-8997 FAX: (305) 264-9496

7210 SOUTHWEST 39TH TERRACE MIAMI, FLORIDA 33155

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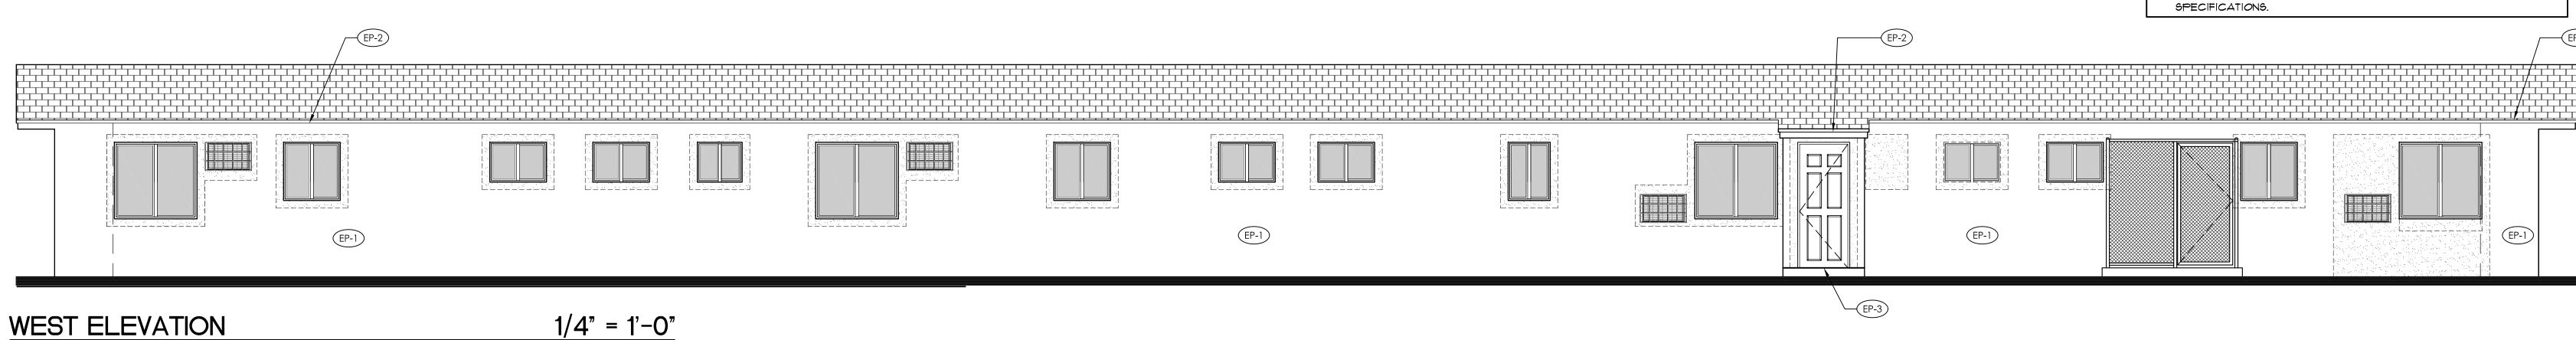
EXTERIOR


FINISHES

LICENSE NO. AR14190

JANUARY 9TH,

CAD DRAWING NAME: 1075 A-2.1.DWG



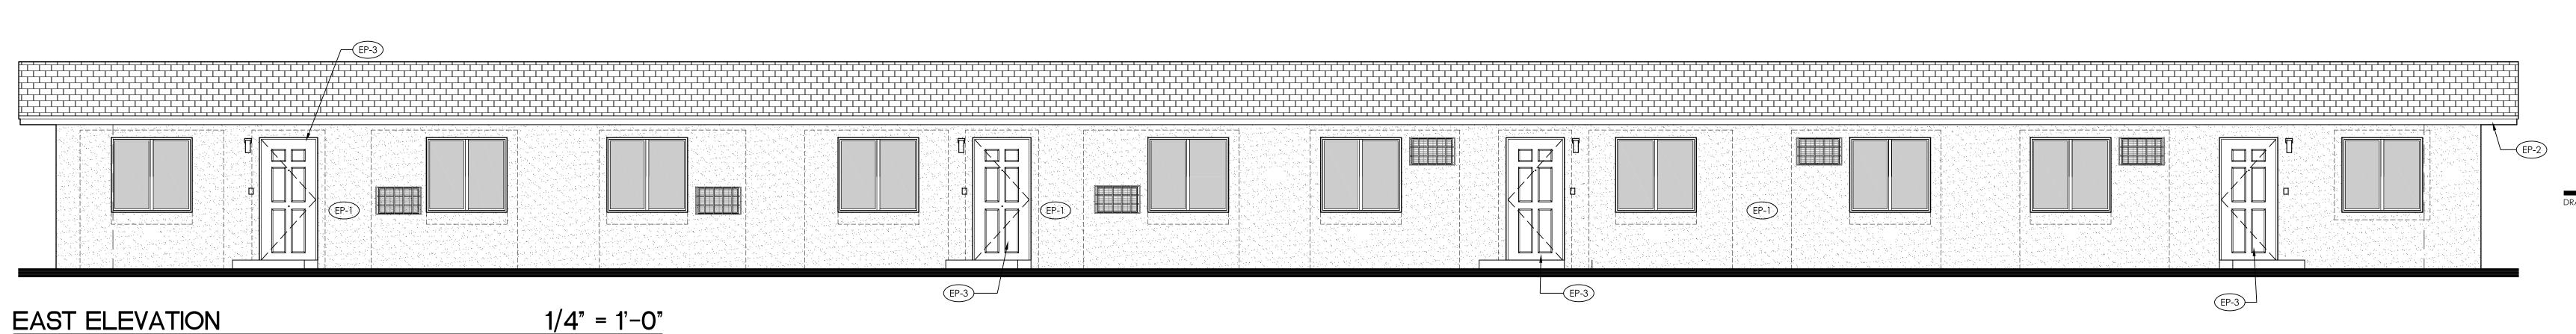

	WINDOW SCHEDULE(
MARK	TYPE	SIZE	MAT FRAME	MATERIAL FRAME GLAZING		IISH GLAZING	REMARKS	
A	HORIZONTAL ROLLING	54 W × 50-5/8" H	ALUMINUM	LAMINATED GLASS	FRAME ESP - WHITE	TINTED	MIAMI-DADE COUNTY NOTICE OF ACCEPTANCE (N.O.A.): 15-0929.13	
В	HORIZONTAL ROLLING	26-1/2" W × 38-3/8" H	1					
С	HORIZONTAL ROLLING	37" W × 38-3/8" H				1		
D	HORIZONTAL ROLLING	37" W × 26" H				FROSTED		
E	HORIZONTAL ROLLING	26-1/2" W × 26" H				TINTED		

NOTES: 1. WINDOW SCHEDULE VALUES ARE BASED ON WINDOW MODELS MANUFACTURED BY CGI WINDOWS AND DOORS, SENTINEL HORIZONTAL ROLLING WINDOW

SERIES 120 AND ARE SPECIFIED TO ESTABLISH PROJECT WINDOW STANDARDS. 2. WINDOWS SHALL HAVE CURRENT MIAMI-DADE COUNTY PRODUCT APPROVAL NOTICE OF ACCEPTANCE (N.O.A.). 3. GLAZING SHALL BE 5/16" IMPACT RESISTANT LO E 366 WITH GRAY TINT, SUBMIT GLAZING SAMPLE FOR APPROVAL.
4. ALL WINDOWS WITHIN 4'-0" ADJACENCY TO A DOOR AND ALL WINDOWS WITHIN BATHROOMS SHALL BE OF

CATEGORY II SAFETY GLAZING. 5. PROVIDE 8" X 8" CONCRETE SILL WITH 2 * 5 REINFORCING

CONTRACTOR SHALL FIELD VERIFY MASONRY OPENINGS PRIOR TO FABRICATION OF WINDOWS. 6. CONTRACTOR SHALL BE RESPONSIBLE TO COORDINATE DOORS / WINDOWS OVERALL DIMENSIONS WITH ROUGH MASONRY OPENINGS.
1. CONTRACTOR SHALL SUBMIT WINDOW SHOP DRAWINGS PRIOR TO ORDERING WINDOWS FOR ARCHITECT'S REVIEW FOR APPROVAL.
9. EACH WINDOW SHALL HAVE AN INSECT SCREEN.

								\D C \C		. –			
	DOOR SCHEDULE												
	DOOR	DOOR		R OPENING		MATI		FINISH				HDW	REMARKS
	NUMBER	TYPE	WIDTH	HEIGHT	THICKNES	DOOR	FRAME	DOOR	FRAME	110			
	101	A	3'-Ø"	6'-8"	1-3/4"	STEEL	WOOD	PAINT	PAINT	1	FL# 11136.2. PROVIDE WITH ADA THRESHOLD		
	1Ø2	B	3'-Ø"		1-3/4"	5.C. WOOD	WOOD			2			
EN O	103	C	3'-Ø"		-	5.C. WOOD	-						
5							NOT USED						
	105	В	3'-Ø"		1-3/4"	5.C. WOOD	WOOD			2			
	106	С	2'-Ø"		-	5.C. WOOD	-				1" UNDERCUT		
	2Ø1	Α	3'-Ø"		1-3/4"	STEEL	WOOD			1	FL* 11136.2. PROVIDE WITH ADA THRESHOLD		
	2Ø2	В	3'-Ø"		1-3/4"	5.C. WOOD	WOOD			2			
	2Ø3	В	2'-Ø"		1-3/4"	S.C. WOOD	WOOD			2	1" UNDERCUT		
7	2Ø4	D	4'-Ø"		-	S.C. WOOD	-						
≒	2Ø5	D	4'-Ø"		-	5.C. WOOD	-						
TN O	206	B	3'-Ø"		1-3/4"	5.C. WOOD	WOOD			1			
	2Ø7	C	3'-Ø"		-	5.C. WOOD	-						
	208	B	3'-Ø"		1-3/4"	5.C. WOOD	WOOD			2	1" UNDERCUT		
	2Ø9	С	2'-6"		-	5.C. WOOD	-						
							NOT USED						
	3Ø1	A	3'-Ø"		1-3/4"	STEEL	WOOD			1	FL# 11136.2. PROVIDE WITH ADA THRESHOLD		
	3Ø2	В	2'-6"		1-3/4"	5.C. WOOD	WOOD			2			
	3Ø3	D	3'-6"		-	5.C. WOOD	-						
ω	3Ø4	C	2'-8"		-	5.C. WOOD	-						
1 🖹	3Ø5	В	2'-8"		1-3/4"	5.C. WOOD	WOOD			2	1" UNDERCUT		
LN N	306	C	2'-Ø"		-	5.C. WOOD	-						
1 –	3Ø7	B	2'-6"		1-3/4"	5.C. WOOD	WOOD						
	308	D	4'-Ø"		-	5.C. WOOD	-						
	3Ø9	D	4'-Ø"		-	5.C. WOOD	-						
	310	В	2'-Ø"		1-3/4"	5.C. WOOD	WOOD			2	I" UNDERCUT		
	4Ø1	Α	3'-Ø"		1-3/4"	STEEL	WOOD			1	FL* 11136.2. PROVIDE WITH ADA THRESHOLD		
	4Ø2	В	2'-8"		1-3/4"	5.C. WOOD	WOOD			2			
4	4Ø3	D	4'-Ø"		-	5.C. WOOD	-						
L N N	404	С	2'-6"		-	5.C. WOOD	-						
5	4Ø5	В	2'-8"		1-3/4"	5.C. WOOD	WOOD			2	I" UNDERCUT		
1	406	С	2'-6"		-	5.C. WOOD	-						
	501	A	2'-6"	$oxed{igstar}$	1-3/4"	STEEL	WOOD	<u> </u>	<u> </u>	2	FIELD VERIFY DOOR OPENING SIZE (M.O.) (IMPACT RESISTANT.		

DOOR NOTE(S):

ALL DOORS SHALL BE INSTALLED WITH BACK OF DOOR FRAME, HINGE SIDE, 4" FROM NEAREST/ADJACENT PARTITION UNLESS OTHERWISE NOTED.

2. PROVIDE 1/2" MAX. HEIGHT ALUMINUM THRESHOLD WITH 1:2 (MAX.) CHAMFERED EDGES AT ALL EXTERIOR DOORS (ALL UNITS). 3. PROVIDE PRE-FAB 1/2" MAX. HT. MARBLE THRESHOLD WITH CHAMFERED EDGES AT ALL BATHROOM DOORS (ALL UNITS).


4. INTERIOR DOORS SHALL BE SMOOTH FLUSH HARDWOOD COMPOSITE SOLID CORE PRE-HUNG (TYPE). FRAME SHALL BE WOOD, PAINT GRADE, CONSISTING OF I (X) MAIN FRAME; CASING ALL AROUND, BOTH SIDES AND INTEGRAL STOP. PROVIDE SHIM AS REQUIRED AND CONTINUOUS SEALANT BEAD BETWEEN ALL DISSIMILAR MATERIALS (BACK OF CASING TO GYPSUM BOARD). PROVIDE 2 (X) SUB-FRAME AT JAMBS & HEAD; PROVIDE (3)


5. WOOD BI-FOLD DOORS SHALL BE PROVIDED WITH METAL TRACK AT HEAD. PROVIDE 2 (X) WOOD SUPPORT AT HEADER.


6. ALL WOOD DOORS AND FRAMES SHALL RECEIVE ONE PRIMER COAT AND TWO COATS SATIN LATEX PAINT.

1. ALL EXTERIOR DOORS SHALL BE INSULATED (TYPE).

8. PROVIDE "PEEP" HOLE ON EACH EXTERIOR/ENTRY DOOR AT STANDARD HEIGHT. PROVIDE A SECOND PEEP HOLE AT UNITS WITH MOBILITY FEATURES

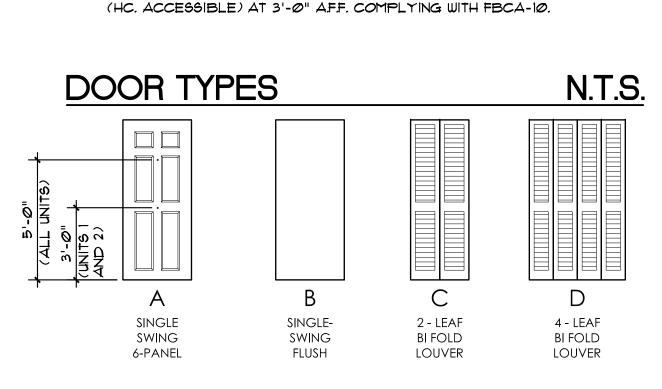

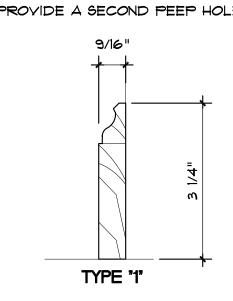

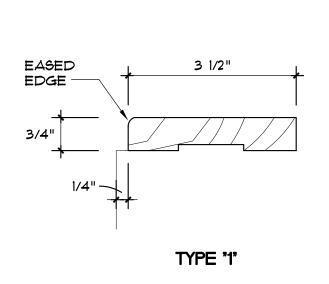

N.T.S.


WALL BAS	SE
BOARD	N.T.S.
PAINT GRADE PINE (PRIME & PAINT)	

DOOR CASING PAINT GRADE PINE (PRIME & PAINT)

GROUP 1 (FRONT ENTRY DOORS): GROUP 2 (BEDROOM/ BATHROOM DOORS):									
<u>QUAN.</u>	DESCRIPTION	MODEL	FIN.	MFR.	<u>QUAN.</u>	DESCRIPTION	MODEL	FIN.	MFR.
EA. EA. SET SET EA. EA. EA. EA.	KEYED ENTRY LOCKSET DEADBOLT HINGES WEATHERSTRIPING (BY DOOR MFR.) DOOR BOTTOM SWEEP THRESHOLD SPRING CHAIN (DOOR SWING STOP) PEEPHOLE (PROVIDE 1 EA. AT DOOR	F51 ELA B60R6 1789 623A - RS 301 AND	626 626 630 ALUM. UM.AL - 401)-	SCH SCH HAGER HAGER ZERO -	1 EA. 3 EA. 1 EA. 1 EA.	PRIVACY LOCKSET HINGES WALL STOP MARBLE THRESHOLD (AT BA DOOR		626 630 US26D	SCH HAGER IVES
NOTES: 1. ENTRY DOORS LOCKSETS COMBO SHALL BE KEYED ALIKE. 2. PROVIDE OWNER WITH MASTER KEY FOR ALL UNITS. 3. PROVIDE IN-PARTITON METAL BACKING PLATE FOR WALL STOP. 4. SUBMIT SHOP DRAWINGS FOR REVIEW AND APPROVAL BY ARCHITECT. 5. PROVIDE TWO (2) PEEP HOLES AT ADA COMPLIANT UNITS. 5. ALL CATALOG NUMBERS REFERRED TO IN THE HARDWARE SCHEDULE ARE TAKEN FROM CATALOGUES OF THE MANUFACTURERS LISTED. THEY ARE USED ONLY TO ESTABLISH THE QUALITY AND TYPE OF HARDWARE TO BE USED. 4. HARDWARE EQUAL IN QUALITY AND UTILITY WILL BE ACCEPTED PROVIDED IT CONFORMS IN OPERATION, QUALITY, WEIGHT, SIZE, WORKMANSHIP, AND FINISH-TO THE PRODUCTS DESCRIBED - AS DETERMINED BY THE ARCHITECT.									

BURGLARY SECURITY & FORCED ENTRY

- EXTERIOR DOORS LOCK SETS: SHALL RESIST A FORCE OF 300 LBS. APPLIED IN ANY MOVEABLE DIRECTION IN ACCORDANCE WITH THE RESISTANCE STANDARDS IN THE LATEST EDITION OF
- 2. EXTERIOR WINDOWS: SHALL BE LOCKED WITH LOCKING DEVICE LOCATED ON THE INTERIOR SIDE OF THE WINDOW AND SHALL BE CAPABLE OF WITHSTANDING A FORCE OF 150 LBS. APPLIED IN ANY OPERABLE DIRECTION
- 3. WINDOW SUB-BUCKS: SHALL CONSIST OF 2" MIN. (NOMINAL) PRESSURE TREATED SUB-BUCKS ANCHORED TO CONC. / MASONRY IN A MIN. OF SIX (6) ON EACH SIDE, WITH 3" (LONG)

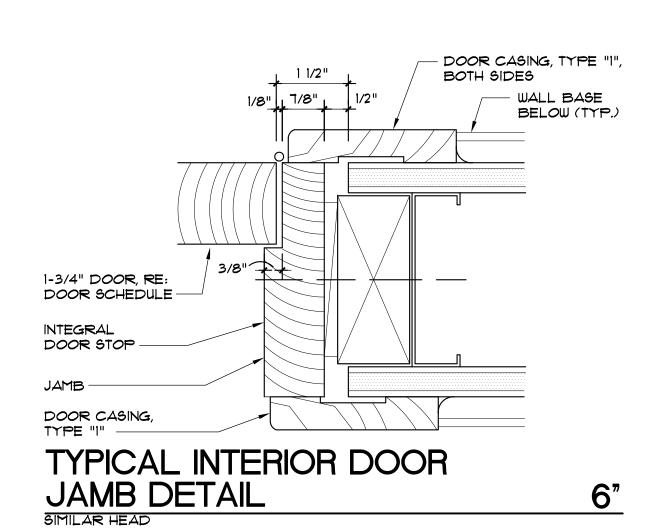



GENERAL FINISH NOTES:

ALL NEW GYPSUM BOARD SURFACES SHALL BE PROVIDED WITH TAPED AND COMPOUND LEVEL 4 (SMOOTH).

2. ALL VERTICAL SURFACES SCHEDULED TO RECEIVE CERAMIC TILE SHALL BE PROVIDED WITH 5/8" CEMENTITIOUS BOARD AS SUBSTRATE FOR WALL TILE THINSET MATERIAL.

3. REFER TO INTERIOR ELEVATIONS FOR TILE INSTALLATION HEIGHTS.

4. PROVIDE FIRE STOP AT ALL CAVITY WALLS/ PARTITION A 8'-0" MAX. 5. ALL CONCRETE SURFACES SCHEDULED TO RECEIVE VCT SHALL RECEIVE ARMSTRONG 5-184 FAST SETTING PATCH/ UNDERLAYMENT LEVELING COMPOUND OR APPROVED EQUIVALENT.

6. PRIOR TO VCT INSTALLATION, FOLLOW RESILIENT TILE MANUFACTURER'S INSTRUCTIONS AND PERFORM BOND TEST, MOISTURE TEST, PH TEST AND VAPOR EMISSION TESTS IN ACCORDANCE THE RESPECTIVE ASTM STANDARDS.

INTERIOR FINISHES & INSULATION CLASSIFICATIONS
INTERIOR WALL AND CEILING FINISH SHALL BE CLASS C INSULATION MATERIALS SHALL HAVE A FLAME SPREAD INDEX OF NOT MORE THAN 25 AND A SMOKE-DEVELOPED INDEX OF NOT

FINISH MATERIALS

FLOORING:

MORE THAN 450.

VINYL COMPOSITION TILE:

MANUFACTURER / TYPE: ARMSTRONG EXCELON (OR APPROVED EQUIVALENT) COLOR / PATTERN: TO BE SELECTED BY ARCHITECT

PORCELAIN FLOOR TILE: MANUFACTURER: DALTILE (OR APPROVED EQUIVALENT) MODEL: KEYSTONE 2 X 2 (GROUP 1 OR 2) AT SHOWERS COLOR: TO BE SELECTED BY ARCHITECT MODEL: PORCEALTO 8 X 8 AT BATHROOMS

COLOR: TO BE SELECTED BY ARCHITECT NOTE: CENTER TILE IN ROOM, ADJUST AS NECESSARY TO AVOID LESS THAN HALF A TILE AT PERIMETER. WALL TILE (WAINSCOT AND SHOWER WALLS):
MANUFACTURER / TYPE: DALTILE SEMI-GLOSS WALL TILE

GROUP I AND 2 (OR APPROVED EQUIVALENT) WALL TILE: $4" \times 4" \times 1/4"$ (NOMINAL) WAINSCOT BULL NOSE: $2" \times 6"$ (NOM.) NOTE: PROVIDE COVE EDGE TILES AT ALL TILE EXPOSED

EDGES. TILE GROUT MANUFACTURER: MAPEL OR APPROVED EQUIVALENT

GROUT COLOR - TO BE SELECTED BY ARCHITECT NOTE: ALL GROUT JOINTS SHALL BE 1/8" - OR MINIMUM RECOMMENDED BY TILE MANUFACTURER.

DETAIL.

WALL WOOD BASE: PAINT GRADE PINE, 4" \times 1/2" (NOMINAL) REFER TO DETAIL DOOR WOOD CASING / TRIM:

PAINT GRADE PINE, 3-1/2" X 3/4" (NOMINAL) REFER TO

WALL FINISH (PAINT):

MANUFACTURER: SHERWIN WILLIAMS PAINTS (OR APPROVED EQUIVALENT)

INTERIOR (GYPSUM BOARD SURFACES - WALLS AND CEILINGS): ALL GYPSUM BOARD SURFACES SHALL RECEIVE ONE COAT OF PROMAR 200 ZERO YOC INTERIOR LATEX PRIMER WHITE AND TWO (2) COATS OF LATEX BASED SEMI-GLOSS PROMAR 200 ZERO VOC.

CONTRACTOR SHALL PROVIDE 4' X 4' PAINT SAMPLES OF EACH COLOR FOR APPROVAL. COLOR: ONE COLOR - TO BE SELECTED INTERIOR (WOOD TRIM - BASE BOARDS, DOOR FRAMES AND INTERIOR WOOD DOORS):

ALL WOOD TRIM SURFACES SHALL RECEIVE ONE COAT OF PREPRITE PROBLOCK LATEX PRIMER/ SEALER WHITE AND TWO (2) COATS OF GLOSS FINISH PAINT PRO INDUSTRIAL DTM ACRYLIC GLOSS EXTRA WHITE CONTRACTOR SHALL PROVIDE PAINT SAMPLE (ON MATERIAL) FOR APPROVAL.

COLOR: WHITE EXTERIOR METAL DOORS: ALL EXTERIOR METAL DOORS SHALL BE PAINTED WITH ONE (1) COAT OF PRO

INDUSTRIAL PRO-CRYL UNIVERSAL ACRYLIC PRIMER AND 2 COATS OF PRO INDUSTRIAL DTM ACRYLIC GLOSS COLOR: WHITE

CEMENT STUCCO / PLASTER SURFACES SHALL RECEIVE ONE COAT HOT STUCCO SEALER AND TWO (2) COATS OF SUPERPAINT ACRYLIC LATEX SATIN PAINT FINISH

COUNTERTOP AND BACKSPLASH (PLASTIC LAMINATE) MANUFACTURER: WILSONART OR APPROVED EQUIVALENT COLOR: TO BE SELECTED BY ARCHITECT

SUBMIT SAMPLES FOR APPROVAL BY ARCHITECT

SMOOTH

STUCCO FINISH

1 (X) P.T. WOOD

CONTINUOUS

SEALANT BEAD,

TYP. ALL AROUND

TYP AT FLANGE

SHIM AS REQ'D.

JAMB SIMILAR

BACKBED SEALANT,

ALUM, FRAME, IMPACT

RESISTANT WINDOW RE: WINDOW SCHEDULE -

EXTERIOR

HEAD DETAIL

TYPICAL WINDOW

BUCK, SET IN BED

OF SEALANT, TYP.

EXTERIOR (CEMENT / PLASTER SURFACES):

ALLEGUEZ ARCHITECTURE, INC. ARCHITECTURE PLANNING INTERIOR DESIGN CONSTRUCTION MANAGEMENT

901 PONCE DE LEON BLVD., SUITE 202 CORAL GABLES, FLORIDA 33134 tel: 305.461.4001 fax: 305.461.6002 www.alleguezarchitecture.com ■ AA C 0 0 2 7 4 6 ■

CONSULTANTS:

MECHANICAL, ELECTRICAL, PLUMBING ENGINEER:



GARTEK ENGINEERING CORP. 7210 SOUTHWEST 39TH TERRACE MIAMI, FLORIDA 33155 TEL: (305) 266-8997 FAX: (305) 264-9496


CITY OF MIAMI LIFE QUEST **RENOVATIONS** 1075 NE 149 ST

Owner's Representative Dollila Pinkhasov City of Miami Department of Community Development (305) 416-2184 444 SW 2nd Avenue

MIAMI, FL. 33130

DRAWING TITLE:

SCHEDULES & DETAILS

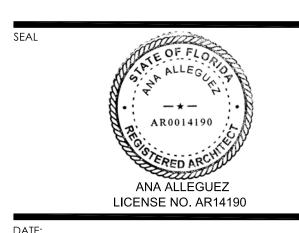

JANUARY 9TH, REVISED:

WALLBOARD OVER

PROVIDE GYP. BD.

TAPE AT INT. SIDE

OF JAMB AS REQ'D

CONT. RESILIENT

CORNER BEAD

CAULKING, TYP.

INTERIOR

3"=1'-0"


METAL FURRING,


ANCHOR


SHEET NO.


CAD DRAWING NAME:

1075 A-3.0.DWG

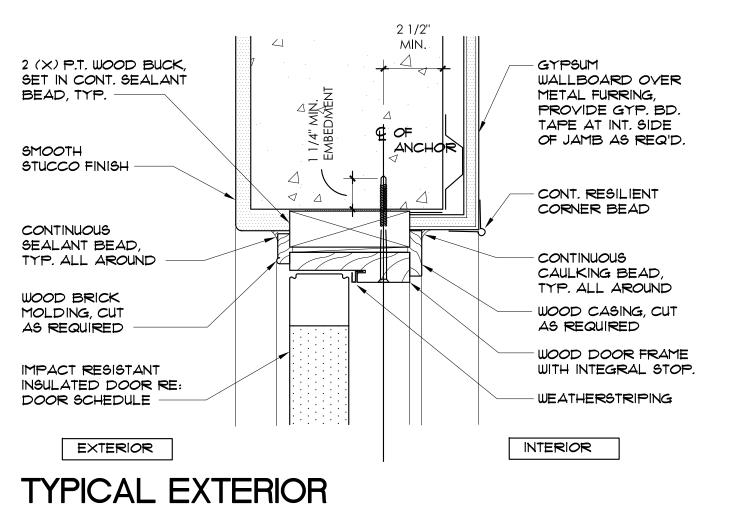

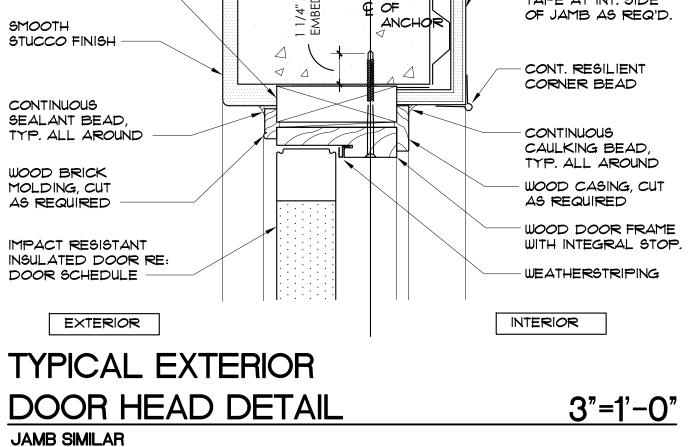

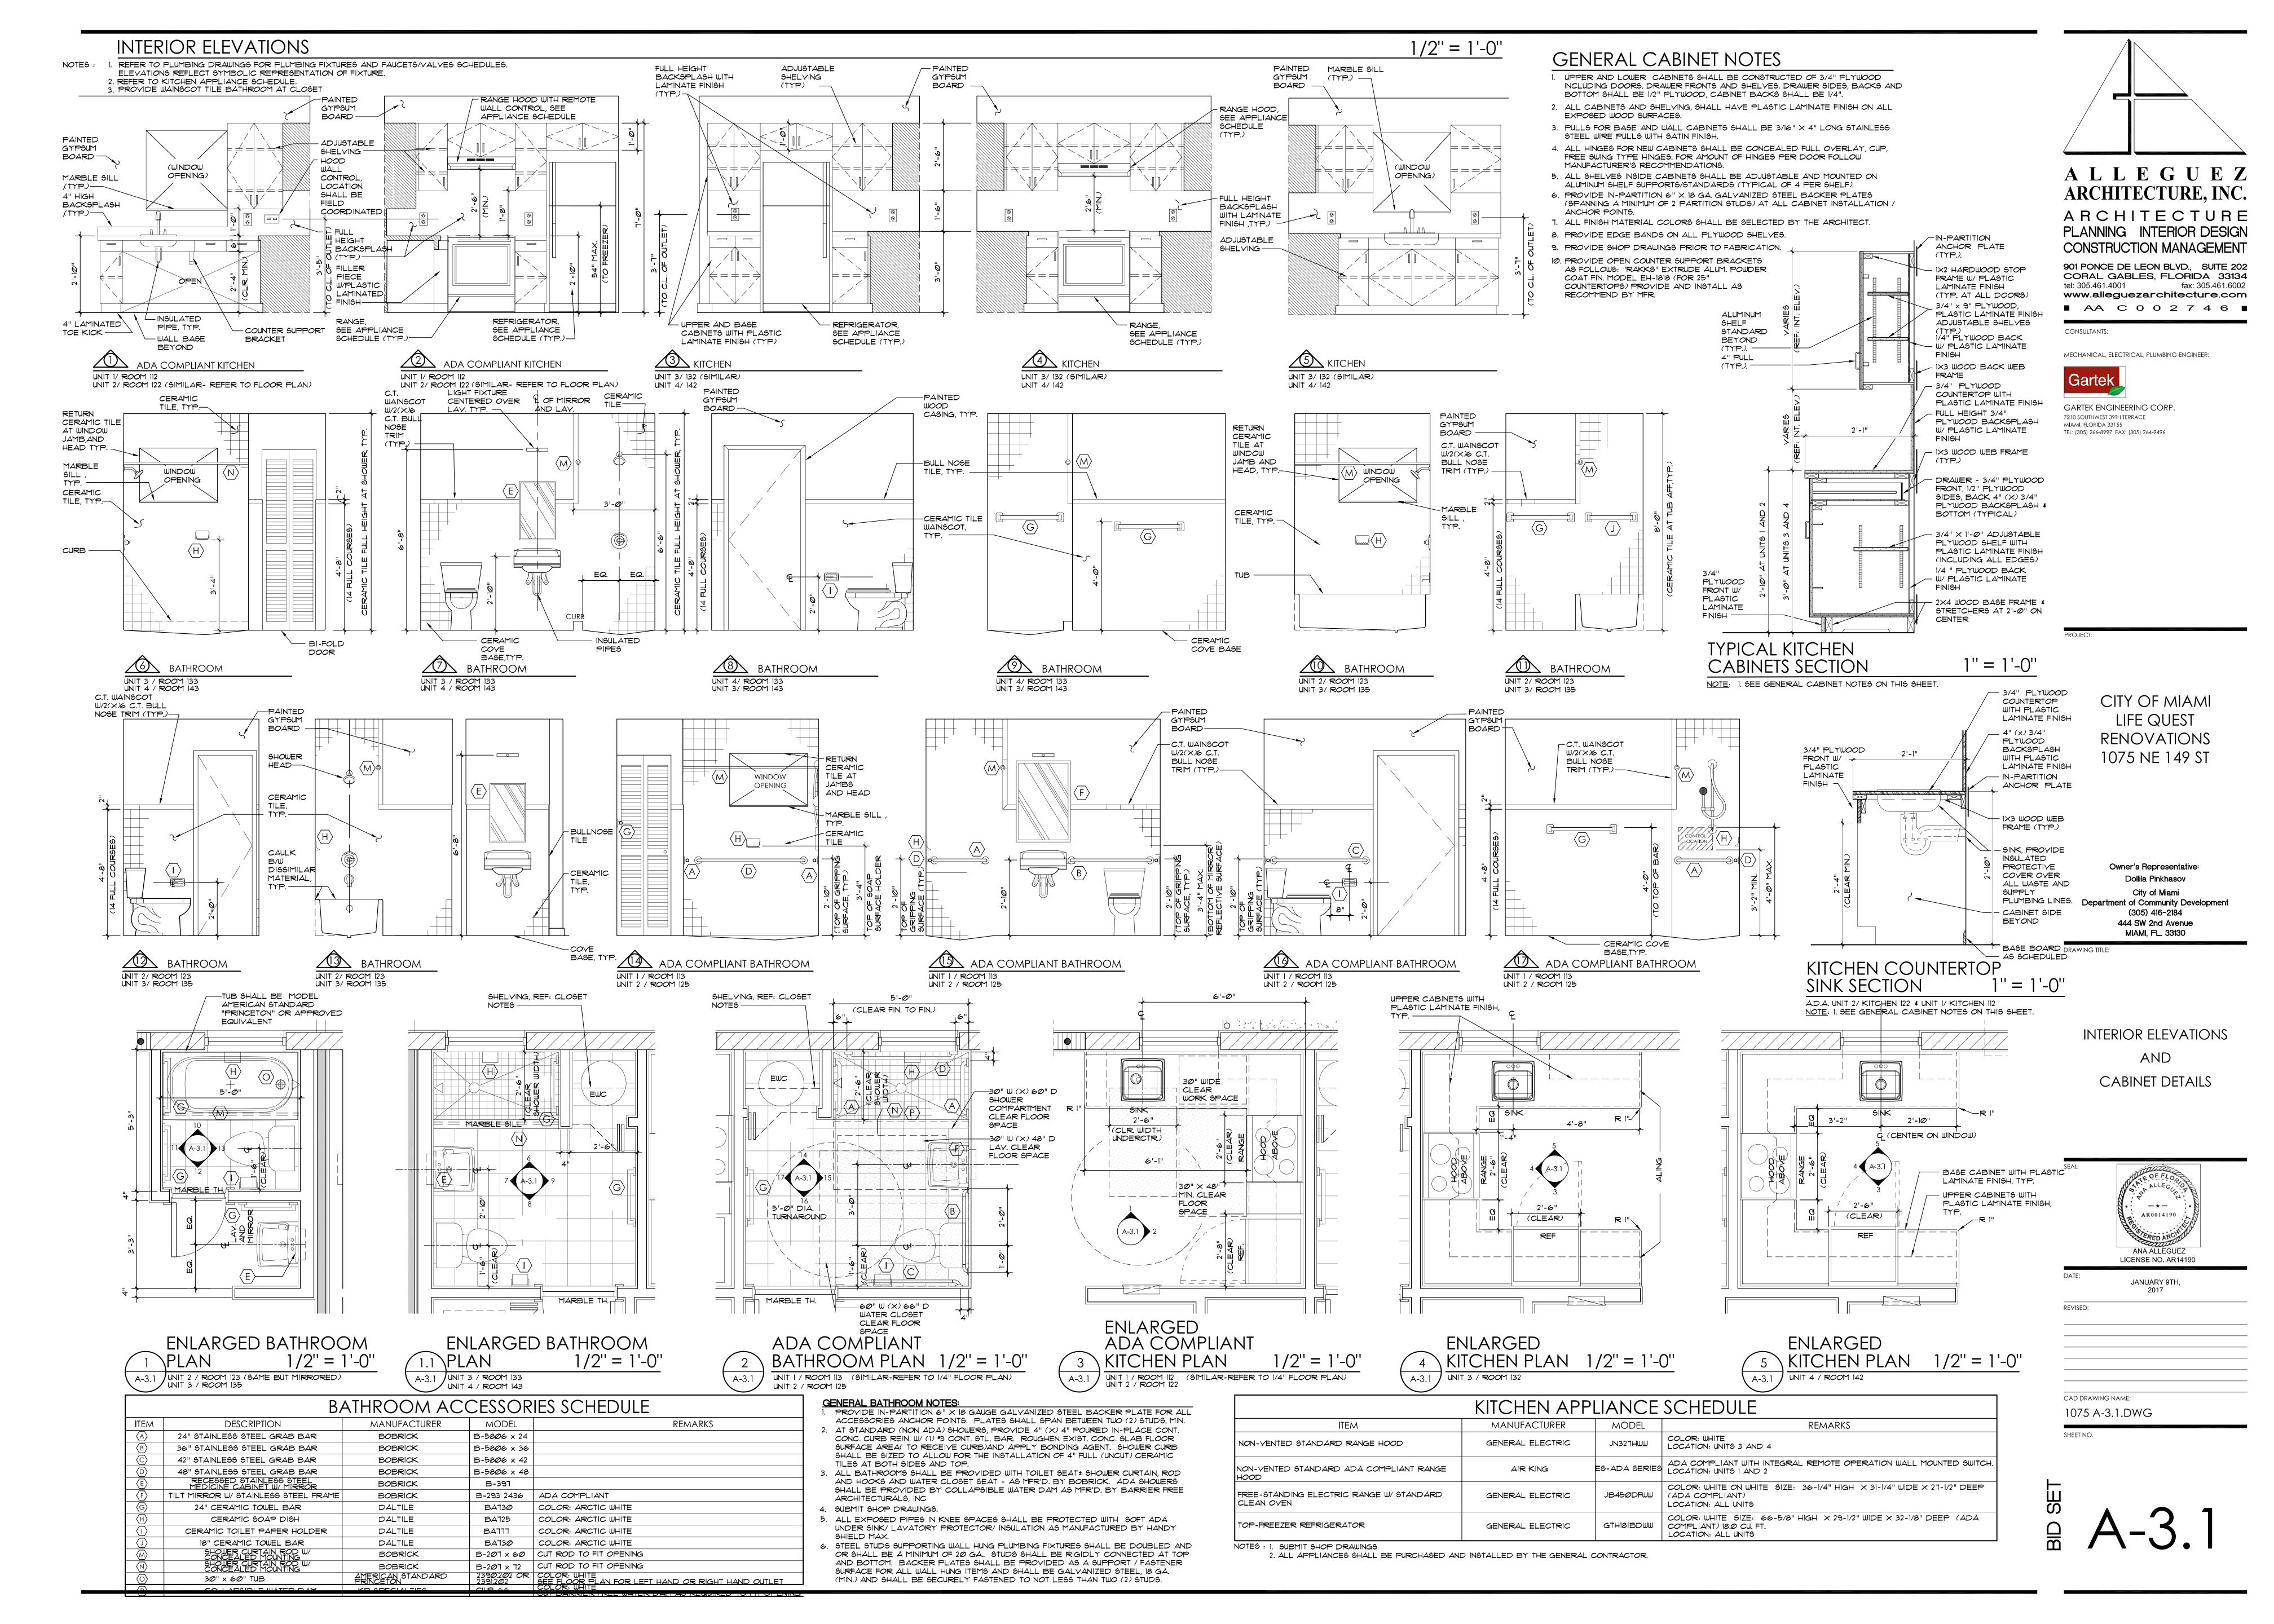

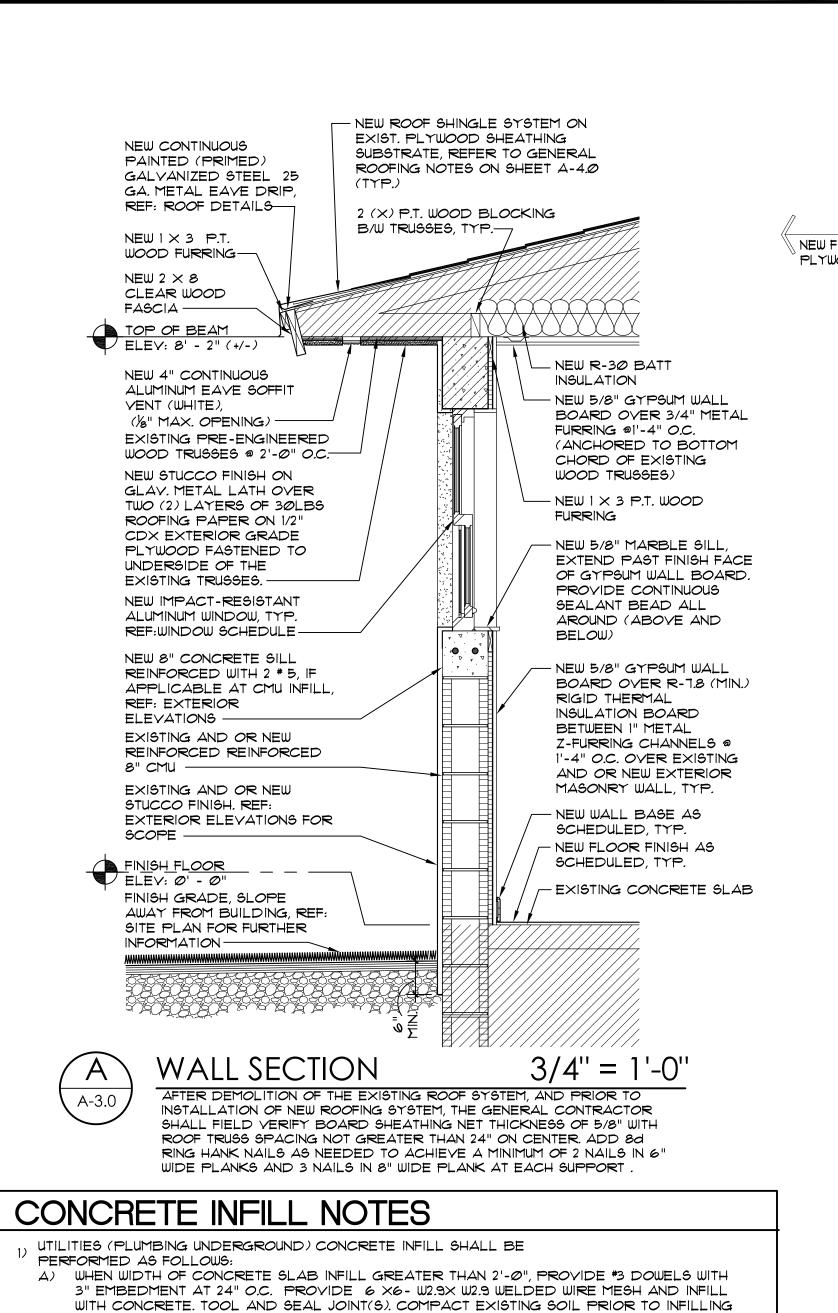


WITH CONCRETE. REPAIR VAPOR BARRIER

CONCRETE.

B) WHEN WIDTH OF CONCRETE SLAB INFILL LESS THAN 2'-0", ROUGHEN SIDES AND INFILL WITH CONCRETE, PROVIDE 6 X 6- w2.9X W2.9 WELDED WIRE MESH AND INFILL WITH CONCRETE. TOOL AND SEAL JOINT(S). COMPACT EXISTING SOIL PRIOR TO INFILING WITH PARTITION TYPES 1 1/2" = 1'-0" NOTE: 1. PROVIDE 3-5/8" METAL STUD BRACING TO A MINIMUM OF TWO ROOF TRUSSES (TRUSS 3. PROVIDE DOUBLED BACK TO BACK STUDS AT ALL PARTITION SEGMENTS ALONGSIDE WALL 6. PROVIDE CONTINUOUS FIRE SAFE SEALANT AND BACKER ROD AT ALL FIRE RATED AND BOTTOM CHORD, EACH SIDE OF PARTITION) - WHERE TRUSSES RUN PARALLEL TO THE HUNG CABINETS OR PLUMBING FIXTURES (IN ADDITION TO IN-PARTITION BACKER PLATES). SMOKE PARTITIONS. PARTITION (EXCLUDES PI). 4. PROVIDE 5/8" CEMENTITIOUS BOARD AT CERAMIC TILE LOCATIONS. PROVIDE 5/8" MOISTURE STENCIL WITH RED SPRAY PAINT (3" HIGH BLOCK LETTERS) " FIRE AND SMOKE BARRIER"

RESISTANT GYPSUM WALLBOARD ON SIDE OF PARTITIONS WITHIN BATHROOMS.

5. SEAL ALL PENETRATIONS WITH EQUIVALENT FIRE SAFING MATERIAL.

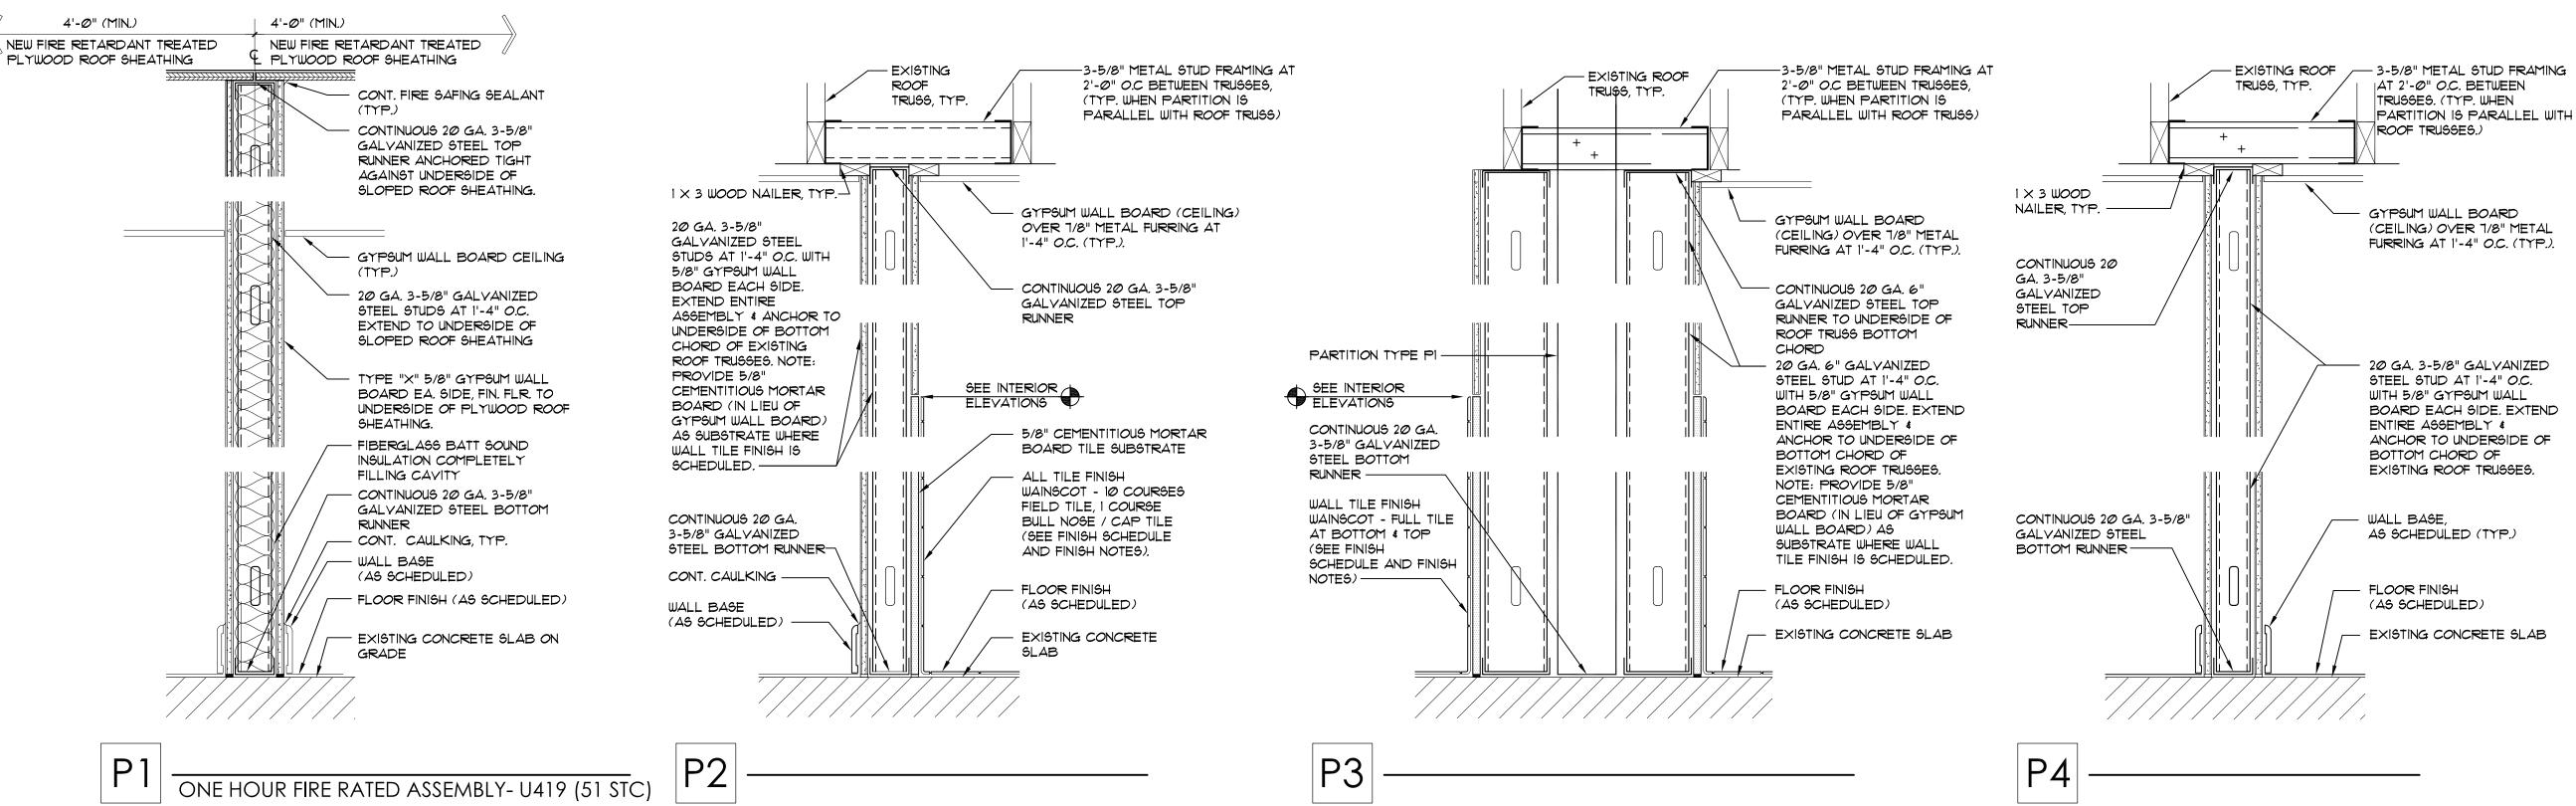

AT 20' O.C. MAX ABOVE CEILING. TYPICAL AT ALL FIRE AND SMOKE RATED BARRIERS/

SAME AS P3, BUT WITH (DUAL) 6" FRAME ASSEMBLIES

SAME AS P3, BUT WITH (SINGLE) 6" FRAME ASSEMBLY

TO TOP OF ASSEMBLY (IN LIEU OF MORTAR BOARD

PROVIDED WITH GYPSUM BOARD ONLY, FROM FLOOR

N.T.S.

FOR WAINSCOT).

FOR WAINSCOT).

PROVIDED WITH GYPSUM BOARD ONLY, FROM FLOOR TO TOP OF ASSEMBLY (IN LIEU OF MORTAR BOARD

ALLEGUEZ ARCHITECTURE, INC. ARCHITECTURE PLANNING INTERIOR DESIGN CONSTRUCTION MANAGEMENT 901 PONCE DE LEON BLVD., SUITE 202 CORAL GABLES, FLORIDA 33134 tel: 305.461.4001 fax: 305.461.6002 www.alleguezarchitecture.com ■ AA C 0 0 2 7 4 6 ■

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> CITY OF MIAMI LIFE QUEST

Owner's Representative: Dollila Pinkhasov City of Miami Department of Community Development (305) 416-2184 444 SW 2nd Avenue

DRAWING TITLE:

SAME AS P4, BUT WITH 6" METAL STUD FRAMING AT

PARTITION TYPES & WALL SECTION

-- * --AR0014190 ANA ALLEGUEZ

RENOVATIONS 1075 NE 149 ST

MIAMI, FL. 33130

LICENSE NO. AR14190 JANUARY 9TH, REVISED:

CAD DRAWING NAME: 1075 A-3.2.DWG



MORE THAN 450

 PI WITHIN TRUSS CAVITY SHALL BE PROVIDED WITH 5/8" TYPE "X" MOISTURE RESISTANT GWB (IN

LIEU OF STANDARD TYPE "X" GWB) + OMIT

INTERIOR FINISHES & INSULATION CLASSIFICATIONS

INSULATION MATERIALS SHALL HAVE A FLAME SPREAD INDEX OF

NOT MORE THAN 25 AND A SMOKE-DEVELOPED INDEX OF NOT

INTERIOR WALL AND CEILING FINISH SHALL BE CLASS C.

2. PROVIDE IN-PARTITION 6" (X) 18 GAUGE GALVANIZED STEEL BACKER PLATES, SPANNING A

MINIMUM OF TWO STUDS, AT ALL WALL MOUNTED ACCESSORIES / DEVICE / EQUIPMENT

PROVIDE INFILL VERTICAL REINFORCING OF # 5 @ 32", TYP. REINFORCE ALL HEADERS AND SILLS AT NEW OPENINGS DOWEL BARS 5" INTO EXISTING HEADER AND SLAB. SAWCUT LONGER THAN 24" WITH 2#5. DOWEL BARS INTO EXISTING JAMB 6". GROUT HEADER OR SILL SOLID FOR ENTIRE LENGTH OF FACE SHELLS AS NEEDED TO COMPLETE INFILL. -EXISTING OPENING. MASONRY NOTES: THE CONTRACTOR SHALL USE 50% SOLID, NOMINAL 8X8X16 INVESTIGATE IF EXIST CMU - BREAK FACE CONCRETE MASONRY UNITS JAMB CELLS ARE FILLED. SHELLS ABOVE ____|_ || _ _ _ _ _ _ || _ _ _ _ || _ _ _ || _ _ || _ || _ _ _ _ _ _ CONFORMING TO ASTM C90 WITH A IF IT IS DETERMINED THAT NEW OPENING BLOCK NET AREA COMPRESSIVE JAMB CELLS ARE NOT HEADER TO STRENGTH OF 1900 PSI AND I'M OF FILLED, AFFECTED FACE GROUT HEADER 1500 PSI. DETERMINE COMPRESSIVE SHELLS SHALL BE SAW CUT ╵┢╛╛╛╝╸═╦╧╧╉┼╟┈ PRIOR TO STRENGTH BY THE UNIT TEST METHOD OPENED, REINFORCED W/1#5 2'-4" || CUTTING OR PRISM METHOD. LAY UNITS IN VERT. AND FILLED SOLID OPENING. RUNNING BOND. SAWCUT UNITS WHICH MAX II WITH CONC. GROUT. ╬╼╼╦╼╼╩╼╼╬╬╬╳ ARE NOT MULTIPLES OF 8". UNITS GROUT HEADERS, SILLS, SHALL BE AT LEAST 8" LONG. AND JAMBS SOLID FOR - REINFORCE ONE COURSE AROUND ALL USE TYPE "S" MORTAR IN JAMBS W/1#5 NEW OPENINGS. ACCORDANCE WITH ASTM C270. CENTERED IN HEAD AND BED JOINTS SHALL BE 3/4 CELL. EXTEND FOR THE THICKNESS OF THE FACE VERTICAL REINFORCE ALL JAMBS SHELL. WEBS ARE TO BE FULLY REINFORCING 32" WITH 1 #5 ---DRILL 1/6" Ø HOLE AT EVERY OTHER BLOCK MORTARED WHERE AN ADJACENT ABOVE AND CELL IS TO BE GROUTED. BELOW OPENING. COURSE AND DRIVE *3 BAR DOWEL 5" IF PROVIDE STANDARD 9-GUAGE BEAM IS ABOVE CONSTRUCTION SEQUENCE: HORIZONTAL JOINT REINFORCING IN OR SLAB BELOW. EVERY OTHER COURSE. JOINT SAWCUT FACE SHELLS REINFORCING SHALL CONFORM TO ASTM A 153 CLASS B2, WITH A AT JAMBS AND COATING THICKNESS OF 1.5 oz/sf. REINFORCE. < ∕ ╢ ─ ┡ ─╟─ ─ ─ ─ ─ ╫ ─ ─ ─ ─ ┡ ╢ ─ ─ ─ ─ BREAK FACE SHELLS USE FINE GROUT CONFORMING TO ASTM C-476 WITH A MINIMUM ABOVE LOCATION OF COMPRESSIVE STRENGTH OF 2500 PSI NEW OPENING. IN 28 DAYS, PROVIDE CLEANOUT BLOCK UNFILLED OPENINGS AT THE BASE OF CELLS CONTAINING REINFORCING STEEL TO VERTICAL CELLS CLEAN THE CELL OF DEBRIS AND BELOW THE SILL. MORTAR CHIPS. 4. GROUT NEW JAMBS, REINFORCED MASONRY WALL HEADER, AND SILL. CONSTRUCTION SHALL BE INSPECTED BY AN ENGINEER OR ARCHITECT IN 5. SAWCUT NEW OPENING ACCORDANCE WITH ACI 530.1/ASCE 6. REMOVE BLOCK.


SAME AS P2, BUT TILE AND 5/8" CEMENTITIOUS


BOARD ON BOTH SIDES.


INTO HOLE. HOOK BAR UP INTO SECOND CELL (TYP). MASONRY INFILL AT EXISTING MASONRY WALL OPENINGS

MASONRY OPENINGS

AT EXISTING MASONRY WALL

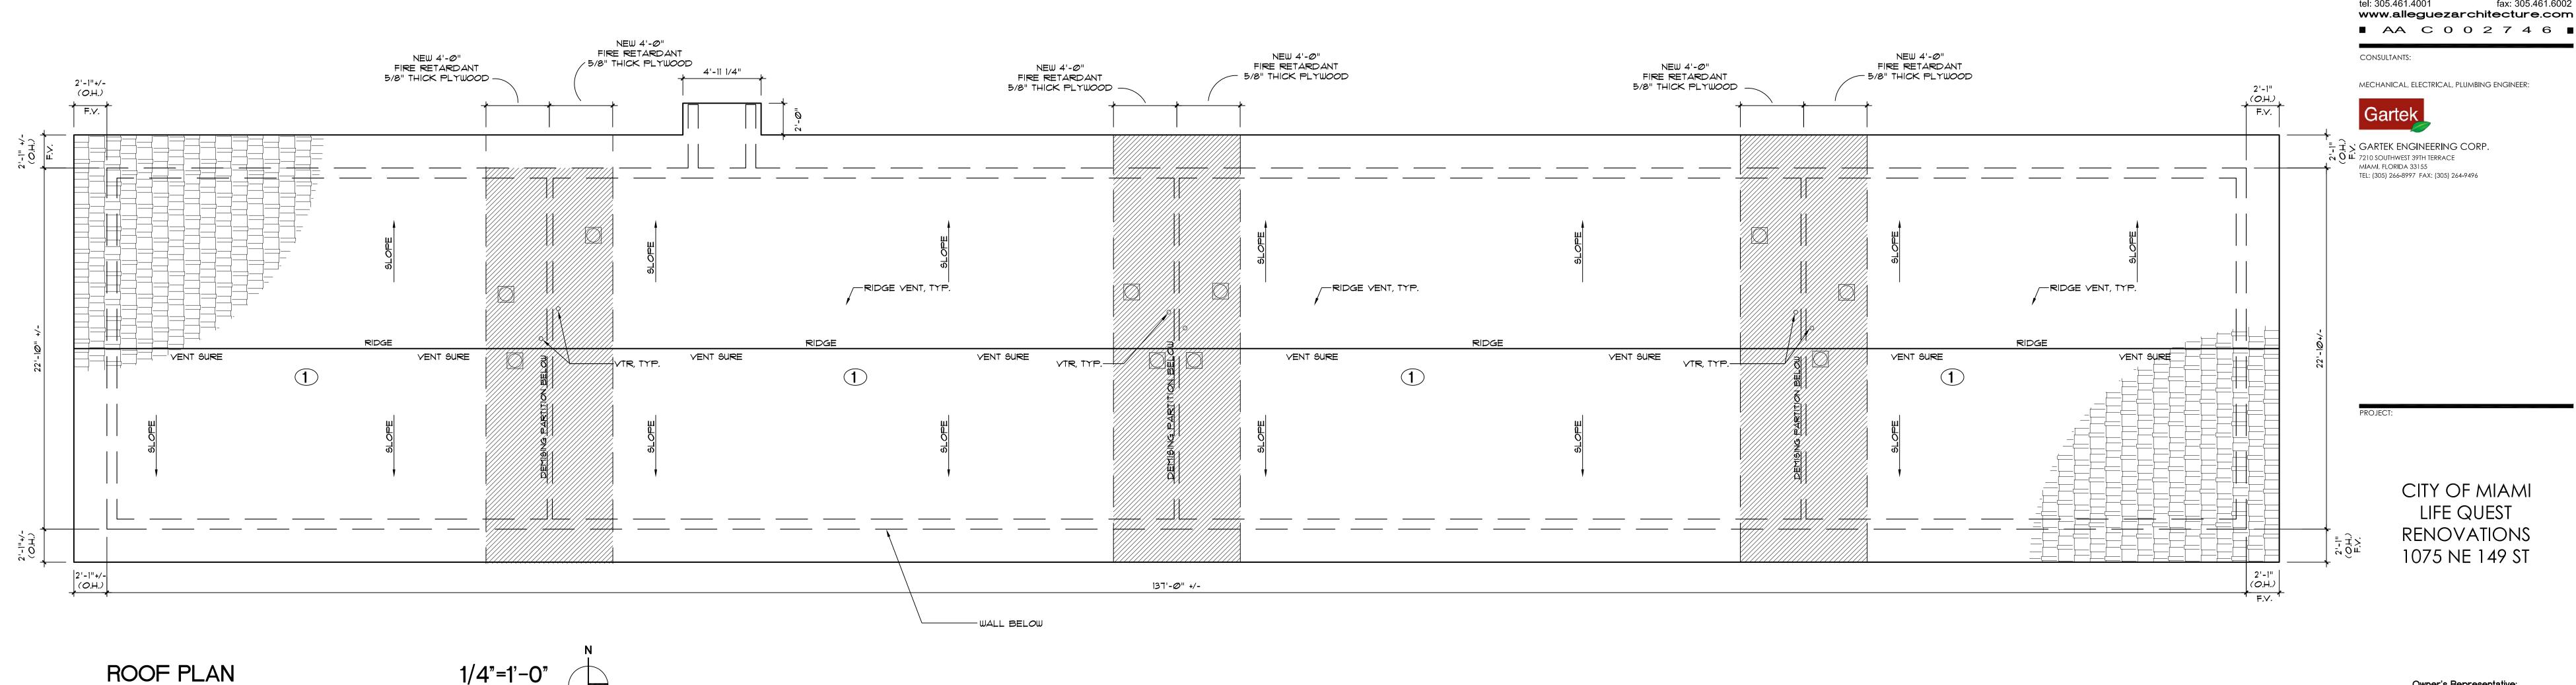

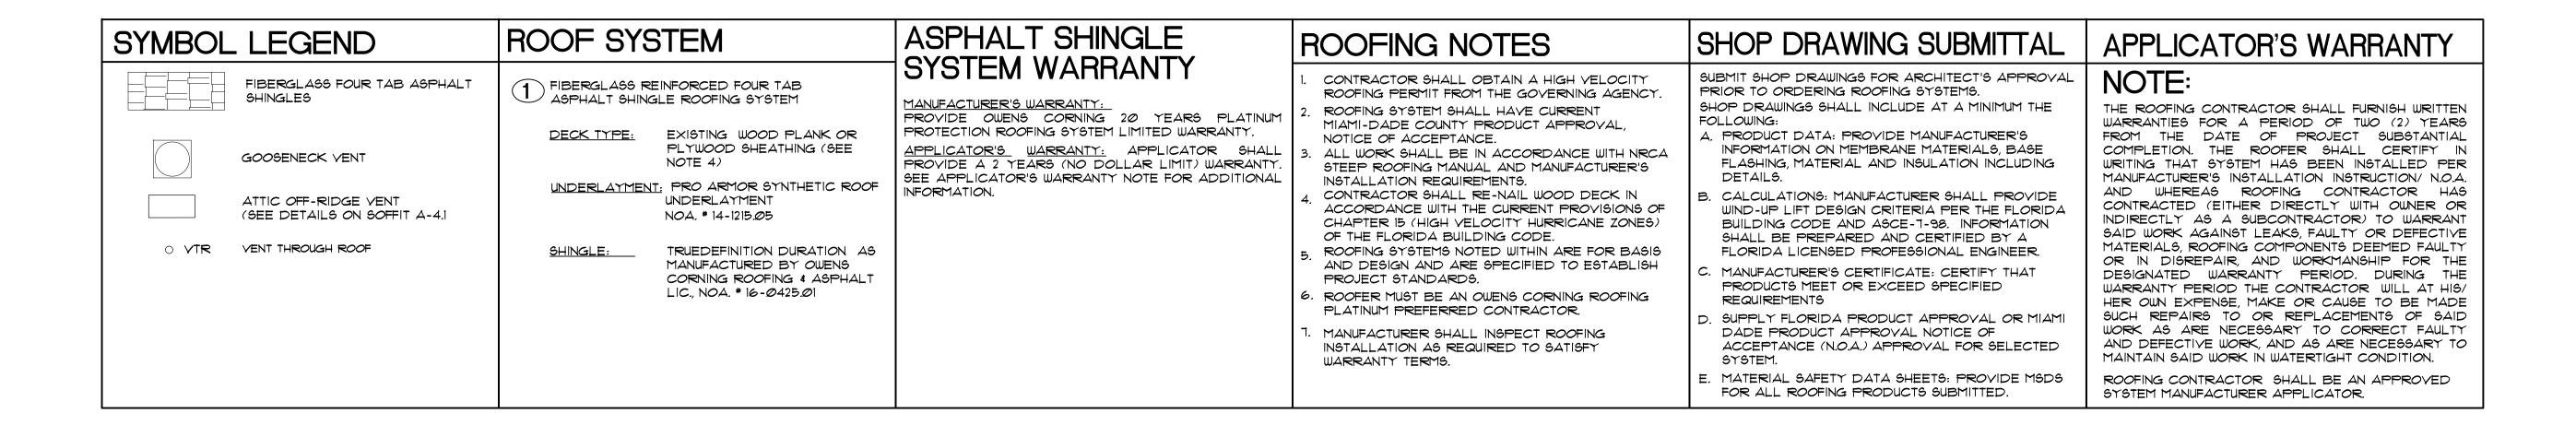

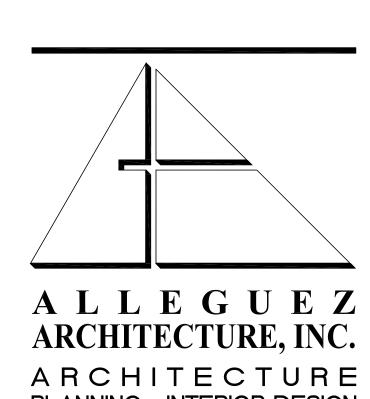

PLANNING INTERIOR DESIGN CONSTRUCTION MANAGEMENT 901 PONCE DE LEON BLVD., SUITE 202 CORAL GABLES, FLORIDA 33134 tel: 305.461.4001 fax: 305.461.6002 www.alleguezarchitecture.com

CONSULTANTS:

MECHANICAL, ELECTRICAL, PLUMBING ENGINEER:



- 式 y GARTEK ENGINEERING CORP. 7210 SOUTHWEST 39TH TERRACE MIAMI, FLORIDA 33155 TEL: (305) 266-8997 FAX: (305) 264-9496


> CITY OF MIAMI LIFE QUEST RENOVATIONS 1075 NE 149 ST

Owner's Representative: Dollila Pinkhasov City of Miami Department of Community Development (305) 416-2184 444 SW 2nd Avenue

MIAMI, FL. 33130


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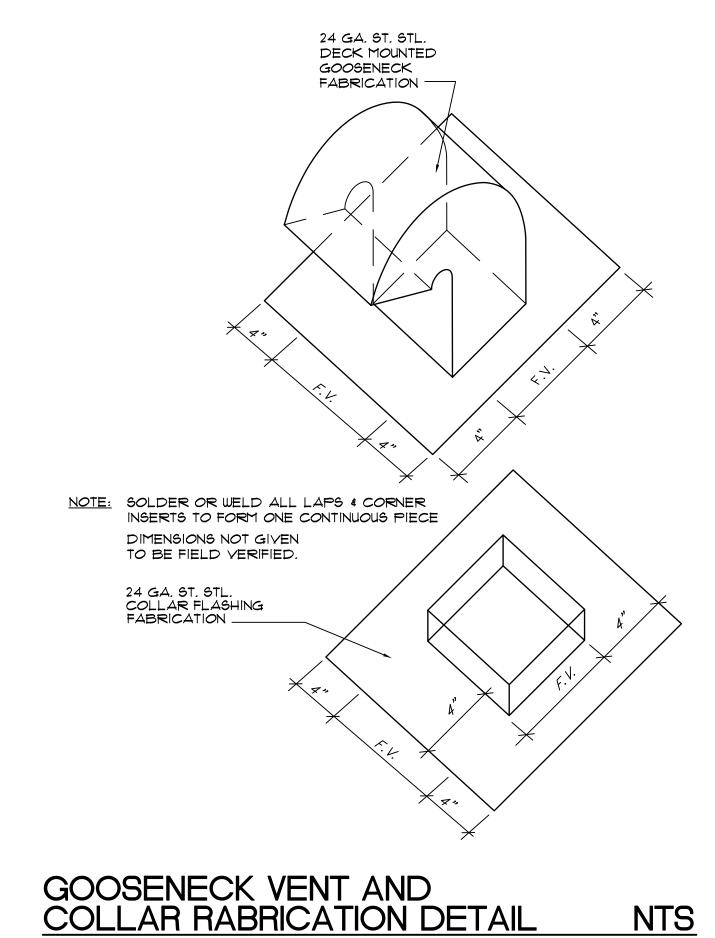
ROOF PLAN

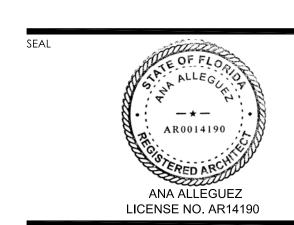

JANUARY 9TH, REVISED:

CAD DRAWING NAME: 1075 A-4.0.DWG



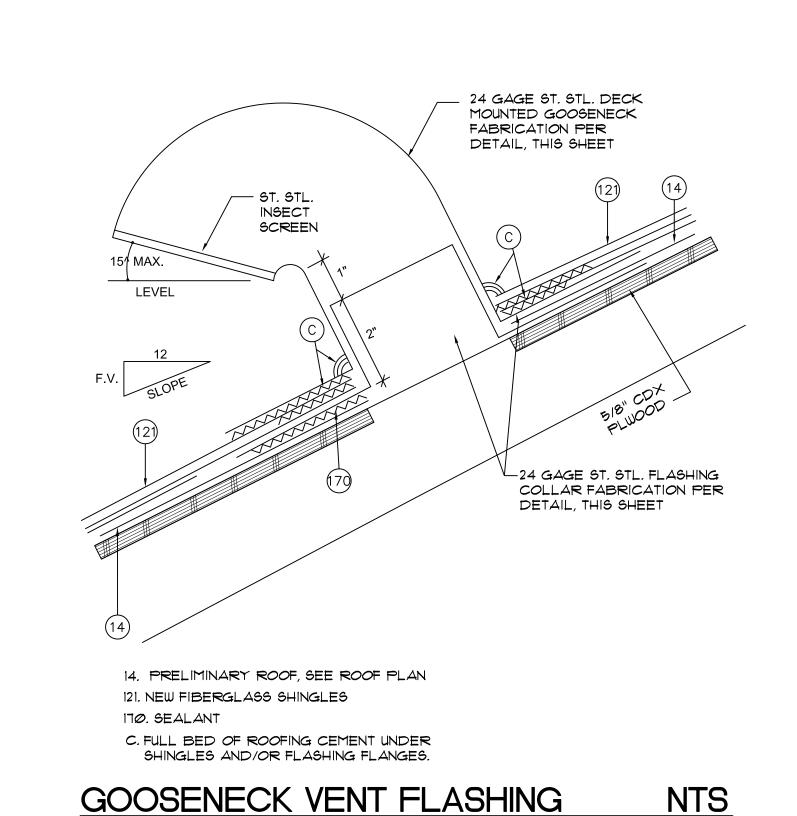


NTS


NTS

MATCH ROOF SLOPE IF A VERTICAL FASCIA IS REQUIRED


NTS

EAVE DRIP FABRICATION DETAIL

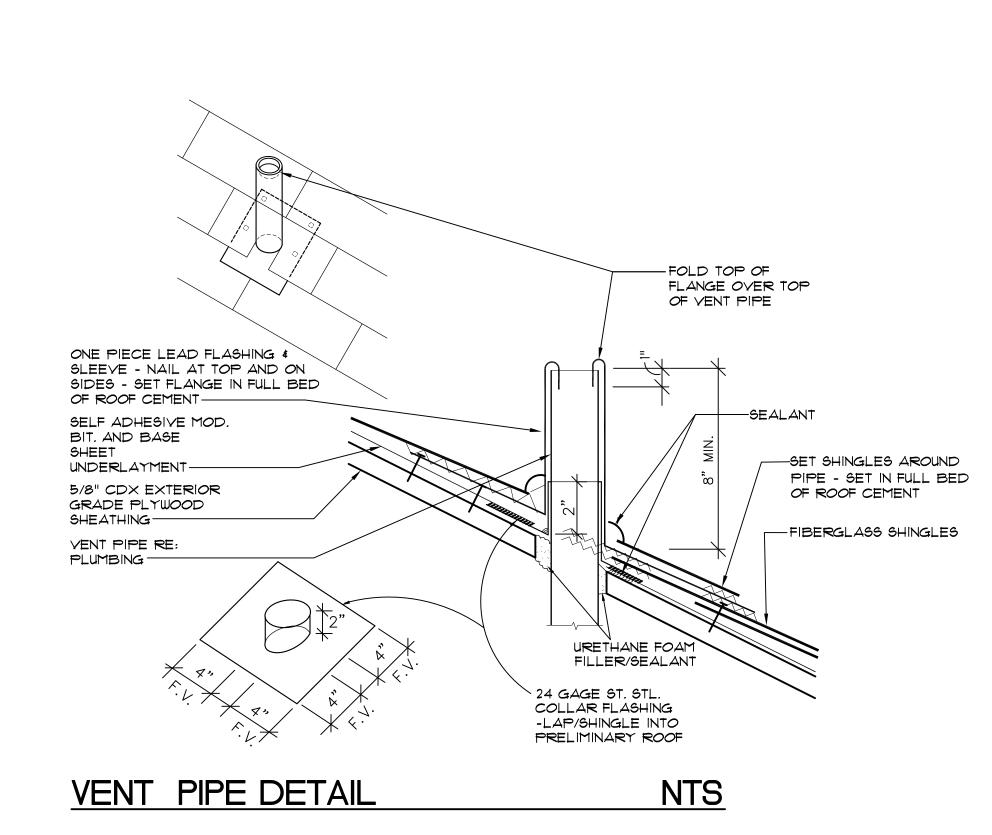

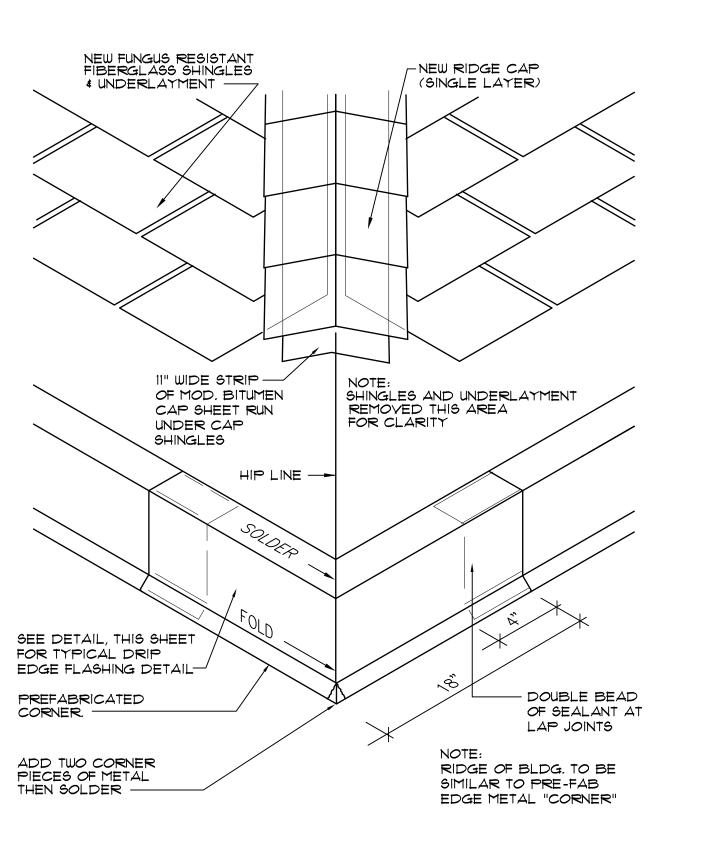



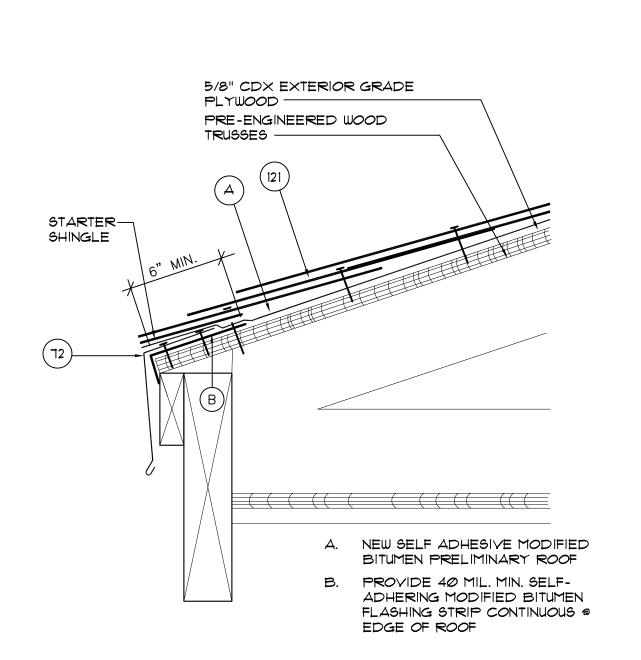

72. EDGE METAL - SEE DETAIL, THIS SHEET. 121. FUNGUS RESISTANT FIBERGLASS SHINGLES NOTE: FASTENERS FOR EDGE METAL TO BE 1-1/4" RING SHANK ST STL ROOFING NAIL AT 4" O.C. (2 ROWS STAGGERED AT 3/4" FROM EDGE OF FLANGE)

DRIP EDGE FLASHING

ARCHITECTURE, INC. ARCHITECTURE PLANNING INTERIOR DESIGN CONSTRUCTION MANAGEMENT

ALLEGUEZ

901 PONCE DE LEON BLVD., SUITE 202 CORAL GABLES, FLORIDA 33134 tel: 305.461.4001 fax: 305.461.6002 www.alleguezarchitecture.com ■ AA C 0 0 2 7 4 6 ■

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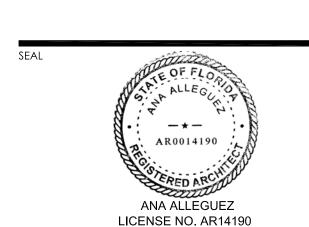
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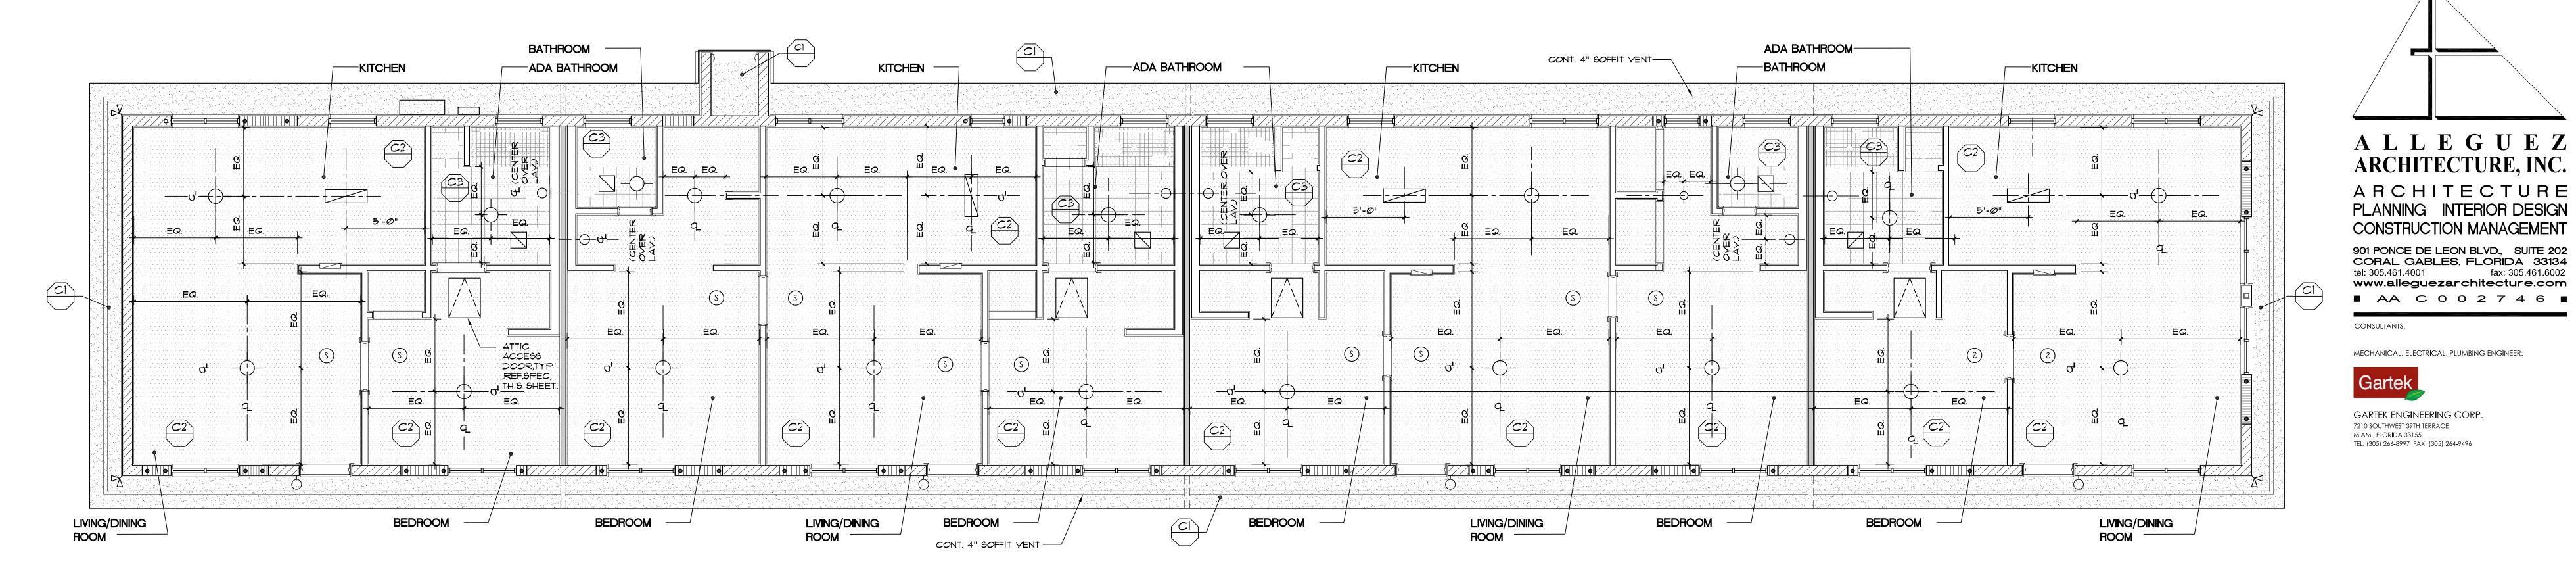
ROOF DETAIL



JANUARY 9TH,

REVISED:

CAD DRAWING NAME: 1075 A-4.1.DWG



REFLECTED CEILING PLAN

ROOMS/AREAS.)


NOTE(S): 1. PROVIDE R-30 BATT INSULATION ABOVE CEILING (ALL

2. COORDINATE LIGHT FIXTURE PLACEMENT WITH EXISTING

CEILING MOUNTED LIGHT CEILING MOUNTED LIGHT EXHAUST FAN WALL MOUNTED LIGHT WALL MOUNTED LIGHT SMOKE DETECTOR ATTIC DOOR, SEE ATTIC ACCESS SPECIFICATION, THIS SHEET DRYWALL CEILING PLASTER/STUCCO

BATHROOM EXHAUST

SYMBOL LEGEND

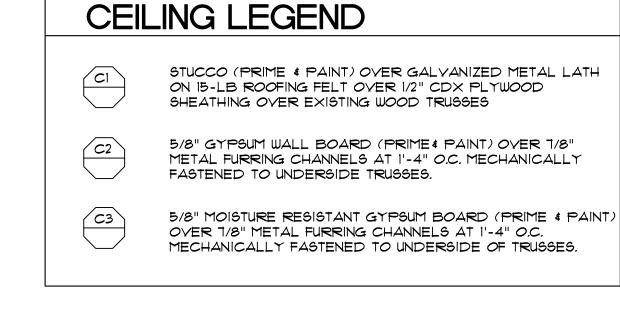

ATTIC ACCESS SPECIFICATION

MANUFACTURED: BATTIC DOOR ENERGY CONSERVATION PRODUCTS OR APPROVED EQUIVALENT. MODEL:DELUXE E-2 HATCH ATTIC ACCESS SCUTTLE DOOR SIZE: 22"X30" (FITS INTO 22 1/2" X 30 1/2" ROUGH OPENING NOTE: ATTIC ACCESS DOOR SHALL BE PROVIDED WITH 4-POINT LOCKING LATCH \$ HANDLES


CITY OF MIAMI LIFE QUEST RENOVATIONS 1075 NE 149 ST


fax: 305.461.6002


Owner's Representative: Dollila Pinkhasov City of Miami Department of Community Development (305) 416-2184 444 SW 2nd Avenue MIAMI, FL. 33130


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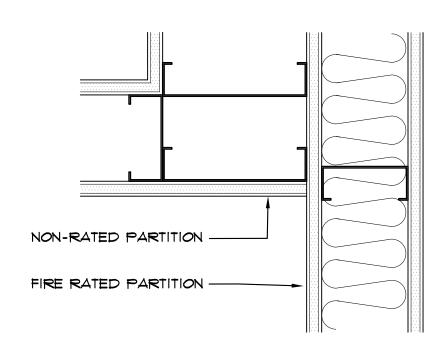
REFLECTED CEILING PLAN



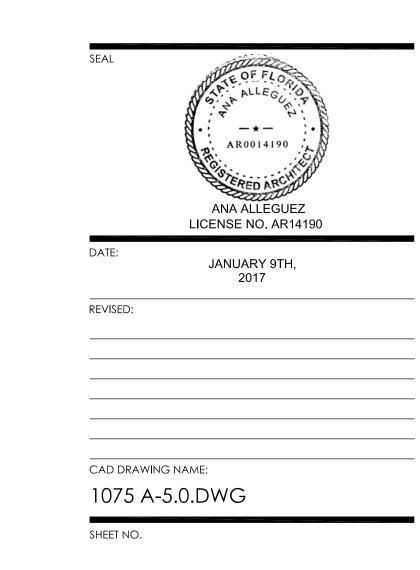

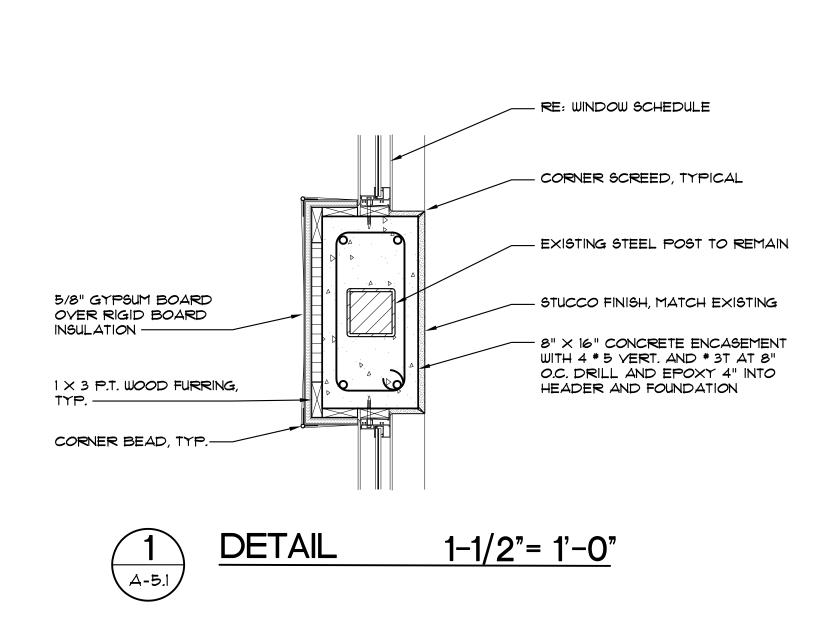


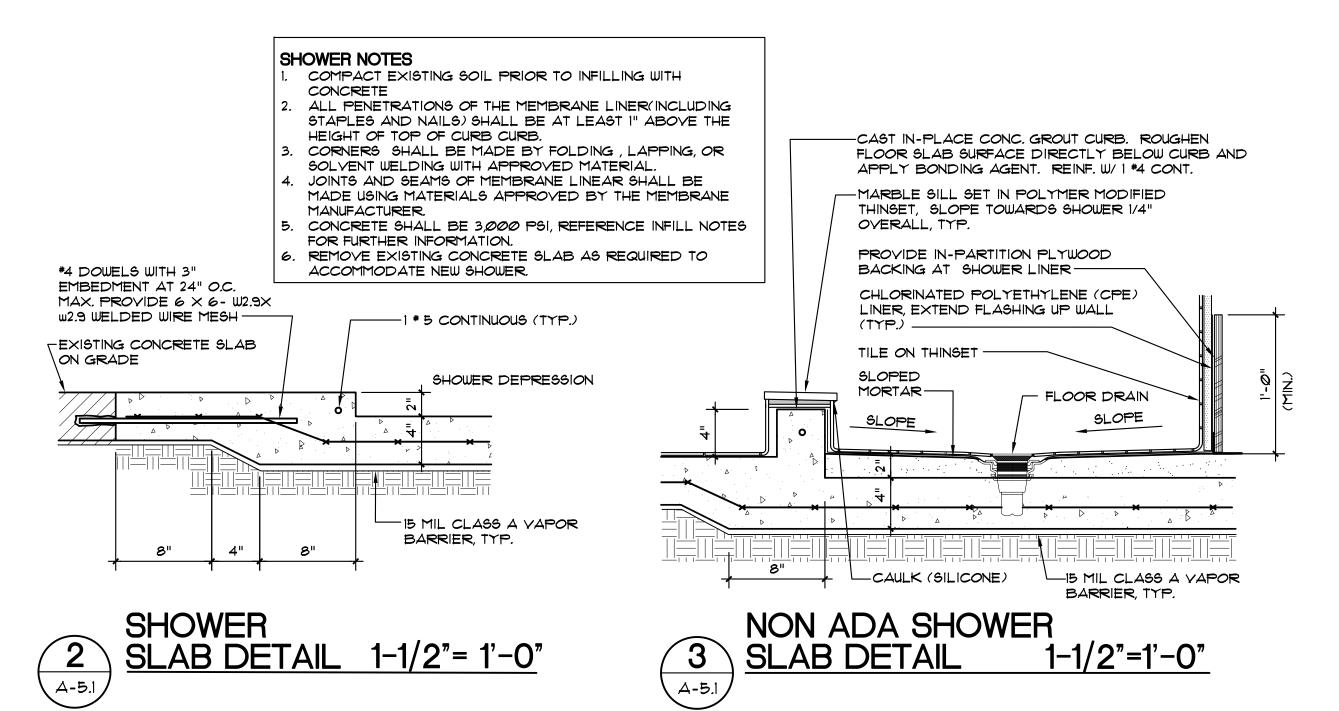

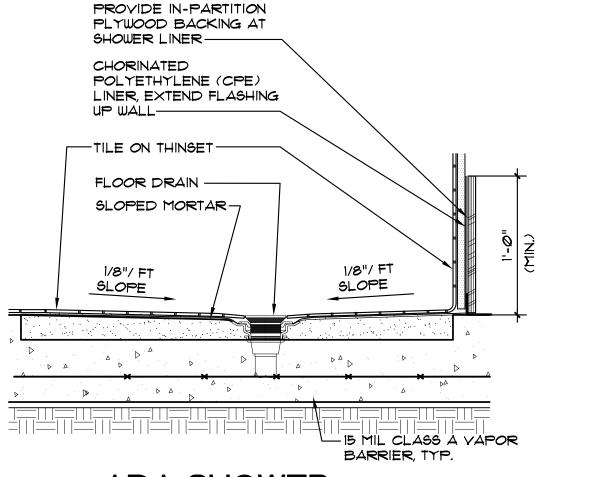





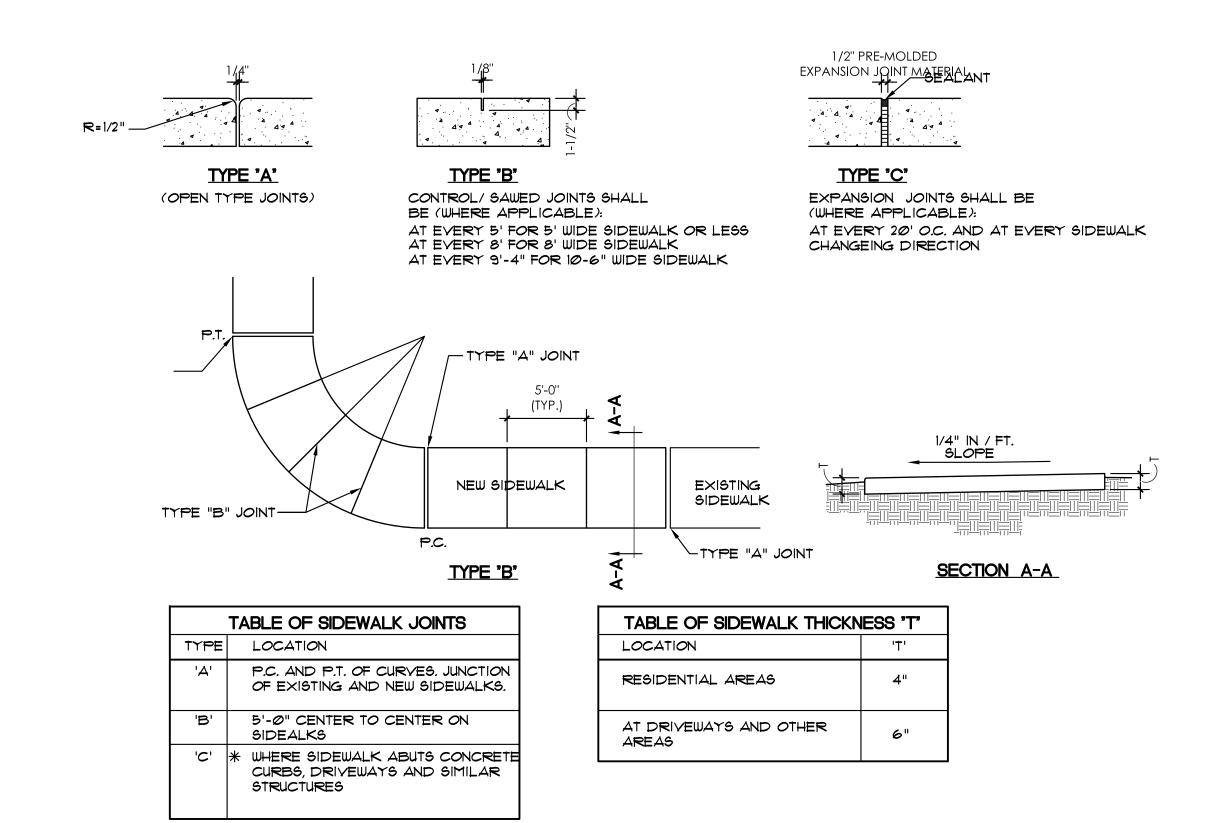

CONCRETE SIDEWALK

NTS

A L L E G U E Z ARCHITECTURE, INC. ARCHITECTURE

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PROJECT

CITY OF MIAMI LIFE QUEST RENOVATIONS 1075 NE 149 ST

Owner's Representative:

Dollila Pinkhasov

City of Miami

Department of Community Development


(305) 416-2184

444 SW 2nd Avenue

MIAMI, FL. 33130

DRAWING TITLE:

MISCELLANEOUS DETAILS

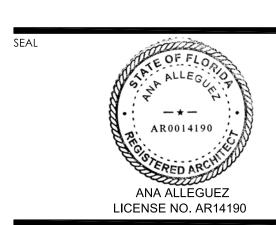

DATE:

JANUARY 9TH,
2017

JANUARY 9T 2017 REVISED:


CAD DRAWING NAME: 1075 A-5.1.DWG

Δ_5

LUMINAIRE SCHEDULE Symbol Label Catalog Number Lumens LLF Watts Description Lamp ONE 175-WATT CLEAR LITHONIA Area Luminaire, 175W 14400 0.75 208 LIGHTING KAD MH, High Performance BT-28 METAL HALIDE, 175M SR3 POLE SR3 Reflector, Full Cutoff HORIZONTAL POSITION. MEETS THE 'NIGHTTIME MTD. 15' A.G.

STATISTICS						
Description	Symbol	Avg	Max	Min	Max/Min	Avg/Min
PARKING AREA 1 (1075)	+	2.8 fc	5.7 fc	1.0 fc	5.7:1	2.8:1

FRIENDLY' CRITERIA

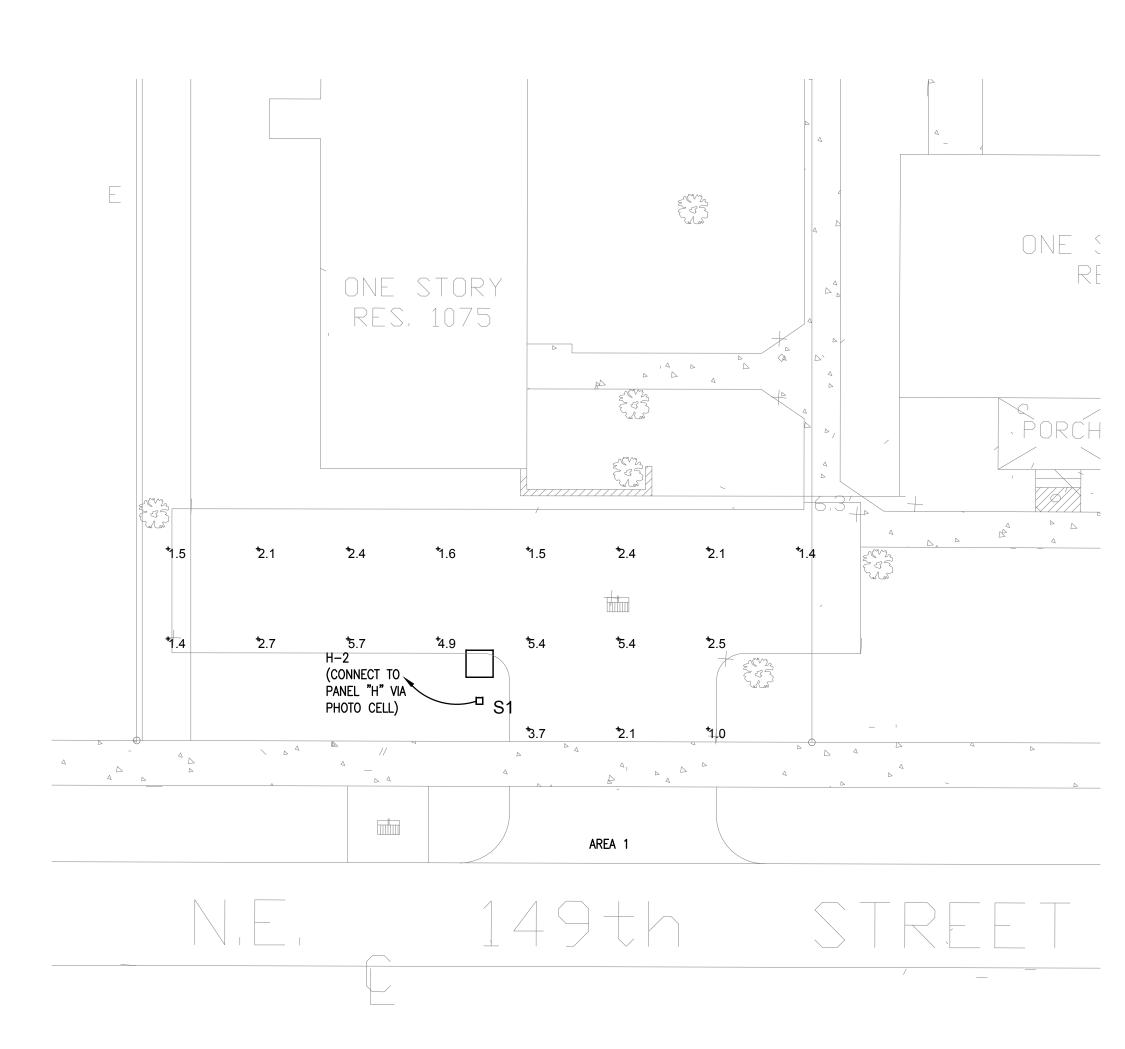

SITE PLAN PARKING AREA LIGHTING SC: 1'0" = 3/32

A. DRAWINGS. THE DRAWINGS ARE TO BE CONSIDERED DIAGRAMMATIC, NOT NECESSARILY SHOWING IN DETAIL OR TO SCALE ALL OF THE MINOR ITEMS. UNLESS SPECIFIC DIMENSIONS ARE SHOWN, THE STRUCTURAL, ARCHITECTURAL, AND SITE CONDITIONS SHALL GOVERN THE EXACT LOCATIONS. CONTRACTOR SHALL FOLLOW DRAWINGS IN LAYING OUT WORK, CHECK DRAWINGS OF ALL TRADES TO VERIFY SPACES IN WHICH WORK WILL BE INSTALLED. WHERE HEADROOM OR SPACE CONDITIONS APPEAR INADEQUATE, CONTRACTOR SHALL, WITHOUT EXTRA CHARGE, MAKE FIELD MODIFICATION IN LAYOUT AS NEEDED TO PREVENT CONFLICT WITH WORK OF VARIOUS TRADES OR FOR PROPER EXECUTION OF THE WORK. SITE CONDITIONS SHALL GOVERN THE EXACT LOCATION OF ALL ELECTRICAL EQUIPMENT, DEVICES, WIRING, CONDUIT, ETC.

I. GENERAL REQUIREMENTS

ONE COMPLETE SET OF DRAWINGS AND SPECIFICATIONS SHALL BE KEPT ON FILE AT THE SITE FOR THE SOLE USE OF MARKING AS-BUILT DATA. ALL CHANGES SHALL BE MARKED IN RED ON PRIOR TO EACH REQUISITION FOR PAYMENT, AS-BUILT PRINTS SHALL BE BROUGHT UP TO DATE FOR ACCEPTANCE BY OWNER'S REPRESENTATIVE. THE COMPLETED SET OF AS-BUILT PRINTS SHALL BE DELIVERED TO THE ARCHITECT/ENGINEER PRIOR TO FINAL PAYMENT FOR INCORPORATION ONTO ORIGINALS. RISERS ARE DIAGRAMMATIC AND DON'T INTEND TO SHOW EVERY BEND REQUIRED FOR THE INSTALLATION. B. COORDINATION. CONTRACTOR WILL BE REQUIRED TO FURNISH, INSTALL AND/OR CONNECT WITH APPROPRIATE SERVICES ALL ELECTRICAL ITEMS SHOWN ON ANY OF THE ARCHITECTURAL, PLUMBING, AIR CONDITIONING SPRINKLER, INTERIOR DESIGN AND ELECTRICAL DRAWINGS WITHOUT ADDITIONAL EXPENSE TO THE OWNER. IF DISCREPANCIES, CONFLICTS, INTERFERENCES OR OMISSIONS OCCUR BETWEEN DRAWINGS, NOTIFY IN WRITING THE ARCHITECT/ENGINEER IN AMPLE TIME TO PERMIT REVISIONS BEFORE THE BIDS ARE

ELECTRICAL CONTRACTOR SHALL COORDINATE THE REQUIREMENTS OF PLUG AND CHORD TYPE EQUIPMENT WITH MANUFACTURER AND IS REQUIRED TO PROVIDE ELECTRICAL OUTLETS THAT WILL ACCEPT MANUFACTURER'S SUPPLIED PLUGS.

SEE MECHANICAL DRAWINGS FOR ELECTRICAL REQUIREMENTS AND LOCATION OF A/C UNITS AND ALL OTHER MECHANICAL EQUIPMENT (SOLENOIDS, VAV'S, THERMOSTATS, PUMPS, FANS, SMOKE DETECTORS, DUCT HEATERS, ETC.) THE CONTRACTOR SHALL PROVIDE ALL BRANCH CIRCUIT AND CONTROL WIRING AS INDICATED OR REQUIRED AND IN CONFORMANCE WITH N.E.C. ARTICLE 440 AND MANUFACTURER'S RECOMMENDATIONS. ALL PENETRATIONS SHALL BE MADE WEATHERPROOF DURING CONSTRUCTION AND AFTER FINAL INSTALLATION. A/C
EQUIPMENT WIRING, BREAKERS, AND FUSES ARE BASED ON A/C EQUIPMENT SPECIFIED ON
CONTRACT DRAWINGS. CONTRACTOR IS RESPONSIBLE FOR PROVIDING ALL WIRING, AND OVERCURRENT PROTECTION REQUIREMENTS IF EQUIPMENT USED IS DIFFERENT FROM THAT SPECIFIED. CONTRACTOR SHALL MAKE THESE CHANGES AT NO ADDITIONAL COST TO THE

C. PERMITS. THE CONTRACTOR SHALL SECURE AND PAY FOR ALL PERMITS, STATE SALES TAX, FEDERAL EXCISE TAX, ROYALTIES AND OTHER TAXES OR FEES AS REQUIRED FOR INSTALLATION OF A COMPLETE SYSTEM AS OUTLINED HEREIN AND AS SHOWN ON THE PLANS. D. BASIS FOR BIDS. EQUIPMENT SPECIFIED SHALL BE ADHERED TO. HOWEVER, OWNER HAS FINAL DECISION ON THE TYPE AND QUALITY OF EQUIPMENT TO BE SUPPLIED. WITHIN 30-DAYS AFTER THE CONTRACT HAS BEEN EXECUTED, A FORMAL REQUEST FOR THE SUBSTITUTION OF PRODUCTS IN PLACE OF THOSE SPECIFIED WILL BE CONSIDERED, UNDER THE

THE REQUEST IS ACCOMPANIED BY COMPLETE DATA ON THE PROPOSED SUBSTITUTION SUBSTANTIATING COMPLIANCE WITH THE CONTRACT DOCUMENTS INCLUDING PRODUCT IDENTIFICATION AND DESCRIPTION, PERFORMANCE AND TEST DATA, REFERENCES AND SAMPLES WHERE APPLICABLE, AND AN ITEMIZED COMPARISON OF THE PROPOSED SUBSTITUTION WITH THE PRODUCTS SPECIFIED, WITH DATA RELATING TO CONTRACT TIME SCHEDULE, DESIGN AND AESTHETIC EFFECT WHERE APPLICABLE. THE REQUEST IS ACCOMPANIED BY ACCURATE COST DATA ON THE PROPOSED SUBSTITUTION IN COMPARISON WITH THE PRODUCT SPECIFIED, WHETHER OR NOT MODIFICATION OF THE CONTRACT SUM IS TO BE A CONSIDERATION. IF REDESIGN BY THE ARCHITECT OR HIS CONSULTANTS IS REQUIRED TO ACCOMMODATE AN ALTERNATE PRODUCT OR SYSTEM, ALL COSTS OF THIS REDESIGN SHALL BE BORNE BY THE CONTRACTOR REQUESTING THE CHANGE. IF ADDITIONAL WORK IS REQUIRED BY OTHER CONTRACTORS TO ACCOMMODATE AN ALTERNATE PRODUCT OR SYSTEM, ALL ADDITIONAL COSTS OF THIS WORK SHALL BE BORNE BY THE CONTRACTOR BEOLIESTING THE CHANGE.

THE REQUEST SHALL BE ACCEPTED OR REJECTED SOLELY AT THE DISCRETION OF THE OWNER WITH ARCHITECT'S OR ENGINEER'S WRITTEN APPROVAL. E. CODES & STANDARDS. THE WORK PERFORMED UNDER DIVISION 16 SHALL COMPLY WITH THE LATEST EDITION AND REQUIREMENTS OF THE FOLLOWING: APPLICABLE LOCAL CODES AND ORDINANCES, NATIONAL ELECTRICAL CODE, AS AMENDED BY LOCAL CODE, ALL APPLICABLE FEDERAL AND STATE CODES, REGULATIONS AND STATUTES, APPLICABLE ENERGY CODE, OCCUPATIONAL SAFETY AND HEALTH ACT (OSHA), NATIONAL FIRE PROTECTION ASSOCIATION (NFPA), NATIONAL ELECTRICAL MANUFACTURERS ASSOCIATION (NEMA), UNDERWRITERS LABORATORIES, INC. (UL), AMERICAN NATIONAL STANDARDS INSTITUTE (ANSI), AMERICANS WITH DISABILITIES ACT (ADA) DISABÌLITÍES ACT (ADA).

F. MATERIALS & EQUIPMENT. MATERIAL AND EQUIPMENT SHALL BE NEW, STANDARD, CURRENT PRODUCTS OF MANUFACTURERS REGULARLY ENGAGED IN THE PRODUCTION OF SUCH EQUIPMENT, AND SHALL BE THE MANUFACTURER'S LATEST DESIGN.

ALL MATERIALS SHALL BEAR THE LABEL OF THE UNDERWRITERS LABORATORY FOR THE INTENDED USE OR SHALL BE MATERIALS APPROVED BY THE CODE ENFORCING AUTHORITIES AND THE ARCHITECT. FOLLOW THE INSTALLATION DIRECTIONS AND RECOMMENDATIONS OF MATERIAL AND EQUIPMENT MANUFACTURERS.

DESCRIPTION

LR/DR/BR FIXTURES

RESTROOM FIXTURE

KITCHEN FIXTURE

VANITY FIXTURE

EXTERIOR ENTRY FIXTURE

EXTERIOR SPOT LIGHTS

TYPE

GENERAL ELECTRICAL NOTES

ALL WORK SHALL BE PERFORMED BY WORKERS SKILLED IN THEIR RESPECTIVE TRADES AND ALL MATERIALS AND EQUIPMENT SHALL BE INSTALLED IN ACCORDANCE WITH MANUFACTURER'S RECOMMENDATIONS. ALL WORK SHALL BE EXECUTED IN A NEAT AND WORKMANLIKE MANNER. SUCH THAT REMOVAL OR REPLACEMENT MAY BE READILY ACCOMPLISHED WITHOUT DAMAGE IDENTIFY ALL EQUIPMENT, INCLUDING SAFETY SWITCHES, STARTERS, TRANSFORMERS, PANELS, TERMINAL BOXES, MOTORS, SPECIAL OUTLETS, RELAYS. IDENTIFICATION SHALL CORRESPOND TO THE TERMINOLOGY ON THE CONTRACT DOCUMENTS.

G. SUPPORTING DEVICES. DEVICES, INCLUDING ANCHORS, FASTENERS, HANGERS AND SUPPORTS, SHALL BE OF A TYPE DESIGNED OR FABRICATED FOR THE PURPOSE, AND SHALL ADEQUATELY AND SAFELY SECURE THE MATERIAL AND EQUIPMENT AND PRESENT A NEAT APPEARANCE. USE DEVICES WITH CORROSION RESISTANT CHARACTERISTICS FOR THE

ATMOSPHERIC CONDITIONS IN WHICH THEY ARE INSTALLED.

H. RACEWAYS & BOXES. ROUTING OF RACEWAYS, INTERCONNECTING OUTLETS AND HOME—RUNS IS UP TO THE ELECTRICAL CONTRACTOR, BUT AFTER COMPLETION OF THE INSTALLATION, HE SHALL SUBMIT TO THE ENGINEER AS—BUILT DRAWINGS OF HIS WORK FOR FUTURE RECORD. DEVICE BOXES SHALL BE INSTALLED FLUSH, CONDUIT SHALL BE CONCEALED UNLESS OTHERWISE INDICATED. ALL CONDUCTORS SHALL BE IN CONDUIT. FOR UNDERGROUND/IN—SLAB LOCATIONS USE GALVANIZED RIGID STEEL (GRS) CONDUIT OR SCHEDULE 40 PVC CONDUIT WITH GROUND WIRE SIZED AS INDICATED OR REQUIRED BY N.E.C., STUB—UPS FROM UNDERGROUND/IN—SLAB PVC CONDUIT SHALL BE GRS. UNDERGROUND GRS SHALL BE COATED WITH TWO COATS OF BITUMASTIC #50 APPLIED WITHOUT THINNING. ALL SECTIONS OF METALLIC CONDUIT SYSTEM SHALL BE GROUNDED AND ELECTRICALLY CONTINUOUS. USE ELECTRICAL METALLIC TUBING (EMT) FOR INTERIOR CONCEALED WIRING AND ELSEWHERE AS PERMITTED BY THE N.E.C. USE SEALTITE FLEXIBLE METAL CONDUIT FOR FLEXIBLE CONNECTIONS IN ALL WET LOCATIONS. INSTALL A NYLON PULL—CORD IN ALL EMPTY RACEWAYS FOR FUTURE USE. SIZE ALL GUTTERS AND PULL—BOXES PER NEC 370 AND 374. ALL PULL AND JUNCTION BOXES SHALL REMAIN ACCESSIBLE AT ALL TIMES. JUNCTION BOXES SHALL REMAIN ACCESSIBLE AT ALL TIMES.

MINIMUM SIZE OUTLET BOX SHALL BE 4" SQUARE BY 1-1/2" DEEP UNLESS APPROVED OR INDICATED OTHERWISE. USE CAST METAL OUTLET BOXES WITH GASKETED COVERS FOR ALL EXTERIOR AND FOR ALL PROVIDE APPROVED FIRE STOPPING MATERIALS AT ALL CHASES TO PREVENT DRAFTS, AT PENETRATIONS INTO RATED SPACES, AND OTHER LOCATIONS AS REQUIRED BY CODES.

PROVIDE CABLE SUPPORTS IN ACCORDANCE WITH NEC ARTICLE 300. PROVIDE EXPANSION FITTINGS IN CONDUIT RUNS CROSSING EXPANSION JOINTS IN THE

I. CONDUCTORS. UNLESS OTHERWISE INDICATED, ALL CONDUCTORS ARE #12 IN 1/2" CONDUIT. ALL CONDUCTORS SHALL BE COPPER. ACCEPTABLE INSULATION TYPES ARE TW, THW, THHN, THWN, AND XHHW, WITH USES AS RESTRICTED BY THE NEC. AMPACITIES OF CONDUCTORS IS TO BE BASED ON ARTICLE 310 OF THE NEC WITH UL LIMITATIONS: 60 DEG. RATING FOR SIZES #14 THROUGH #1; 75 DEG. FOR #1/0 AND LARGER. CABLES 3/0 AND LARGER SHALL BE TERMINATED WITH PRESSURE CRIMP CONNECTORS. FOR 20 AMP BRANCH CIRCUITS GREATER THAN 100 FT. IN LENGTH, ONE WAY, UP TO 200 FT. USE #10 WIRE; OVER 200 FT., USE #8 WIRE.
INCREASE CONDUIT SIZE AS REQUIRED FOR THE LARGER CONDUCTORS. THIS SUPERSEDES WIRE SIZES CALLED FOR ON THE DRAWINGS. CONDUCTORS SIZE #10 AND SMALLER SHALL HAVE INSULATION COLORED FOR PHASES A, B, C, AND N RESPECTIVELY AS FOLLOWS FOR 3 PHASE SYSTEM:

ALL CONDUCTORS OF THE SAME PHASE IN PARALLELED FEEDERS OR SERVICES SHALL BE SOLIDLY CONNECTED TOGETHER AT THEIR TERMINATION IN A WIREWAY OR SPLICE BOX. MAKE CONDUCTOR LENGTH FOR PARALLEL FEEDERS IDENTICAL. THE PHASE DESIGNATION OF ALL SECONDARY CONDUCTORS SHALL BE THE SAME AND SHALL BE INDICATED IN OR ON ALL 3 PHASE OUTLETS, TRANSFORMERS, PANELBOARDS, AND DISCONNECT SWITCHES, AND THEY SHALL BE CONNECTED WITH UNIFORM PHASE SEQUENCE. MAINTAIN A, B, C PHASE RELATION LEFT TO RIGHT WHEN VIEWED FROM THE FRONT. TAG ALL FEEDER CONDUCTORS AND IDENTIFY MAJOR CONDUITS IN OR AT WIREWAYS, PANELS, PULL BOXES, SWITCHBOARDS, MOTOR CONTROLLERS, CABINETS AND SIMILAR ITEMS TO ASSIST IN FUTURE CIRCUIT TRACING. CONDUCTOR TAGS SHALL BE NONCONDUCTIVE. IDENTIFICATION SHALL CORRESPOND TO THE CONTRACT DOCUMENTS. COMMUNICATIONS, DATA, AND/OR WIRING WHICH IS NOT INSTALLED IN CONDUIT, AND WHICH IS ROUTED THROUGH ENVIRONMENTAL AIR SPACES, SHALL COMPLY WITH THE REQUIREMENTS OF NEC 300-22. PROVIDE TRAPEZE HANGER ASSEMBLY FOR PLENUM CABLES USING 3/8" DIAMETER HANGER ROD AND CHANNEL ASSEMBLY TO SUPPORT CABLE BUNDLES EVERY 4 FEET. ALL BUNDLES SHALL BE PROPERLY STRAPPED WITH SELF-LOCKING CABLE TIES. EXPOSED CABLES SHALL NOT LIE ON TOP OF CEILING TILES OR LUMINARIES.

LIGHTING FIXTURE SCHEDULE

CATALOG NUMBER

FM22 ACLR LP

3348 2L32

217-WT

OFTR 200O 120 LP

 $\stackrel{/}{\longrightarrow}$ FMLL7830WL

′5 \ MWVB2 BZ DCNE1001

120/240 VOLTS: BLACK, RED, BLUE AND WHITE

END-TO-END LIGHTING FIXTURES SHALL BE CONTINUOUSLY BONDED. GROUNDING CONTACTS OF RECEPTACLES SHALL BE CONNECTED TO A SOLIDLY GROUNDED CONDUIT SYSTEM OR TO A SYSTEM GROUNDING CONDUCTOR (NOT THE SYSTEM NEUTRAL) BY A STRANDED COPPER WIRE NOT SMALLER THAN #12 AWG OR SHALL BE GROUNDED IN SOME OTHER APPROVED MANNER; THE RESISTANCE BETWEEN THE CONTACTS AND SERVICE GROUND SHALL NOT EXCEED 3 OHMS. ALL CIRCUITS SHALL HAVE AN EQUIPMENT GROUNDING CONDUCTOR.

K. SAFETY SWITCHES/CIRCUIT BREAKER DISCONNECTS.
SHALL BE HEAVY DUTY TYPE KD, FUSIBLE, OR NON-FUSIBLE, WITH POLES, AMPERE, VOLTAGE AND HORSEPOWER RATINGS INDICATED AND SHALL HAVE SOLID NEUTRALS. LUGS SHALL BE U.L. LISTED FOR COPPER-ALUMINUM.

ENCLOSURES FOR SAFETY SWITCHES SHALL BE NEMA-1, GENERAL PURPOSE, EXCEPT THAT SWITCHES INDICATED (WP) WEATHERPROOF, SHALL BE NEMA-3R ENCLOSURES WITH SUITABLE SWITCHES AND DISCONNECT SHALL BE AS MANUFACTURED BY SQUARE "D", OR APPROVED CIRCUIT BREAKER DISCONNECTS MAY BE USED IN LIEU OF SAFETY SWITCHES PROVIDING THEY COMPLY WITH THE SAFETY SWITCH REQUIREMENTS AND ARE SUPPLIED WITHIN THEIR RATINGS AND A SCHEDULE IS SUBMITTED FOR APPROVAL.

L. MOLDED CASE CIRCUIT BREAKERS. CIRCUIT BREAKERS SHALL CONFORM TO APPLICABLE FEDERAL SPECIFICATIONS AND NEMA STANDARDS. CIRCUIT BREAKERS SHALL BE OF THE AMPERE RATING, VOLTAGE RATING, NUMBER OF POLES AND CLASS OR INTERRUPTING CAPACITY (I.C.) AS INDICATED. INTERRUPTING RATINGS ARE GIVEN IN ROOT MEAN SQUARE (RMS), SYMMETRICAL AMPERES BASED ON NEMA TEST PROCEDURES. LUGS AND TERMINALS SHALL BE U.L. APPROVED FOR COPPER—ALUMINUM. ACCESSORIES SHALL BE 120 VOLT. A.I.C. OF BREAKER TO BE INSTALLED ON EXIST. PANELS SHALL MATCH EXIST. EACH CIRCUIT BREAKER SHALL HAVE A TRIP UNIT FOR EACH POLE WITH ELEMENTS PROVIDING INVERSE TIME DELAY UNDER OVERLOAD CONDITIONS AND INSTANTANEOUS MAGNETIC TRIP FOR SHORT CIRCUIT PROTECTION UNLESS INDICATED AS NON-AUTOMATIC. TRIP ELEMENTS SHALL OPERATE A COMMON TRIP BAR TO OPEN ALL ELEMENTS. BREAKERS USED FOR SWITCHING

SHALL BE RATED FOR SWITCHING DUTY.

QTY | LAMP | COLOR | VOLTS | MOUNTING

3000

3500

3000

2700

2700

A MINIMUM OF 50% OF THE LAMPS IN PERMANENTLY INSTALLED

LIGHTING FIXTURES SHALL BE HIGH-EFFICACY LAMPS AS PER

13W PL

100WQTZ

ENERGY CODE (FBC) SECTION 404.1

120

120

120

120

120

 ${f M.}$ FUSES. Fuses shall conform to Nema and U.L. and shall be of the voltage, class and ampere rating indicated. FUSES FOR MAIN DISCONNECT DEVICES SHALL BE HIGH INTERRUPTING CAPACITY, TIME DELAY, OR TYPE SUITABLE FOR DEVICE. PROVIDE ONE SPARE SET MOUNTED INSIDE THE CUBICLE, FOR EACH MAIN DEVICE.

FUSES FOR MOTORS AND ENCLOSED SWITCHES, NEMA CLASS K-5, UNLESS INDICATED OTHERWISE, DUAL ELEMENT, TIME DELAY. BUSSMAN — FUSETRON, FRN AND FRS, OR EQUAL. OTHER FUSES SHALL BE AS INDICATED.

N. WIRING DEVICES. DEVICES SHALL BE AS SPECIFIED IN CONTRACT DOCUMENTS. INSTALL PLATES AND COVERS ON ALL OUTLETS. INSTALL ALL DEVICES UNIFORMLY IN EACH

PLATES SHALL BE ALIGNED VERTICALLY AND HORIZONTALLY AND ALL EDGES SHALL BE IN FIRM CONTACT WITH SURROUNDING WALL FINISH. MOUNTING HEIGHTS (TO CENTER LINE OF BOX):

GENERALLY MOUNT RECEPTACLES 18" AFF (ABOVE FINISHED FLOOR) UNLESS NOTED OTHERWISE.

MOUNT SWITCHES AND DIMMERS AT 48" AFF.

MOUNT OUTLETS OVER MIRRORS 8" HIGHER THAN MIRROR.

MOUNT OUTLETS OVER COUNTERS AND CENTERED IN THE BACK SPLASH WHERE IT OCCURS; RECEPTACLE SHALL BE HORIZONTAL.

TEST EACH SOCKET OF EACH OUTLET WITH A DEVICE INTENDED FOR THE PURPOSE.

FLUSH

SURFACE

SURFACE

SURFACE

SURFACE

ADJUST OUTLET HEIGHTS IN CERAMIC TILE WALLS TO BE ENTIRELY IN OR ENTIRELY OUT OF THE TILE. OUTLETS MAY BE HORIZONTAL TO MEET SPACE CONDITIONS.

REMARKS

ENERGY STAR

ENERGY STAR

ENERGY STAR

ENERGY STAR

WET LOCATION

WET LOCATION

RESIDENCE NOTES:

1. COOLING AND HEATING LOADS ARE NOT CONCURRENT.

- 2. PROVIDE ALL FINAL CONNECTIONS TO ALL EQUIPMENT AND APPLIANCES.
- PROVIDE ALL A/C CONTROL IN SEPARATE 1/2"C AS REQUIRED BY A/C DRAWINGS OR MANUFACTURER DIAGRAMS.
- 4. ALL LAVATORIES AND KITCHEN RECEPTACLES SHALL BE GFI TYPE.
- 5. EXTERIOR RECEPTACLES TO BE GFI AND WEATHER PROOF.
- 6. COORDINATE LOCATION OF ALL DISCONNECT SWITCHES WITH OTHER TRADES TO ALLOW N.E.C. REQUIREMENT CLEARANCE.
- CIRCUITS WIRING REQUIRED TO BE AS FOLLOWS: 120V-2 WIRE (L-N); 120/240V 3 WIRE (LL-N); 240V - 2 WIRE (LL). WHEN EQUIPMENT GROUND IS REQUIRED INCREASE CONDUIT SIZE AS REQUIRED.
- 8. ALL WIRING TO BE COPPER. THHN/THWN TYPE RUN IN CONDUIT.
- 9. ALL COUNTER RECEPTACLES AND SWITCHES TO BE MOUNTED + 48" MAXIMUM FINISHED FLOOR (TO BOTTOM OF PLATE). UNLESS OTHERWISE NOTED COORDINATE HEIGHT WITH ARCHITECT.
- 10. REFRIGERATOR RECEPTACLE TO BE MOUNTED + 48" A.F.F.
- 1. COORDINATE LOCATION OF AIR CONDITIONER (INDOOR UNIT) DISCONNECT SWITCH WITH A/C
- CONTRACTOR TO KEEP N.E.C. REQUIRED CLEARANCE. 12. MINIMUM WIRE SIZE SHALL BE #12 THHN/THWN
- 13. CONDUCTORS #6 AWG AND LARGER SHALL BE THW.
- 14. ALL CONDUCTORS SHALL BE COPPER.
- 15. CONDUIT IN FINISHED AREAS SHALL BE CONCEALED.
- 16. CONDUIT IN UNFINISHED AREAS SHALL BE EXPOSED.
- 17. FUSES SHALL BE DUAL ELEMENT, TIME DELAY TYPE.
- 18. INSTALL NYLON PULL STRING IN ALL EMPTY CONDUITS FOR FUTURE USE. 19. ALL MATERIALS SHALL BE U.L. APPROVED.
- 20. WORKMANSHIP SHALL BE TO BEST COMMERCIAL PRACTICE.
- 21. INSTALLATION SHALL BE IN ACCORDANCE WITH LOCAL, STATE AND NATIONAL CODES.
- 22. RECESSED LIGHT FIXTURES OVER BATHTUB OR SHOWER SHALL BE COMPLETELY ENCLOSED AND VAPOR PROOF SUITABLE FOR WET LOCATIONS.
- 23. ALL LUMINARIES SHALL BE PROPERLY SUPPORTED IN ACCORDANCE WITH THE CEILING SYSTEM MANUFACTURER RECOMMENDATIONS AND LOCAL CODE REQUIREMENTS.
- 24. RISER AND DIAGRAMMATIC ONLY. THEY DO NOT SHOW EVERY BEND REQUIRED FOR THE
- 25. THIS DRAWING IS A GUIDE FOR THE INSTALLATION OF ELECTRICAL SERVICE. THE ELECTRICAL CONTRACTOR IS RESPONSIBLE TO PROVIDE A FUNCTIONING SYSTEM.
- 26. A/C EQUIPMENT WIRING, BREAKER AND FUSE SIZES ARE BASED ON A/C EQUIPMENT SPECIFIED ON CONTRACT DRAWINGS. CONTRACTOR IS RESPONSIBLE FOR PROVIDING ALL WIRING, BREAKER AND FUSES SIZES IN ACCORDANCE WITH A/C EQUIPMENT NAMEPLATE REQUIREMENTS IF DIFFERENT FROM THAT SPECIFIED ON DRAWINGS, AS WELL AS ANY FEEDER CHANGES BEING AFFECTED BY THIS CHANGE. CONTRACTOR SHALL MAKE ABOVE MENTIONED CHANGES AT NO EXTRA COST.
- 27. CONTRACTOR SHALL COORDINATE ALL HIS WORK WITH OTHER TRADES IN ORDER TO FURNISH AND INSTALL ALL CONTROL WIRING AND RACEWAYS ALL POWER CONTROL CIRCUITS WIRING AND RACEWAYS AS SHOWN ON THE AIR CONDITIONING DRAWINGS OR SPECIFICATIONS. IF AIR CONDITIONING DRAWINGS REFER TO MANUFACTURER'S WIRING DIAGRAMS, THE CONTRACTOR SHALL VERIFY WITH SAID MANUFACTURER ALL REQUIREMENTS AND INCLUDE ALL RELATED WORK IN HIS

28. SEE PANEL SCHEDULES FOR AFCI CIRCUIT REQUIREMENTS.

29. ALL RECEPTACLES SHALL BE TAMPER PROOF.

SYMBOL LEGEND:

- DUPLEX RECEPTACLE OUTLET 15A, 125V, 3 WIRE MOUNTED @ 18" AFF SMALL APPLIANCE AND
- MOUNTED TAMPER RESISTANT. SINGLE RECEPTACLE OUTLET, 20A, 125V, 3 WIRE, GROUNDING TYPE WALL MOUNTED
- TAMPER RESISTANT.
- CEILING MOUNTED LIGHT FIXTURE (RECESSED)
- FLUORESCENT LIGHT FIXTURE

MOTOR

- SINGLE POLE SWITCH, 120V, 20A

- FUSED OR NON FUSED DISCONNECT SWITCH. FUSES AS PER EQUIPMENT MANUFACTURER.
- JUNCTION BOX
- GFI GROUND FAULT INTERRUPTER

- BATHROOM DUPLEX RECEPTACLES TO BE RATED FOR 20A, 125V, 3 WIRE, GROUND TYPE WALL
- WALL MOUNTED LIGHT FIXTURE
- -O- PENDANT LIGHT FIXTURE
- TV OUTLET
- TELEPHONE OUTLET MOUNTED AT 18" AFF
- THREE-WAY SWITCH, 120V, 20A.
- SPECIAL PURPOSE OUTLET TO MATCH EQUIPMENT PLUG, 120/240V, 1ø, GROUNDING TYPE
- SMOKE DETECTOR (120V) TANDEM WIRED WITH SOUNDING BASE
- WP WEATHER PROOF

ALLEGUEZ ARCHITECTURE, INC. ARCHITECTURE PLANNING INTERIOR DESIGN CONSTRUCTION MANAGEMENT

901 PONCE DE LEON BLVD., SUITE 202 CORAL GABLES, FLORIDA 33134 tel: 305.461.4001 fax: 305.461.6002 www.alleguezarchitecture.com ■ AA C 0 0 2 7 4 6 ■

CONSULTANTS:

MECHANICAL, ELECTRICAL, PLUMBING ENGINEER: GARTEK ENGINEERING CORP. 7210 SOUTHWEST 39TH TERRACE MIAMI, FLORIDA 33155

TEL: (305) 266-8997 FAX: (305) 264-9496 Certificate of Authorization #3144 www.gartek-engineering.com

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CITY OF MIAMI LIFE QUEST **RENOVATIONS** 1075 NE 149 ST

Owner's Representative Lori B. Soto City of Miami Department of Community Development (305) 416-2084

444 SW 2nd Avenue

MIAMI, FL. 33130 DRAWING TITLE:

GENERAL **ELECTRICAL NOTES** AND LEGEND

M. F. GARCIA P.E. (ELECTRICAL) LICENSE NO. 24221 "In my professional judgement and to the best of my knowledge and belief, these

DATE: SEPTEMBER 15, 2014

plans and specifications comply with applicable Building Codes.

10-20-13 BACKGROUND CHANGE 5 01−16−17 PLAN UPDATE

CAD DRAWING NAME:

E-

48 HOURS BEFORE DIGGING

UNDERGROUND UTILITIES NOTIFICATION CENTER

BOND TO LUMINAIRE INTERNALLY. LIGHT FIXTURE TYPE AS PER SCHEDULE. DIRECT BURIAL TAPERED. TYPE II PRECAST CONCRETE POLE 15 FT ABOVE GRADE. STORE AND INSTALL AS RECOMMENDED BY POLE MANUFACTURER. — INTEGRAL RACEWAY # 8 CU. CAST IN POLE GROUND WIRE. LOOP THRU HANDHOLE. CONNECT TO CIRCUIT GROUNDING CONDUCTOR. INTEGRAL HANDHOLE WITH COVER DEPTH AS REQUIRED -CADWELLD #6 CU (C) CONDUCTOR TO 8'-0" CC GROUND ROD. BOND ALL CONDUIT

MANUFACTURER

LITHONIA

LITHONIA

LITHONIA

LITHONIA

WAVE

LITHONIA

THE LUMINAIRE(S) AND POLE INSTALLATION SHALL MEET THE APPLICABLE FBC LOAD WITHSTAND REQUIREMENTS. THE

CONTRACTOR SHALL SUBMIT A SIGNED AND SEALED LETTER

INDICATING COMPLIANCE WITH CODE REQUIREMENTS FOR THE INSTALLATION. PROVIDE EMBEDMENT DEPTH AS REQUIRED BY WIND LOAD CALCULATIONS. SUBMIT CALCULATIONS WITH SHOP

BY A REGISTERED ENGINEER IN THE STATE OF FLORIDA,

DRAWINGS SIGNED AND SEALED BY FLORIDA REGISTER


SLIP FITTER POLE GROUND BROUGHT OUT THRU TENON.


ENGINEER.


COMPACTED BACKFILL. 2'-0" MIN. LIGHT POLE DETAIL

GROUNDING CONDUCTORS.

-AUGURED HOLE AND

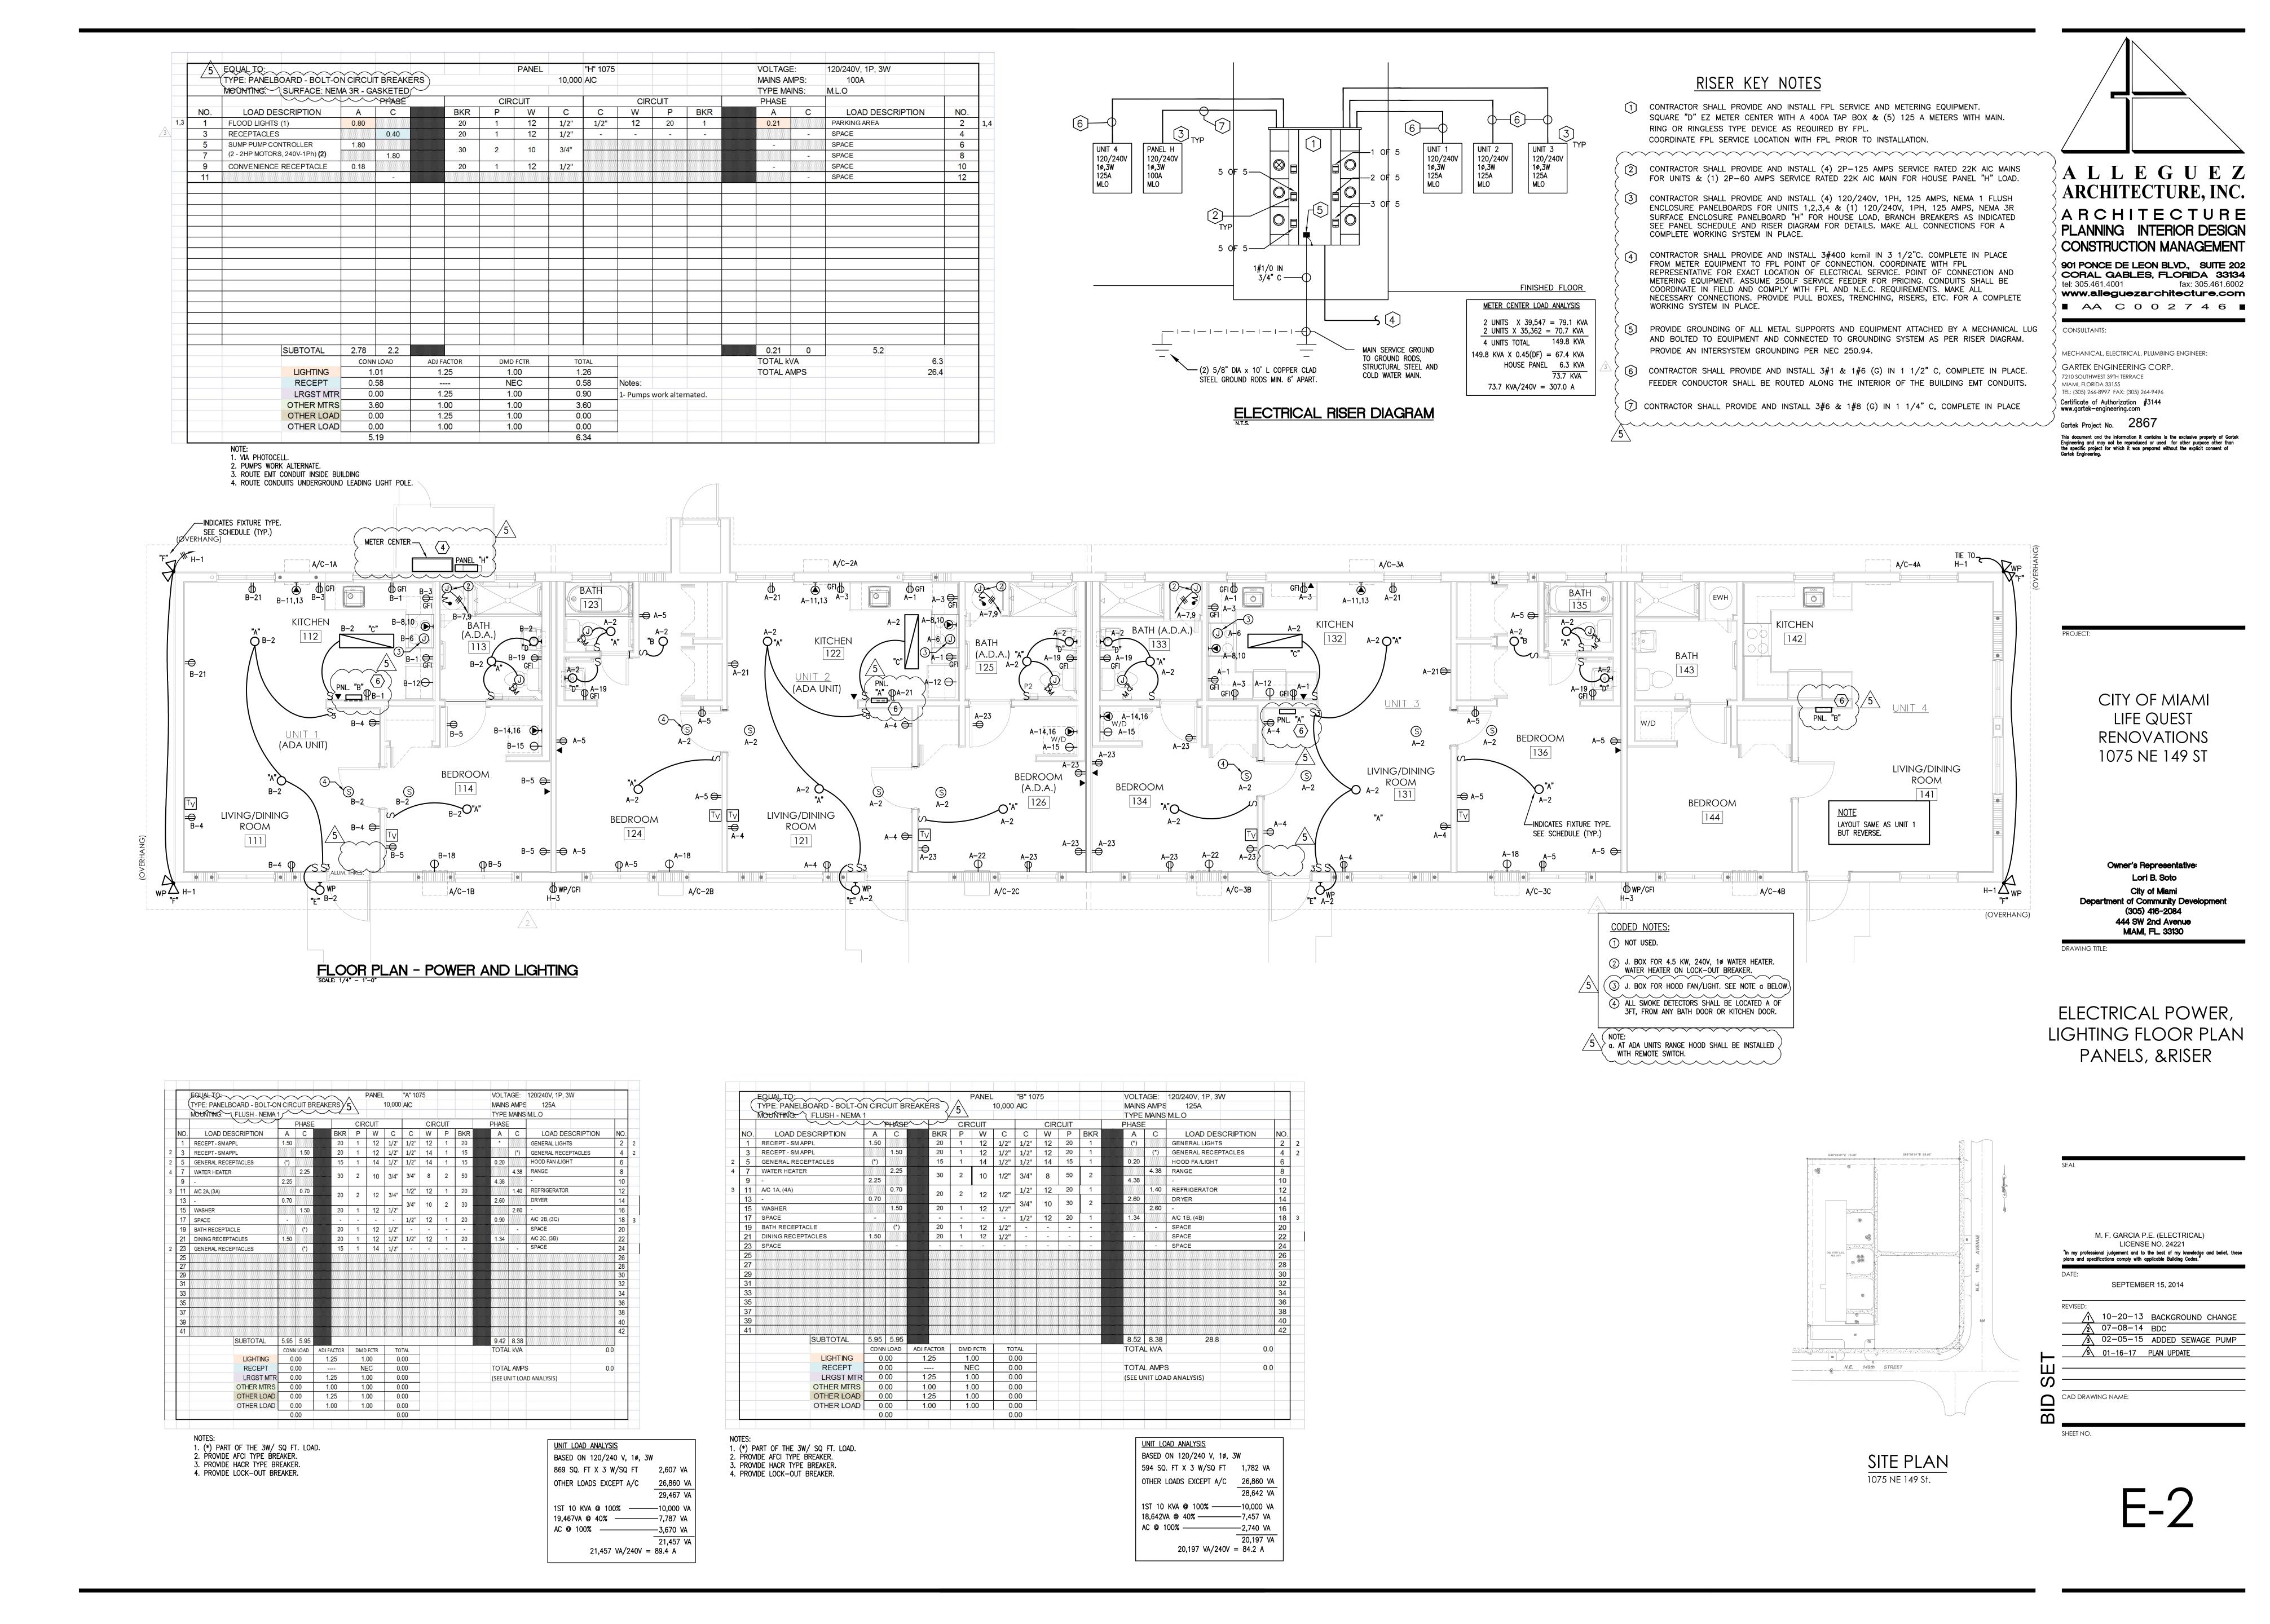

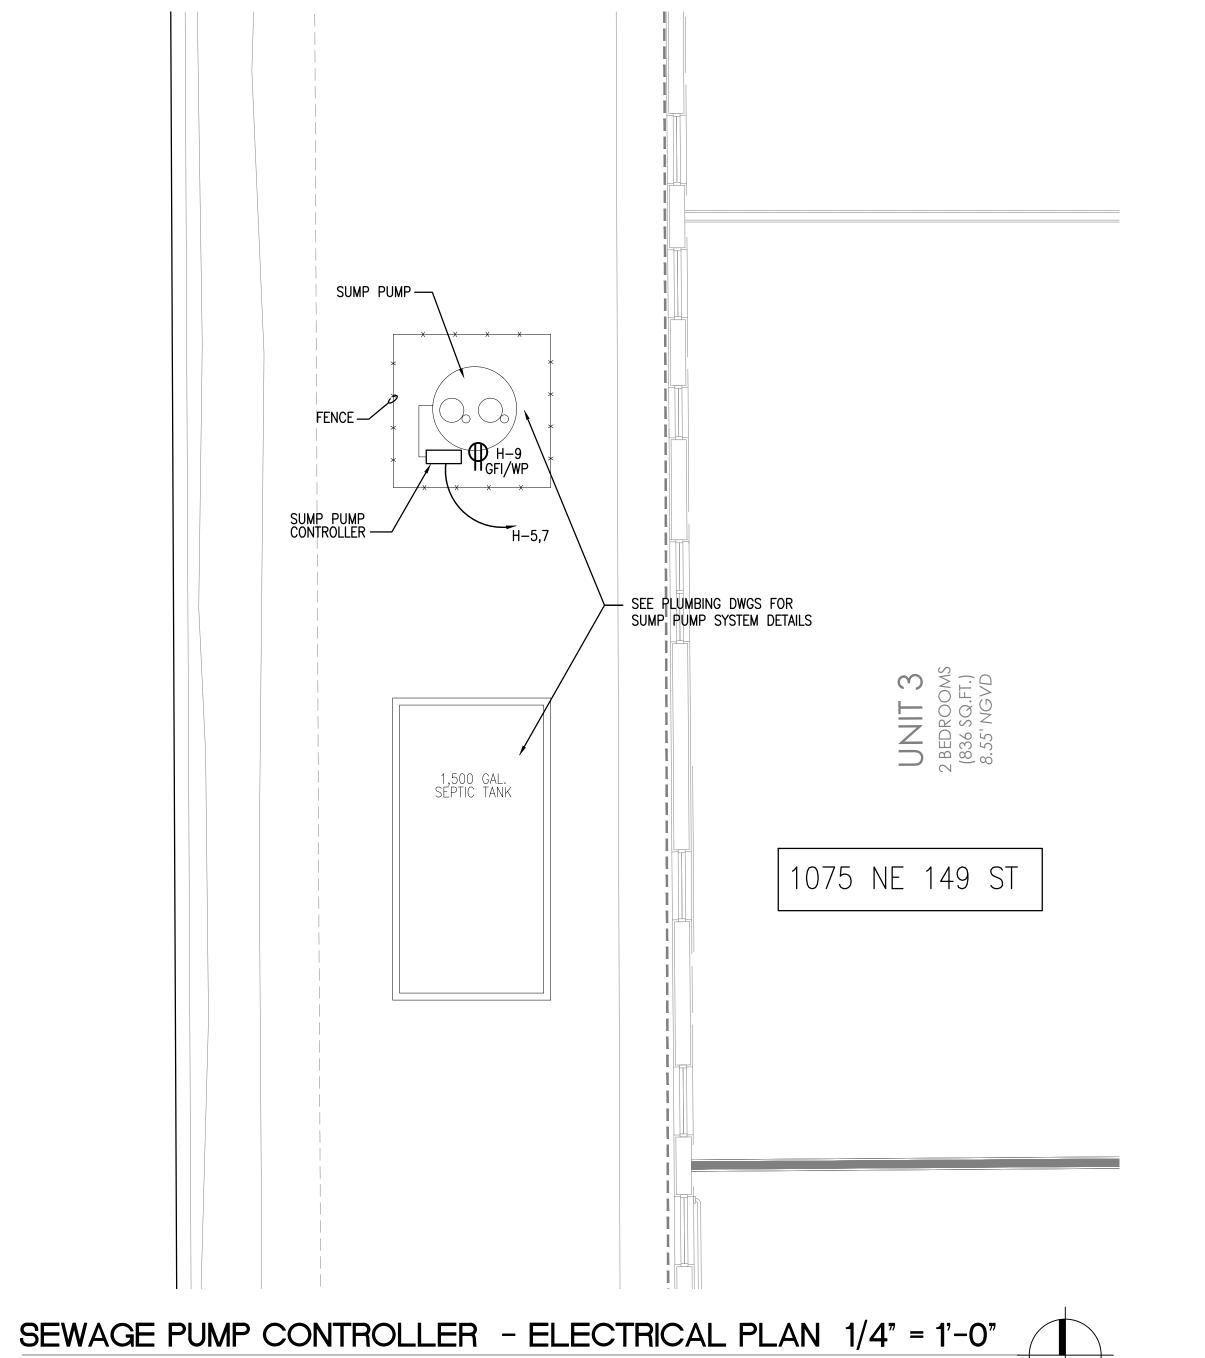

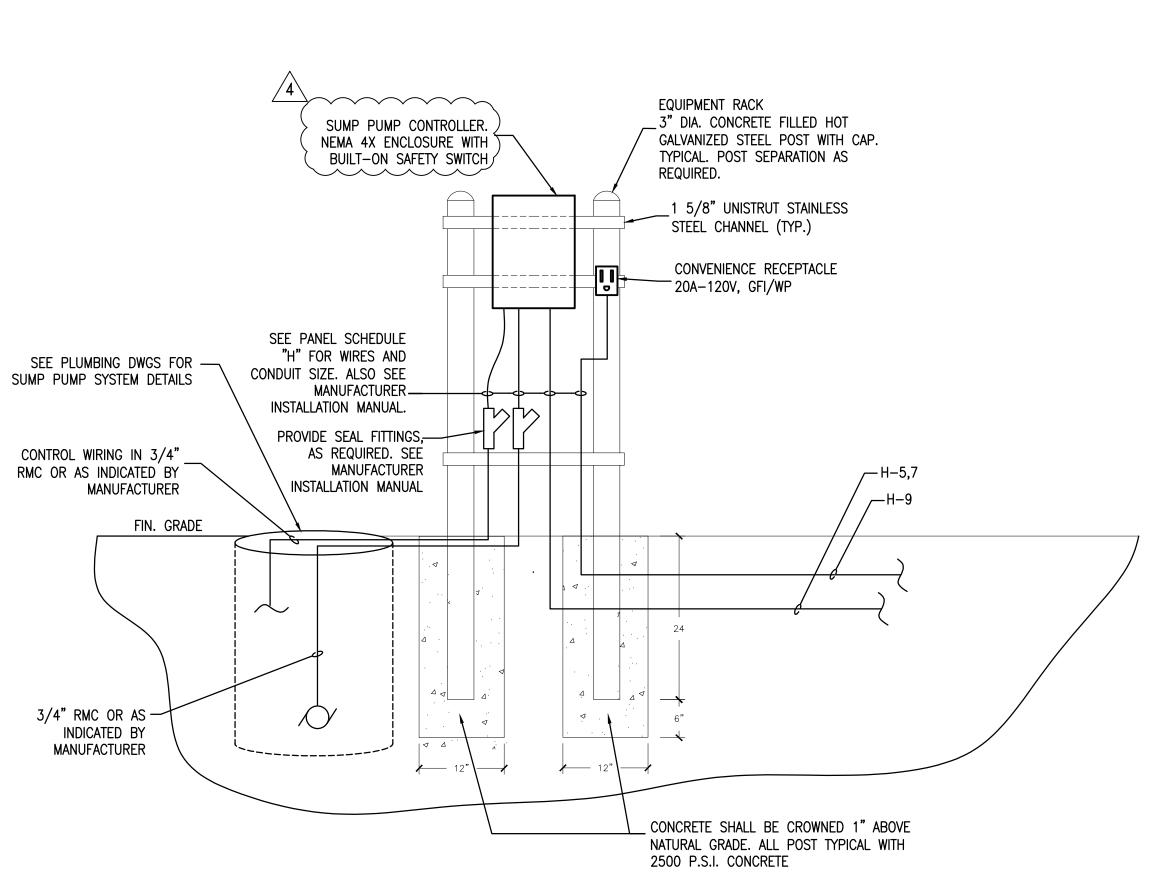

SEWAGE PUMP CONTROLLER MOUNTING DETAIL

A L L E G U E Z ARCHITECTURE, INC.

INTERIOR DESIGN
CONSTRUCTION MANAGEMEN

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CITY OF MIAMI LIFE QUEST RENOVATIONS 1075 NE 149 ST

MIAMI, FL

ELECTRICAL PLAN, AND DETAIL

M. F. GARCIA P.E. (ELECTRICAL)

LICENSE NO. 24221
"In my professional judgement and to the best of my knowledge and belief, these plans and specifications comply with applicable Building Codes."

: February 05, 2015

REVISED:

O1-16-17 PLAN UPDATE

CAD DRAWING NAME:

SHEET NO.

г ₂

HVAC GENERAL NOTES

- 1. THE WORK THAT IS TO BE DONE UNDER THIS HEADING INCLUDES THE FURNISHING OF ALL LABOR, MATERIALS AND EQUIPMENT PERMITS, FEES, INSPECTIONS, TEST, INSURANCE, ETC., REQUIRED FOR THE COMPLETION OF THE AIR CONDITIONING HEATING AND VENTILATION SYSTEMS SHOWN ON DRAWINGS OR LISTED BELOW.
- 2. THE DRAWINGS ARE GENERALLY DIAGRAMMATIC. THEY DO NOT SHOW EVERY BEND, OFF-SET, ELBOW OR OTHER FITTINGS WHICH MAY BE REQUIRED FOR THE INSTALLATION IN THE SPACE ALLOCATED, OR FOR COORDINATION WITH OTHER TRADES.
- 3. DRAWINGS ARE NOT TO BE SCALED. UNLESS SPECIFIC DIMENSIONS ARE SHOWN, THE ARCHITECTURAL AND/OR STRUCTURAL DRAWINGS, AND SITE CONDITIONS SHALL GOVERN EXACT LOCATION OF MECHANICAL EQUIPMENT AND APPURTENANCES.
- IT IS THE INTENT OF THE PLANS AND GENERAL NOTES TO PROVIDE A COMPLETE AND OPERATING INSTALLATION INCLUDING ALL NECESSARY ITEMS REQUIRED, EVEN THOUGHT ITEMS ARE NOT INDICATED ON THE DRAWINGS OR IN THE NOTES. WORK CONSIDER NECESSARY FOR THE COMPLETION OF THE WORK IN PROPER MANNER NOT SHOWN ON THE PLANS OR NOTES SHALL BE BROUGHT TO THE ATTENTION OF THE ARCHITECT/ENGINEER IN WRITING PRIOR TO BIDS OTHERWISE WORK SHALL NOT BE ADDITIONALLY CHARGED AFTER BID IS AWARDED.
- DEFINITIONS:
- A. PROVIDE MEANS TO FURNISH AND INSTALL. B.UNDER THIS SECTION - MEANS IT IS THE RESPONSIBILITY OF THE CONTRACTOR AND IS TO BE DONE BY AND PAID FOR BY THE CONTRACTOR. C. BY THIS SECTION - MEANS IT IS THE RESPONSIBILITY OF THE CONTRACTOR AND IS TO BE DONE
- 6. INDOOR AIR QUALITY PRECAUTIONS:

BY AND PAID FOR BY THE CONTRACTOR.

- A. THE CONTRACTOR SHALL ALLOW FOR NECESSARY VENTILATION DURING CONSTRUCTION TO AVOID INDOOR AIR POLLUTION.
- B. THE CONTRACTOR SHALL PREPARE WRITTEN DIRECTION BY WHICH THE BUILDING OWNER OR ITS REPRESENTATIVE WILL BE ABLE TO OPERATE THE VENTILATION SYSTEMS AT ITS OPTIMAL LEVEL.
- 7. OUTDOOR AIR QUALITY PRECAUTIONS: THE CONTRACTOR SHALL ALLOW FOR NECESSARY PRECAUTIONS DURING CONSTRUCTION AND THEREAFTER FOR THE INSTALLATION AND HANDLING OF REFRIGERANTS. THE CONTRACTOR SHALL PREPARE WRITTEN DIRECTIONS BY WHICH THE BUILDING OWNER OR ITS REPRESENTATIVE WILL BE ABLE TO HANDLE REFRIGERANT IN A SAFE AND APPROVED MANNER.
- 8. SUBMIT A COMPLETE "AS-BUILT" RECORD SET IN ELECTRONIC AUTOCAD DWG FILE'S FORM TO ARCHITECT/ ENGINEER FOR REVIEW PRIOR TO FINAL PAYMENT REQUISITION.
- 9. A. HVAC EQUIPMENT, AIR DISTRIBUTION, FANS MATERIALS, ETC., SHALL BE AS LISTED HEREIN AND/OR SHALL BE AS SCHEDULED ON THE DRAWINGS. B. MANUFACTURERS USE FOR THE BASIS OF DESIGN ARE LISTED ON THE DRAWING SCHEDULE, ANY OTHER MUST MEET OR EXCEED ALL SPECIFIED REQUIREMENTS. NAMING ACCEPTABLE MANUFACTURERS DOES NOT RELIEVE CONTRACTOR FROM COMPLIANCE WITH ALL DESIGN REQUIREMENTS SHOWN ON DRAWINGS OR LISTED HEREIN.
- 10. CUT ALL OPENINGS, CHASES, TRENCHES, ETC. REQUIRED TO ACCOMMODATE THE WORK UNDER THIS DIVISION AND REPAIR ALL WALLS, ROOF, ETC. DAMAGED BY SUCH CUTTINGS. ALL WORK DONE UNDER THIS HEADING MUST CONFORM IN EVERY RESPECT TO FINISH AND QUALITY OF MATERIALS AND WORKMANSHIP SPECIFIED UNDER APPROPRIATE SECTIONS FOR THIS BUILDING.
- 11. VERIFY ALL VOLTAGES WITH ELECTRICAL CONTRACTOR BEFORE ORDERING ANY EQUIPMENT.
- 12. SUBMIT SHOP DRAWINGS OF ALL MATERIALS, DUCTWORK AND EQUIPMENT FOR REVIEW BY ARCHITECT/ENGINEER PRIOR TO FABRICATION AND/OR INSTALLATION.
- 13. CONTRACTOR SHALL VERIFY SPACE CONDITIONS AND DIMENSIONS AND SHALL COORDINATE WORK WITH ALL OTHER TRADES AT JOB SITE PRIOR TO FABRICATION AND INSTALLATION OF DUCTWORK. THE CONTRACTOR SHALL BE RESPONSIBLE FOR THE FULL COORDINATION OF THIS WORK WITH THAT OF ALL OTHER TRADES.
- 14. OBTAIN FULL INFORMATION REGARDING PECULIARITIES AND LIMITATIONS OF SPACE AVAILABLE FOR INSTALLATION OF THE EQUIPMENT AND MATERIALS UNDER THIS CONTRACT, AND PROVIDE READY ACCESSIBILITY TO DAMPERS, VALVES AND OTHER APPARATUS, INCLUDING ANY PART OF SYSTEM REQUIRED TO BE REACHED FOR MAINTENANCE AND OPERATIONS.

15.DUCTWORK:

- A. TOILET AND DRYER EXHAUST DUCTWORK SHALL BE CONSTRUCTED OF SOLID ZINC COATED GALVANIZED SHEET METAL CONSTRUCTED IN ACCORDANCE WITH THE LATEST A.S.H.R.A.E. GUIDE AND S.M.A.C.N.A. RECOMMENDATIONS.
- D. ALL DUCT SIZES SHOWN ARE CLEAR INSIDE (AIRSIDE) DIMENSIONS.
- E. ALL DUCT ELBOWS SHALL BE FITTED WITH TURNING VANES (EXCEPT DRYER EXHAUST WHICH SHALL BE LONG SMOOTH ROUND ELBOW).

16. INSULATION:

- A. PIPING CONDENSATE PIPING PIPING SHALL BE INSULATED WITH 3/4" FIRE RATED FLEXIBLE FOAM INSULATION. FINISH WHERE EXPOSED WITH 2 COATS OF WHITE LATEX PAINT AS PER THE MANUFACTURER'S INSTRUCTION.
- 17. FLAME AND SMOKE RATING: ALL INSULATION PRODUCTS USED INSIDE THE BUILDING SHALL HAVE A MAXIMUM FLAME SPREAD RATING OF 25 AND A MAXIMUM SMOKE GENERATION OF 50 IN ACCORDANCE WITH TESTS OUTLINED IN N.F.P.A. #255.

18. FILTERS:

- A. PROVIDE TWO SETS OF TEMPORARY FIBERGLASS THROWAWAY FILTERS OF THE SAME THICKNESS AS FINAL FILTERS FOR USE DURING CONSTRUCTION.
- B. PROVIDE TWO COMPLETE SETS OF FINAL FILTERS.
- 19. VIBRATION ISOLATORS:
- A.CONDENSING UNITS SHALL BE MOUNTED ON 1" THICK NEOPRENE PADS, THRU-BOLTED TO HOT DIPPED GALVANIZED WELDED STEEL ANGLE.

20.CONTROLS:

- A. ALL ELECTRIC WIRING AND CONDUIT SHALL BE PROVIDED BY THE ELECTRICAL CONTRACTOR. B. WIRELESS THERMOSTAT SHALL BE HEAT-COOL PROGRAMMABLE WITH FAN AND SELECTOR SWITCHES.
- 21. ALL EQUIPMENT AND MATERIALS SHALL BE GUARANTEED FOR THE PERIOD OF ONE YEAR. COMPRESSORS SHALL CARRY 5 YEAR FACTORY GUARANTEE. FURNISH 90 DAYS FREE SERVICE.
- 22. ALL FAN DRIVES SHALL BE ADJUSTED TO DELIVER THE SPECIFIED CFM AGAINST THE ACTUAL STATIC PRESSURE OF THE INSTALLATION.
- 23. ALL WORK SHALL BE COORDINATED WITH THE WORK OF OTHER TRADES TO AVOID INTERFERENCE WITH PROGRESS OF CONSTRUCTION AND IN STRICT COMPLIANCE WITH ALL APPLICABLE CODES AND
- 24. ALL OUTSIDE EQUIPMENT SHALL BE SECURED TO WITHSTAND 170 MPH HURRICANE FORCE WINDS.
- 26. TESTING: A. BALANCE AIR SYSTEM TO DELIVER SPECIFIED QUANTITIES AT EACH OUTLET WITHIN 10% USING A.A.B.C. PROCEDURES AND TESTS. SUBMIT AIR BALANCE TEST RESULTS FOR REVIEW PRIOR TO FINAL INSPECTION AND ACCEPTANCE.
- B. SUBMIT SHOP DRAWINGS OF ALL MATERIALS, DUCTWORK AND EQUIPMENT FOR REVIEW PRIOR INSTALLATION AND/OR FABRICATION. C. ALL WORK SHALL BE DONE IN ACCORDANCE WITH THE LATEST EDITION OF THE STANDARD BUILDING CODE NFPA 90A, 90B AND ALL APPLICABLE LOCAL CODES AND ORDINANCES. E. CONTRACTOR SHALL BE RESPONSIBLE TO TEST AND BALANCE THE SYSTEM TO ACHIEVE RATES AS SHOWN ON PLANS AND SCHEDULES. TEST/BALANCE RESULTS SHALL BE SUBMITTED TO
- ARCHITECT/ENGINEER FOR REVIEW PRIOR TO FINAL PAYMENT REQUISITION. 26. FANS (COOK IS THE BASIS OF DESIGN)
- A. PROVIDE FANS AS SCHEDULED ON DRAWINGS
- B. INSTALLATION
- 1. INSTALL FANS IN ACCORDANCE WITH MANUFACTURER'S RECOMMENDATIONS.
- 2. LOCATE EXHAUST FANS A MINIMUM OF 10'-0" (HORIZONTAL DISTANCE) AWAY FROM ANY OUTSIDE
- AIR INTAKE, OPERABLE WINDOW AND/OR DOOR. 3. PROVIDE CONTROL LOW VOLTAGE TRANSFORMERS, TEN MINUTE TIME-OFF DELAY RELAYS AND BACK
- DRAFT DAMPERS, SEAL ALL STRUCTURAL ROOF AND WALL OPENINGS AIR AND WATER TIGHT. 30. THRU THE WALL AIR CONDITIONERS (FRIEDRICH IS THE BASIS OF DESIGN)
- UNITS SHALL BE PROVIDED WITH:
- A. SEA COAST PROTECTION. (10,000 HOURS MINIMUM) B. WIRELESS REMOTE CONTROL, 3 SPEED FAN CONTROL AND PROGRAMMABLE TIMER,
- C. OUTSIDE AIR DUCT WITH DAMPER SET @ 30 CFM.
- D. INSECT BARRIER, WASHABLE ANTIMICROBIAL AIR FILTER. E. STEEL INNER WALL AND EXTRA DENSE INSULATION AND VIBRATION ISOLATION.
- F. INSTALL WALL SLEEVE SLOPED PER MFGR RECOMMENDATIONS. G. ENTRY-GARD ANTI-INTRUSTION PROTECTION.
- H. PROVIDE 5 YEARS WARRANTY ON COMPRESSORS BY MANUFACTURER AND ONE YEAR WARRANTY ON
- PARTS AND LABOR. I. SECURE A/C UNITS ON CONCRETE WALL TO WITHSTAND 170 MPH HURRICANE FORCE WINDS

AIR C	ONDITIONING LEGEND
SYMBOL	DESCRIPTION
A/C	THRU THE WALL AIR CONDITION UNIT
ВТМ.	BOTTOM
COND.	CONDENSATE
CONC.	CONCRETE
CFM	CUBIC FEET PER MINUTE
E.F.	EXHAUST FAN
F.L.A.	FULL LOAD AMPS
F.P.M.	FEET PER MINUTE
H.P.	HORSEPOWER
H.R.	HOUR
IN.	INCH
K.W.	KILOWATT
LBS.	POUNDS
MAX.	MAXIMUM
MVD	MANUAL VOLUME DAMPER (OPPOSED BLADE)
NO.	NUMBER
O/A RPM.	OUTSIDE AIR REVOLUTIONS PER MINUTE
R/M. R/A	
REF.	RETURN AIR REFRIGERANT
S/A	SUPPLY AIR
TEMP.	TEMPERATURE
"A"	AIR DISTRIBUTION DESIGNATION
(T)	PROGRAMMABLE THERMOSTAT
	EXHAUST OR RETURN AIR DUCT SECTION
	OPPOSED BLADE MANUAL VOLUME DAMPER
-√ J.c.	1" UNDER CUT DOOR (ALL BEDROOMS AND BATHROOMS)


HVAC DESIGN REQUIRES:	YES	NO
DUCT SMOKE DETECTOR		\searrow
FIRE DAMPER(S)		\searrow
SMOKE DAMPER(S)		$>\!\!<$
FIRE RATED ENCLOSURE		\searrow
FIRE RATED ROOF/FLOOR CEILING ASSEMBLY		><
FIRE STOPPING		><
SMOKE CONTROL SUPPLY		$>\!\!<$

BUILDING DATA (SEE ARCH D	WGS)
WALL R VALUE	R-5
GLASS (ARGON/LOW E) U VALUE	U-0.97
GLASS (ARGON/LOW E) SHGC.	SHGC-0.36
ROOF R VALUE	R-30
NOTE:	


1. ALL R AND U VALUES ARE AS PROVIDED TO THIS ENGINEER

٧	ENTILATION FAN SCHEDU	LE					
UN	UNIT DESIGNATION EF-1						
AR	AREA SERVED SEE PLAN						
OF	PERATING WEIGHT, LBS.	18					
LC	CATION	CEILING					
FA	FAN TYPE CEILING MNTD.						
FAN	TOTAL AIR, CFM DRIVE TYPE FAN WHEEL TYPE FAN TIP SPEED, FPM MAX. FAN SPEED, RPM TOTAL STATIC PRESSURE, IN OF H20 FAN MOTOR WATTS FAN MOTOR STARTER TYPE STARTER FURNISHED BY ELECTRICAL SERVICE AVAILABLE SONES	50 DIRECT CENTRIFUGAL 1125 - 0.125 29 W - CONTRACTOR 120/1ø/60 2.4					
	SIGN MANUFACTURER SIGN MFGR. MODEL NUMBER	COOK - GEMINI					
ACCESSORIES	SERVICE SWITCH SMOKE DETECTORS FIRE DAMPER CONSTRUCTION MULTIBLADE BACKDRAFT DAMPER BIRDSCREEN SOLID STATE SPEED CONTROL THERMOSTAT CONTROL FACTORY FABRICATED CURB MODEL No.	LITTLE GEM-I YES NO NO GALVANIZED STEEL YES YES NO NO NO					
	10 MIN. TIME OFF DELAY RELAY	YES					

NOTES: 1- PROVIDE ALUMINUM EXHAUST GRILLE (TYP.) - ACCEPTABLE MANUFACTURERS COOK, GREENHECK OR PENN 3— EXHAUST FANS SHALL BE INTERLOCKED WITH CORRESPONDING LIGHT SWITCH (TYP.)

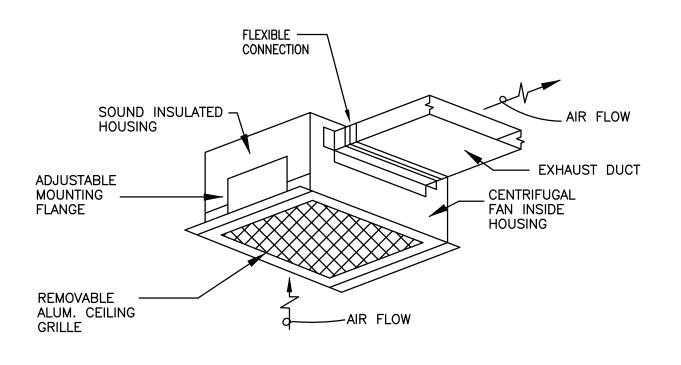

TYPICAL CEILING TYPE EXHAUST FAN DETAIL

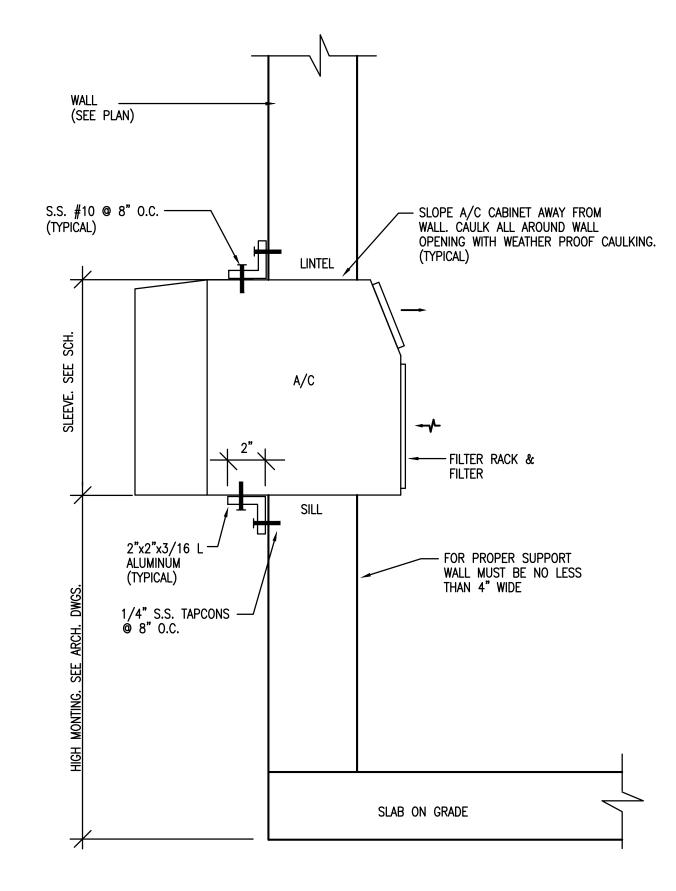


WINDOW TYPE UNIT MOUNTING DETAIL N.T.S.

NOTE:

- 1. INSTALL PER MANUFACTURER RECOMMENDATION
- 2. CAULK / SEAL ALL AROUND THE SLEEVE (PENETRATION). 3. PROVIDE ENTRY-GARD ANTI INSTRUCTION PROTECTION.

ROOM TYPE A/C U	NIT SCHED	ULE	
UNIT DESIGNATION	A/C-1075-1B A/C-1075-2C A/C-1075-3C A/C-1075-4B	A/C-1075-2B A/C-1075-3B	A/C-1075-1A A/C-1075-2A A/C-1075-3A A/C-1075-4A
MOUNTING TYPE	THRU THE WALL	THRU THE WALL	THRU THE WALL
AREA SERVED	SEE PLAN	SEE PLAN	SEE PLAN
DESIGN MANUFACTURER	FRIEDRICH	FRIEDRICH	FRIEDRICH
UNIT TYPE	ELECTRIC HEATER	HEAT PUMP	HEAT PUMP
DESIGN MFG. MODEL NO.	EQ08N11	YS10N10	YS12N33
AIR FLOW (CFM)	175	285	265
OUTSIDE AIR FLOW (CFM)	30	30	30
COOLONG CAPACITY BTU/HR.	7,600	9,400	11,500/11,300
AIR ENTERING EVAPORATOR OF DB/WB	80/67	80/67	80/67
AIR LIVING EVAPORATOR ⁰ F DB/WB	56/-	56/-	56/-
ELECTRIC HEATING CAPACITY BTU/HR	4,000	-	-
HEAT PUMP CAPACITY BTU/HR	-	7,500	9,400/9,000
COP / HSPF		3.0/10.2	2.4/8.2
ELECTRICAL SERVICE AVAILABLE	115-1-60	115-1-60	230-1-60
UNIT TOTAL AMPS, F.L. COOL/HEAT	6.9 / 11.2	7.8/7.6	5.4/5.8
ENERGY EFFICIENCE RATIO (E.E.R.) MIN.	10.5	11.0	10.5
WEIGHT LBS.	84 LBS	131 LBS	136 LBS
SLEEVE	YES	YES	YES
REFRIGERANT	R-410A	R-410A	R-410A
DIMENSIONS (HxWxD)	-	16x26x29	16x26x29

- 1. ALL A/C UNITS SHALL BE PROVIDED WITH OUTSIDE AIR DAMPER, INSECT BARRIER, WASHABLE ANTIMICROBIAL AIR FILET, STEEL INNER WALL AND EXTRA DENSE INSULATION AND VIBRATION
- 2. UNITS SHALL BE PROVIDED WITH 3 SPEED FAN CONTROL, PROGRAMMABLE TIMER AND WIRELESS REMOTE CONTROL.
- 3. ALL A/C UNIT SHALL BE PROVIDED WITH ENTRYGARD ANTI-INTRUSTION PROTECTION.

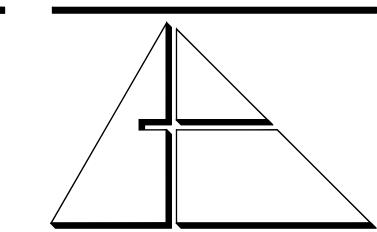

ALLEGUEZ ARCHITECTURE, INC. ARCHITECTURE PLANNING INTERIOR DESIGN CONSTRUCTION MANAGEMENT

901 PONCE DE LEON BLVD., SUITE 202 CORAL GABLES, FLORIDA 33134 tel: 305.461.4001 fax: 305.461.6002 www.alleguezarchitecture.com ■ AA C 0 0 2 7 4 6 ■

MECHANICAL, ELECTRICAL, PLUMBING ENGINEER: GARTEK ENGINEERING CORP. 7210 SOUTHWEST 39TH TERRACE MIAMI, FLORIDA 33155 TEL: (305) 266-8997 FAX: (305) 264-9496 Certificate of Authorization #3144 www.gartek-engineering.com '

CONSULTANTS:

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CITY OF MIAMI LIFE QUEST **RENOVATIONS** 1075 NE 149 ST

Owner's Representative: City of Miami Department of Community Development (305) 416-2084 444 SW 2nd Avenue

MIAMI, FL. 33130

DRAWING TITLE:

MECHANICAL NOTES, SCHEDULES AND DETAILS


ROBERT BETANCOURT P.E. (MECHANICAL) LICENSE NO. 34788 "In my professional judgement and to the best of my knowledge and belief, these plans and specifications comply with applicable Building Codes."


SEPTEMBER 15, 2014

CAD DRAWING NAME:

DATE:

SHEET NO.

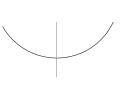

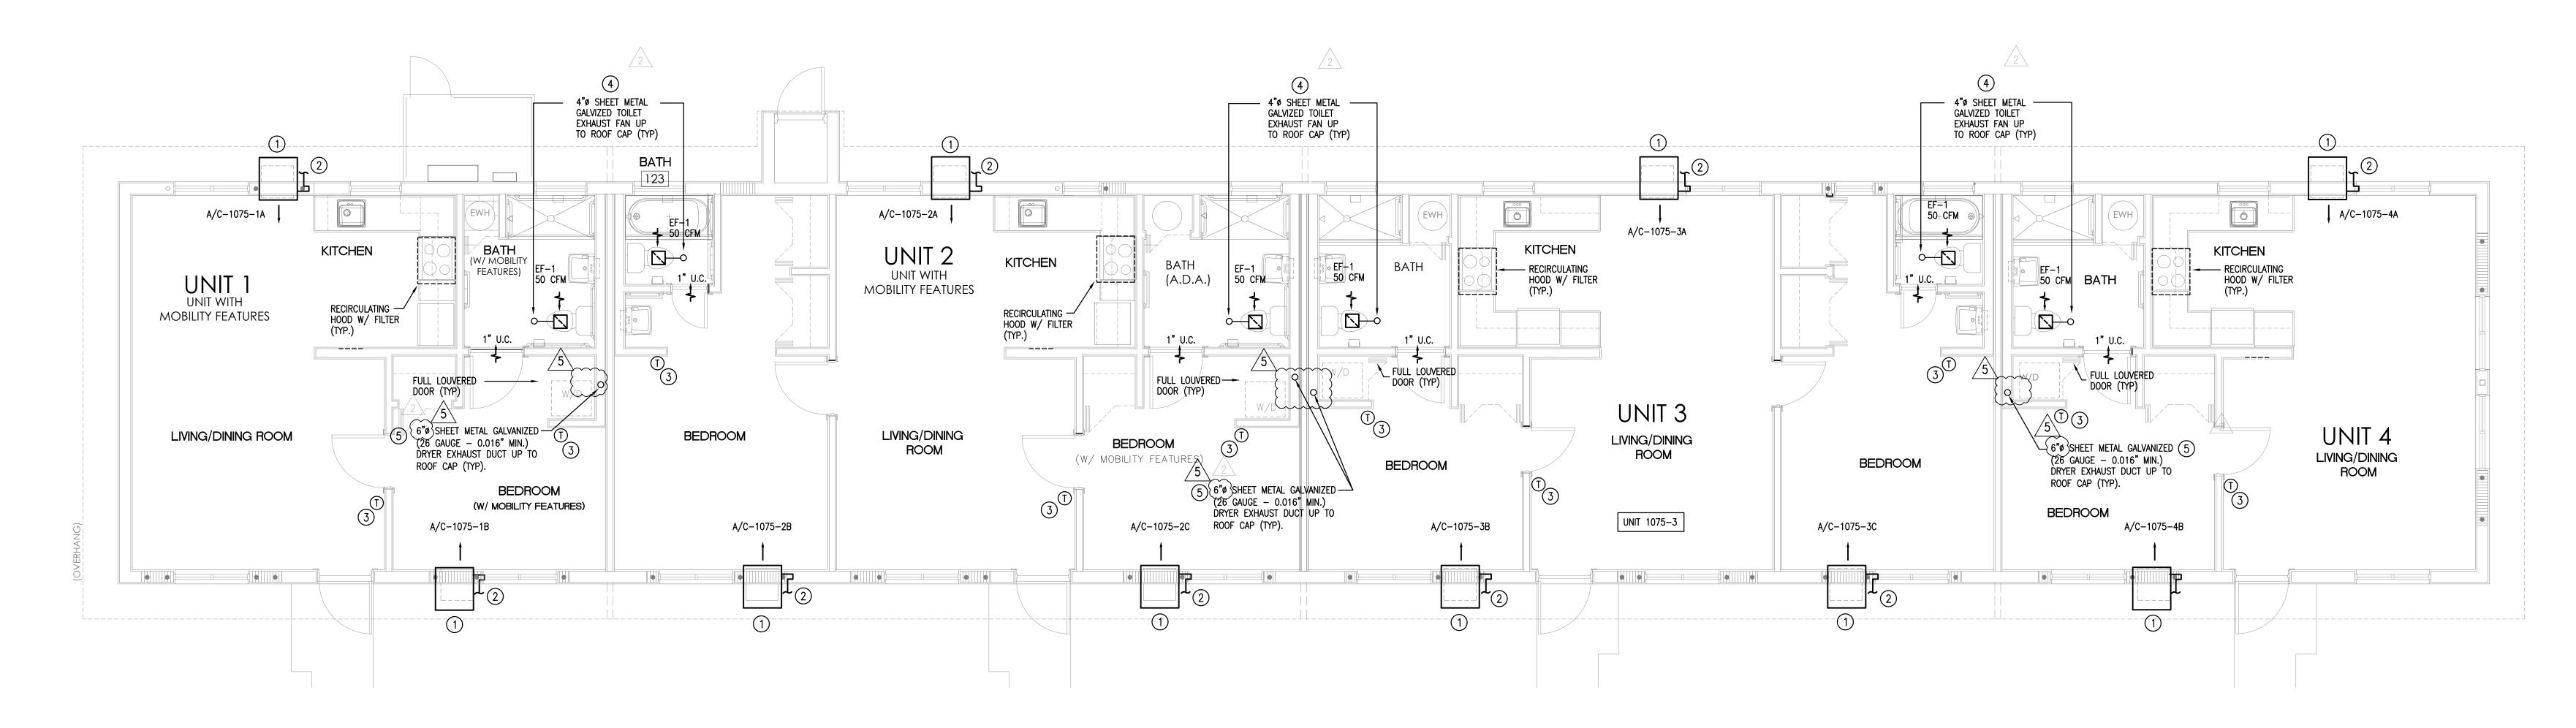

MECHANICAL FLOOR PLAN

1/4" = 1'-0"

11115 NE 13 Ave

CODED NOTES:

- NEW THRU THE WALL A/C UNIT HIGH MOUNTING. SEE ARCH DWGS. FOR EXACT LOCATION AND DWG M-1 FOR MOUNTING DETAIL. (TYPICAL)
- 2"ø INSULATED CD LINE W/ TRAP. FOR CONT. SEE PLUMBING DWGS. (TYPICAL)
- 3 WIRELESS REMOTE THERMOSTAT, VERIFY EXACT LOCATION IN FIELD. (TYPICAL)
- BATHROOM EXHAUST SYSTEM ROOF CAP SHALL BE PROVIDED WITH A CORROSION RESISTANT SCREEN. (TYPICAL)

 THERMOSTAT SHALL BE INSTALLED AT MAX. 48" A.F.F. ON ALL ADA UNITS.

ALL DRYER EXHAUST DUCT SHALL BE PROVIDED WITH SHEET METAL GALVANIZED BACKDRAFT DAMPER. (TYPICAL)

 NOTE:

A L L E G U E Z
ARCHITECTURE, INC.
A R C H I T E C T U R E
PLANNING INTERIOR DESIGN
CONSTRUCTION MANAGEMENT

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PROJEC

CITY OF MIAMI LIFE QUEST RENOVATIONS 1075 NE 149 ST

Owner's Representative:

Lori B. Soto

City of Miami

Department of Community Development

(305) 416-2084

444 SW 2nd Avenue

MIAMI, FL. 33130

DRAWING TITLE:

MECHANICAL FLOOR PLAN

	ROBERT BETANCOURT P.E. (MECHANICAL) LICENSE NO. 34788 "In my professional judgement and to the best of my knowledge and belief, these plans and specifications comply with applicable Building Codes." DATE:
	SEPTEMBER 15, 2014
	REVISED:
	1 10-20-13 BACKGROUND CHANGE 2 12-13-13 BLDG. DEPT. COMMENTS
<u></u>	5 01-16-17 PLAN UPDATE
SE	
BID	CAD DRAWING NAME:
	SHEET NO.

PLUMBING GENERAL NOTES

A. UNLESS OTHERWISE SPECIFIED ON THIS DRAWING CONTRACTOR SHALL REFER TO ORIGINAL LANDLORD SPECIFICATIONS FOR ALL APPLICABLE REQUIREMENTS, NOTES, DETAILS, CONSTRUCTION'S STANDARDS, ETC., COORDINATE WITH LANDLORD REQUIREMENTS PRIOR TO ORDERING AND/OR INSTALLATION OF ANY EQUIPMENT AND ACCESSORIES SHOWN.

1. THE WORK THAT IS TO BE DONE UNDER THIS HEADING INCLUDES THE FURNISHING OF ALL LABOR, MATERIALS AND EQUIPMENT PERMITS, FEES, INSPECTIONS, TEST, INSURANCE, ETC., REQUIRED FOR THE COMPLETION OF THE PLUMBING SYSTEM SHOWN ON DRAWINGS OR LISTED BELOW.

2. CONTRACTOR SHALL VERIFY THE EXACT LOCATION OF EXISTING PIPES BEFORE COMMENCING TO WORK AND MAKE MODIFICATIONS AS REQUIRED WITHOUT ADDITIONAL COST TO THE OWNER.

WITHOUT ADDITIONAL COST TO THE OWNER.

3. ALL PIPING SHALL BE INSTALLED RECESSED IN CHASES, FURRING

4. EXISTING PIPES SERVING AREAS NOT COVERED BY THIS CONTRACT BUT IN SERVICE AT THIS TIME SHALL NOT BE INTERRUPTED EXCEPT AS A TEMPORARY INTERRUPTION COORDINATED WITH THE OWNER AND LANDLORD.

5. PLUMBING CONTRACTOR SHALL PAY ALL FEES, INSPECTION AND CONNECTION CHARGES REQUIRED.

6. PLUMBING CONTRACTOR SHALL VERIFY ALL SPACE CONDITIONS AND DIMENSIONS AT JOB SITE PRIOR TO FABRICATION AND INSTALLATION OF MATERIALS AND EQUIPMENT.

7. COORDINATE ALL WORK WITH OTHER TRADES.

OR PARTITIONS.

8. PLUMBING CONTRACTOR SHALL GUARANTEE ALL WORK FREE OF DEFECTS IN MATERIALS AND WORKMANSHIP FOR A PERIOD OF ONE YEAR FROM DATE OF ACCEPTANCE.

9. PROVIDE SHOCK ABSORBERS SIZE, QUANTITY AND LOCATION AS PER P.D.I. STANDARDS.

10. PROVIDE SHUT-OFF VALVE FOR EACH GROUP OF FIXTURE AND EACH FIXTURE SUPPLY. WATER DISTRIBUTION VALVES 2" AND SMALLER VALVES ARE TO BE TEFLON SEATED, BRONZE BODY, FULL PORT BALL VALVES.

11. WHEREVER DISSIMILAR METALS ARE TO BE JOINED, A DIELECTRIC FITTING SHALL BE PROVIDED TO CONNECT BOTH TYPES OF PIPES.

12. CONTRACTOR SHALL BE RESPONSIBLE TO COORDINATE ALL ROUGH-INS WITH THE MANUFACTURER BEFORE MAKING ANY INSTALLATION.

13. POTABLE HOT AND COLD WATER SYSTEMS SHALL BE "LEAD FREE" WITH LEAD CONTENT NOT EXCEEDING 0.2 PERCENT FOR SOLDER AND FLUXES AND 8 PERCENT FOR PIPE FITTINGS, FIXTURES AND TRIM. CONTRACTOR SHALL VERIFY MANUFACTURER'S COMPLIANCE.

14. ALL POTABLE HOT AND COLD WATER SYSTEMS SHALL BE FLUSHED CLEAR, STERILIZED WITH AN APPROVED SOLUTION AND THROUGHLY FLUSHED OF ALL RESIDUAL SOLUTION AFTER FINAL PRESSURE TESTS AND WITH ALL TRIM AND CONNECTIONS INSTALLED.

15. PROVIDE SHUT-OFF AND VACUUM BREAKER TO ALL HOSE BIBBS AND FAUCETS WITH HOSE-END CONNECTIONS. ALL EXTERIOR HOSE BIBS ARE TAMPER PROOF

16. ALL FLOOR DRAINS SHALL HAVE TRAP PRIMERS TO PROTECT THE SEAL OF THE TRAP.

17. PVC PIPING IS NOT ALLOWED IN RETURN AIR PLENUMS. IF RETURN AIR PLENUMS ARE USED, CONTRACTOR SHALL REPLACE ALL EXISTING PVC PIPING WITH CAST IRON OR COPPER PIPING.

18. DRAINAGE SYSTEM DESIGN IS BASED ON 1/8" PER FOOT MINIMUM FALL FOR PIPES 3" OR LARGER AND 1/4" PER FOOT MINIMUM FALL FOR PIPES 2" OR SMALLER, ANY DEVIATIONS SHALL BE APPROVED BY ARCHITECT/ENGINEER.

19. ALL VENT THROUGH ROOF OPENINGS SHALL BE OFFSETED TO A MINIMUM DISTANCE OF 3'-0" FROM PARAPET WALL OR ROOF EDGE. SEE ARCHITECTURAL DRAWINGS FOR ROOF FLASHING. LEAD FLASHING WILL NOT BE ACCEPTED.

20. COORDINATE SCHEDULING OF ALL REQUIRED INSPECTIONS WITH APPROPRIATE REGULATORY BODIES.

21. ALL FIRE RATED WALL PENETRATIONS SHALL BE PROTECTED WITH A UL APPROVED FIRE STOPPING ASSEMBLY SYSTEM.

22. CONDENSATE DRYWELL SHALL BE LOCATED MINIMUM 1 FOOT AWAY FROM THE

STRUCTURE SIDEWALL, CONTRACTOR TO COORDINATE EXACT LOCATION IN FIELD.

NOTE: ALL PLUMBING FIXTURES SHALL COMPLY WITH TABLE 604.4 FBC - PLUMBING

FOR " MAXIMUN FLOW RATES AND CONSUMPTION FOR PLUMBING FIXTURES

PLUMBING DEMOLITION NOTES

1. SITE INVESTIGATION:

AND FIXTURE FITTINGS"

EXAMINATION OF CONTRACT DOCUMENTS AND SITE OF WORK; THE CONTRACTOR AND SUBCONTRACTOR IS REQUIRED, BEFORE SUBMITTING HIS/HER PROPOSAL, TO VISIT THE SITE OF THE PROPOSED WORK AND FAMILIARIZE HIMSELF/HERSELF WITH THE NATURE AND EXTENT OF THE WORK AND ANY LOCAL CONDITIONS THAT MAY IN ANY MANNER AFFECT THE WORK TO BE DONE AND EQUIPMENT, MATERIALS AND LABOR REQUIRED THEREFOR, SINCE THE WORK INVOLVES EXISTING BUILDINGS, SYSTEMS AND FACILITIES, SPECIAL CONSIDERATION SHALL BE GIVEN TO EXAMINATION OF WORKING CONDITIONS, EXISTING FACILITIES AND ALL BUILDING STRUCTURES TO FAMILIARIZE HIMSELF/HERSELF WITH ALL EXISTING CONDITIONS. SLIGHT VARIATION OF ROUTING AND OR CONSTRUCTIONS SHOULD BE ANTICIPATED BY THIS CONTRACTOR TO AVOID CONFLICTS WITH OTHER TRADES ARE EXPRESSLY INCLUDED AS PART OF THE WORK WHENEVER REQUIRED AT NO ADDITIONAL COST TO THE OWNER. IGNORANCE ON THE PART OF THE CONTRACTOR WILL IN NO WAY RELIEVE HIM/HER OF THE OBLIGATIONS AND RESPONSIBILITIES ASSUMED UNDER THIS CONTRACT.

2. THE NATURE OF THE REMODEL TYPE CONSTRUCTION POSES SPECIAL PROBLEMS FOR THE DESIGNER ENGINEERS AS WELL AS THE PLUMBING CONTRACTOR. EVERY EFFORT HAS BEEN MADE BY THE ENGINEERS TO SHOW AND VERIFY, WHERE POSSIBLE, THE LOCATION OF THE EXISTING PLUMBING SYSTEMS. THE MAJOR PORTION OF THE PLUMBING SYSTEMS ARE AS SHOWN ON THE DRAWINGS: HOWEVER MINOR DEVIATIONS MAY BECOME EVIDENT AS THE JOB PROGRESSES. NO ADVANTAGE IS TO BE TAKEN BY THE PLUMBING CONTRACTOR BECAUSE THESE MINOR DIFFERENCES. PLUMBING CONTRACTOR SHALL PERFORM A FIELD VERIFICATION BEFORE BIDDING THIS PROJECT.

3. CONTRACTOR WILL BE RESPONSIBLE FOR COORDINATING HIS/HER DEMOLITION WORK WITH OTHER TRADES, AND TO PROTECT FROM DAMAGE EXISTING PIPES USED FOR FUTURE CONNECTIONS.

4. CONTRACTOR SHALL FIELD VERIFY THE EXACT LOCATION, DEPTH AND CONDITION OF ALL EXISTING PIPES, IN EACH UNIT, INCLUDING THROUGH THE USE OF VIDEO INSPECTION.

ANY AND ALL DEFICIENCIES ENCOUNTERED THAT MAY NEGATIVELY IMPACT THE PLUMBING DESIGN, RESULTING IN ADDITIONAL CONSTRUCTION COSTS, SHALL BE BROUGHT TO THE IMMEDIATE ATTENTION OF A.E. FOR CONSIDERATION AND APPROVAL PRIOR TO SUCH TASKS BEING PERFORMED.

5. EXISTING PIPES SERVING AREAS NOT COVER BY THIS CONTRACT BUT IN SERVICE AT THIS TIME SHALL NOT BE INTERRUPTED UNLESS IT IS A TEMPORARY INTERRUPTION COORDINATED WITH THE OWNER.

6. PLUMBING CONTRACTOR SHALL CAP ALL UNUSED DRAINAGE SYSTEMS BELOW FINISHED FLOOR AND REMOVE ALL UNUSED PORTIONS ABOVE GROUND AND ALL ASSOCIATED ACCESSORIES AND TRIMS.

7. PLUMBING CONTRACTOR SHALL CAP ALL UNUSED DOMESTIC HOT AND COLD WATER LINES AT BRANCH VALVES FROM MAIN DISTRIBUTION LINES AND REMOVE ALL UNUSED PIPING, HANGERS AND ACCESSORIES.

8. ALL CAPPED PLUMBING LINES SHALL BE INSPECTED PRIOR TO COVERING

PLUMBING SPECIFICATION

1. GENERAL:

MATERIAL SHALL BE NEW, UNUSED, BEST OF THEIR RESPECTIVE KINDS AND FREE FROM DEFECTS IN WORKMANSHIP; IN CONFORMANCE WITH THE LATEST PUBLICATIONS IN FORCE AT TIME OF BIDDING.

2. PIPE AND FITTINGS:

A. SANITARY SOIL AND VENT PIPING: SERVICE WEIGHT CAST IRON BELL AND SPIGOT PIPE AND FITTINGS, ASTM.A74— LATEST EDITION, NO HUB CAST IRON PIPE AND FITTINGS, CISPI. 301—LATEST EDITION, PIPE AND FITTINGS SHALL BE MARKED WITH THE COLLECTIVE TRADEMARK OF THE CAST IRON SOIL PIPE INSTITUTE, OD DWV. COPPER PIPE WITH CAST BRASS OR WROUGHT COPPER SOLDER JOINT FITTINGS, ASTM. B306—79, (ABOVE GROUND). VENTING AS HEREIN BEFORE SPECIFIED OR GALVANIZED THREADED STEEL WITH MALLEABLE IRON FITTINGS.

B. DOMESTIC WATER SUPPLY PIPING: COPPER PIPE TYPE 'L' WITH BRONZE OR WROUGHT COPPER SOLDER JOINT FITTINGS, ASTM.B88—78.

C. CONDENSATE PIPING: AS HEREIN BEFORE SPECIFIED FOR SANITARY SOIL WASTE AND VENT PIPING.

C. CONDENSATE PIPING: AS HEREIN BEFORE SPECIFIED FOR SANITARY SOIL, WASTE AND VENT PIPING.

ALTERNATE:

A. SANITARY SOIL/ STORM DRAINAGE BELOW GROUND: SCHEDULE 40 SOLID PLASTIC PVC PIPE ASTM D1785.

3. JOINTS AND METHODS OF CONNECTION:

A. CAST IRON BELL AND SPIGOT PIPE: COMPRESSION GASKET. INSTALL PER MANUFACTURER'S RECOMMENDATION. GASKET AND PIPE BY SAME MANUFACTURER.

B. CAST IRON NO—HUB PIPE: MAKE JOINTS WITH NEOPRENE RUBBER SLEEVE AND STAINLESS STEEL RING CLAMP PER MANUFACTURER'S RECOMMENDATIONS. GASKET AND PIPE BY SAME MANUFACTURER.

C. DWV COPPER PIPE: JOINT WITH 95-5 TIN-ANTIMONY SOLDER, INSTALL PER MANUFACTURER'S RECOMMENDATIONS.

D. TYPE 'L' COPPER TUBE: JOIN WITH 95-5 TIN-ANTIMONY SOLDER, INSTALL PER MANUFACTURER'S RECOMMENDATIONS.

E. STEEL PIPE:

a. THREADED JOINTS: AFTER CUTTING AND BEFORE THREADING, REAM ALL PIPE AND REMOVE BURRS. MAKE JOINTS WITH JOINT COMPOUND APPLIED TO MALE THREADS ONLY.

b. FLANGED JOINTS: STANDARD WEIGHT, 150 P.S.I. STEEL, WITH APPROVED RED RUBBER GASKET OR NEOPRENE RUBBER GASKET, INSTALL AS PER MANUFACTURER'S RECOMMENDATIONS.

F. SCHEDULE 40 PVC MOLDED PREFORMED FITTINGS, PVC-DWV, SOCKET SOLVENT CEMENT, ASTM D-2467

4. UNIONS AND FLANGES:

A. COPPER PIPE: BRONZE UNIONS FOR 2 INCHES AND SMALLER. FOR 2-1/2 INCHES AND LARGER USE BRONZE FLANGED CONNECTIONS 150 POUND CLASS.

B. DIELECTRIC UNIONS OR FLANGES: UNIONS SHALL MEET DIMENSIONAL REQUIREMENTS AND TENSILE STRENGTH OF PIPE UNIONS IN ACCORDANCE WITH FED. SPEC. WW-U-531E. UNIONS OR FLANGES SHALL BE SUITABLE FOR REQUIRED OPERATING PRESSURES AND TEMPERATURE CONDITIONS. UNIONS SHALL HAVE METAL CONNECTIONS ON BOTH ENDS. ENDS SHALL BE THREADED OR SOLDERED TO MATCH ADJACENT PIPING. METAL PARTS OF UNION OR FLANGED SHALL BE SEPAREATED TO PREVENT CURRENT FLOW BETWEEN DISSIMILAR METALS. EPCO DIELECTRIC PIPE FITTINGS OR EQUIVALENT.

5. ESCUTCHEONS:

CHROME PLATED OR STAINLESS STEEL WITH SET SCREWS FOR HOLDING SECURELY IN PLACE. USE ESCUTCHEONS ON PIPES PASSING THROUGH WALLS, FLOORS AND CEILINGS OF FINISHED AREAS.

6. PIPE INSULATION:

A. ALL CONDENSATE LINES SHALL BE INSULATED WITH 3/4" FIRE RETARDANT ARMAFLEX INSULATION WITH A MAXIMUM OF 25/50 FLAME SPREAD AND SMOKE DEVELOPED RESPECTIVELY.

B. ALL HOT WATER LINES SHALL BE INSULATED WITH 1" FIRE RETARDANT ARMAFLEX INSULATION WITH A MAXIMUM OF 25/50 FLAME SPREAD AND SMOKE DEVELOPED RESPECTIVELY.

C. ALL PLUMBING PIPES AT THE STAGE AND SEATING AREAS SHALL BE INSULATED WITH 1" FIRE RETARDANT ARMAFLEX INSULATION WITH A MAXIMUM OF 25/50 FLAME SPREAD AND SMOKE DEVELOPED RESPECTIVELY.

PLUMBING LEGEND

SAN SANITARY DRAIN

SAN SANITARY DRAIN

SANITARY VENT LINE

SD STORM DRAIN

CD CONDENSATE DRAIN LINE

P&T PTR PRESSURE AND TEMPERATURE RELIEF LINE

G G GAS LINE

CW COLD WATER LINE

ICW IRRIGATION COLD WATER LINE

HWR HOT WATER RECIRCULATING LINE

BV FULL PORT-BONZE/BRASS TEFLON SEATED BALL VALVE

CV CHECK VALVE

BALANCING VALVE

VIV VALVE IN RISER

HB HOSE BIBB W/ VACUUM BREAKER

—— — HW HOT WATER LINE

BALANCING VALVE

VIV VALVE IN RISER

HB HOSE BIBB W/ VACUUM BREAKER

T AC AIR CHAMBER

SA SHOCK ARRESTOR (P.D.I. SIZE 'A' TYPICAL UNLESS NOTED OTHERWISE.)

CO CLEAN—OUT PLUG

WCO WALL CLEAN—OUT

CNTE CONNECT TO EXISTING

FD FLOOR DRAIN

RD ROOF DRAIN

ORD EMERGENCY OVERFLOW ROOF DRAIN

VTR VENT THRU ROOF

AP ACCESS PANEL

FOR SUPPLY

FUEL OIL SUPPLY FUEL OIL RETURN FUEL OIL VENT CLEAN OUT WALL CLEAN OUT FLOOR CLEAN OUT CLEAN OUT TO GRADE FIRE DEPT. CONN. (SIAMESE) FIRE HYDRANT FIRE HOSE CABINET FIRE VALVE CABINET W/ HFV FIRE EXTINGUISHER CAB. W/ FE FIRE EXTINGUISHER FIRE EXT./CARBON DIOXIDE WATER HÉATER UNDER GROUND

DUCTILE IRON PIPE
CORRUGATED METAL PIPE
CAST IRON PIPE
TRAP PRIMER (RESEALER)
AIR CONDITIONER
THERMOMETER
FIRE HOSE VALVE
AIR HANDLING UNIT
CFILING

UNDERGROUND

RAIN WATER LEADER


EF LINE

N SEATED

R
A'
E.)

PLUMBING FIXTURE CONNECTION SCHEDULE							
SYMBOL DESCRIPTION DRAIN WATER			HOT WATER	MANUFACTURER/MODEL	TRIM		
P-1	WATER CLOSET	4"	1/2"		AMERICAN STANDARD "CADET" 3 FLOWISE RIGHT HEIGHT #2835.128.020 VITREOUS CHINA, LOW CONSUMPTION, 1.28 GPF, ELONGATED SIPHON JET FLUSH ACTION 16-1/2" RIM HEIGHT.	CLOSE-COUPLED TANK, CHROME FINISH TRIP LEVER CENTOCO 820STS.001 HEAVY DUTY TOILET SEAT. FOR ELONGATED BOWL OPEN FRONT SEAT. SUPPLY: MCGUIRE BV172 TOILET SUPPLY, CHROME FINISH POLISHED BRASS WITH ESCUTCHEON AND STAINLESS STEEL BRAIDED RISER. FLOOR FLANGE WITH ALL BRASS BOLTS AND WITH RUBBER GASKET.	
P-1H	WATER CLOSET (HANDICAP)	4"	1/2"		AMERICAN STANDARD "CADET" 3 FLOWISE RIGHT HEIGHT #2835.128.020 VITREOUS CHINA, LOW CONSUMPTION, 1.28 GPF, ELONGATED SIPHON JET FLUSH ACTION 16-1/2" RIM HEIGHT.	CLOSE-COUPLED TANK, CHROME FINISH TRIP LEVER CENTOCO 820STS.001 HEAVY DUTY TOILET SEAT. FOR ELONGATED BOWL OPEN FRONT SEAT. SUPPLY: MCGUIRE BV172 TOILET SUPPLY, CHROME FINISH POLISHED BRASS WITH ESCUTCHEON AND STAINLESS STEEL BRAIDED RISER. FLOOR FLANGE WITH ALL BRASS BOLTS AND WITH RUBBER GASKET.	
P-2	LAVATORY	1 1/4"	1/2"	1/2"	AMERICAN STANDARD "DECLYNE "#0321.075 FOR CONCEALED ARMS SUPPORTS, WALL HUNG, 4" CENTERS, VITREOUS CHINA, REAR OVERFLOW, SOAP DEPRESSION, FAUCET LEDGE. CARRIER: WATTS TCA-411 SINGLE CARRIER	FAUCET: AMERICAN STANDARD MODEL 8115F, 4" CENTER, SINGLE LEVER FAUCET, POLISHED CHROME FINISH, SPEED CONNECT POP-UP DRAIN. DRAIN: AMERICAN STANDARD POP-UP DRAIN AND TAILPIECE DRAIN: McGUIRE #8872C POLISHED CHROME FINISHED BRASS P-TRAP WITH CLEAN OUT PLUG AND ESCUTCHEON. SUPPLY: MCGUIRE # BV170 FAUCET SUPPLY, CHROME FINISH POLISHED BRASS WITH ESCUTCHEON AND FLEXIBLE COPPER RISER.	
	LAVATORY—ADA FOR ADA HEIGHT REFERS TO ARCHITECTURAL DRAWINGS	1 1/4"	1/2"	1/2"	AMERICAN STANDARD "DECLYNE "#0321.075 FOR CONCEALED ARMS SUPPORTS, WALL HUNG, 4" CENTERS, VITREOUS CHINA, REAR OVERFLOW, SOAP DEPRESSION, FAUCET LEDGE. CARRIER: WATTS TCA-411 SINGLE CARRIER	FAUCET: AMERICAN STANDARD MODEL 8115F, 4" CENTER, SINGLE LEVER FAUCET, POLISHED CHROME FINISH, SPEED CONNECT POP-UP DRAIN, ADA COMPLIANT. DRAIN: AMERICAN STANDARD POP-UP DRAIN AND TAILPIECE DRAIN: MCGUIRE #155 WCC OFFSET OPEN GRID DRAIN DRAIN:McGUIRE #8872C POLISHED CHROME FINISHED BRASS P-TRAP WITH CLEAN OUT PLUG AND ESCUTCHEON. SUPPLY: MCGUIRE # BV170 FAUCET SUPPLY, CHROME FINISH POLISHED BRASS WITH ESCUTCHEON AND FLEXIBLE COPPER RISER. INSULATION: TPW2000WC PROWRAP VANDAL RESISTANT SANITARY COVERING, FLEXIBLE SEAMLESS MOLDED CLOSED-CELL PVC RESIN, FORMULATED WITH ANTI-MICROBIAL ADDITIVE. (ADA ONLY)	
P-3	SHOWER & SHOWER TUB	2"	1/2"	1/2"	SEE ARCHITECTURAL DRAWINGS	FAUCET: AMERICAN STANDARD SHOWER MODEL #T385.501/R120SS, SHOWER -TUB MODEL # T385.502/R120SS PRESSURE BALANCING MIXING VALVE, BRASS BODY, WASHERLESS CERAMIC DRIP-FREE DISC VALVE CARTRIDGE, INTEGRAL HOT LIMIT STOP, SCREW DRIVERS STOPS, METAL WALL ESCUTCHEON, METAL LEVER HANDLE, 1.5 GPM SHOWER HEAD. SHOWER DRAIN: WATTS#FD-100-A-2" FLOOR DRAIN OUTLET.	
P-3H	SHOWER (HANDICAP)	2"	1/2"	1/2"		FAUCET: AMERICAN STANDARD #T385.500/R120SS, PRESSURE BALANCING MIXING VALVE, BRASS BODY, WASHERLESS CERAMIC DRIP-FREE DISC VALVE CARTRIDGE, INTEGRAL HOT LIMIT STOP, SCREW DRIVERS STOPS, METAL WALL ESCUTCHEON, METAL LEVER HANDLE, AMERICAN STANDARD 1662.604 WATER-SAVING SPRAY HAND SHOWER 1.5 GPM CHROME PLATED HAND SHOWER WITH FLEXIBLE METAL HOSE, 1660.400 IN-LINE VACUUM BREAKER, WALL SUPPLY, AND 36" SLIDE BAR. DRAIN: WATTS#FD-100-A-2" FLOOR DRAIN OUTLET.	
P-4	SINK (SINGLE COMP.)	1 1/2"	1/2"	1/2"	ELKAY MODEL PSRQ1918 TOP MOUNT SINK NICKEL BEARING STAINLESS STEEL, GAUGE 20, 3 HOLES FAUCET, 19" X 18" X 7 1/8" OVERALL SIZE, SATIN FINISH, FULLY UNDERCOATED, 3 1/2" DRAIN OPENING	FAUCET: ELKAY LK1000CR, SINGLE LEVER FAUCET, 3 HOLES REQUIRED, CERAMIC DISC CARTRIDGE, OVERALL HEIGHT 7 1/2", SPOUT REACH 8" DRAIN: ELKAY #LK-35 BASKET STRAINER, CHROME PLATED CAST BRASS WITH TAILPIECE. MACGUIRE# #8912 POLISHED CHROME PLATED CAST BRASS P-TRAP WITH CLEANOUT PLUG AND ESCUTCHEON. MCGUIRE#BV170 FAUCET SUPPLIES, CHROME FINISH, COMMERCIAL DUTY 1/4 TURN BALL VALVE ANGLE STOP.	
P-4H	SINK-ADA (SINGLE COMP.)	1 1/2"	1/2"	1/2"	ELKAY MODEL PSRADQ191955L SELF—RIMMING SINK NICKEL BEARING STAINLESS STEEL, GAUGE 20, 3 HOLES FAUCET, 19 1/2" X 19" X 5 1/2" OVERALL SIZE, SATIN FINISH, FULLY UNDERCOATED, 3 1/2" DRAIN OPENING.	FAUCET: ELKAY LK1000CR, SINGLE LEVER FAUCET, 3 HOLES REQUIRED, CERAMIC DISC CARTRIDGE, OVERALL HEIGHT 7 1/2", SPOUT REACH 8" DRAIN: ELKAY #LK-35 BASKET STRAINER, CHROME PLATED CAST BRASS WITH TAILPIECE. MACGUIRE# #8912 POLISHED CHROME PLATED CAST BRASS P-TRAP WITH CLEANOUT PLUG AND ESCUTCHEON. MCGUIRE#BV170 FAUCET SUPPLIES, CHROME FINISH, COMMERCIAL DUTY 1/4 TURN BALL VALVE ANGLE STOP.INSULATION: TPW2000WC PROWRAP VANDAL RESISTANT SANITARY COVERING, FLEXIBLE SEAMLESS MOLDED CLOSED-CELL PVC RESIN, FORMULATED WITH ANTI-MICROBIAL ADDITIVE.	
P-5	CLOTHES WASHER	2"	1/2"	1/2"		ACORN HOSE VALVE#8131-CR STRAIGHT NOSE WITH VACUUM BREAKER OATEY # 38928 CENTER DRAIN WASHING MACHINE BOX.	
WH-1	WATER HAMMER ARRESTORS		1/2"	1/2"		WATTS PDI CERTIFIED. PRECHARGED DRAWN COPPER	
WCO	WALL CLEANOUT	2"				WATTS LINE CLEANOUT #CO-450-RD	
FCO	GRADE CLEANOUT	4"				WATTS ACCESS HOUSING #CO-300-MF	

		WATE	IR HE	ATER	SCHĘĎ	ĴĽĔ	
MARK	CAP. GAL.	HEATING SOURCE	ELEMENTS	KW. OR BTUH	VOLTAGE	EF	REMARKS
EWH-1 UNITS #1, #4	30	ELECTRICAL	SINGLE	4.5 KW	240 V, 1PH, 60HZ	0.95	LOCHINVAR MODEL JRA030KS
EWH-2 UNITS #2, #3	40	ELECTRICAL	SINGLE	4.5 KW	240 V, 1PH, 60HZ	0.95	LOCHINVAR MODEL JRAO40KS
'						•	

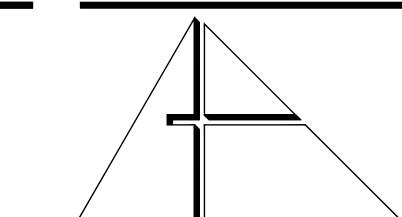

A L L E G U E Z ARCHITECTURE, INC.
A R C H I T E C T U R E PLANNING INTERIOR DESIGN CONSTRUCTION MANAGEMENT

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901 PONCE DE LEON BLVD., SUITE 202

CONSULTANTS:

MECHANICAL, ELECTRICAL, PLUMBING ENGINEER:

GARTEK ENGINEERING CORP.
7210 SOUTHWEST 39TH TERRACE
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Gartek Project No. 2867

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PROJEC

CITY OF MIAMI LIFE QUEST RENOVATIONS 1075 NE 149 ST

Owner's Representative:

Lori B. Soto

City of Miami

Department of Community Development

(305) 416-2084

444 SW 2nd Avenue

MIAMI, FL. 33130

DRAWING TITLE:

PLUMBING NOTES SPECS., LEGEND, & SCHEDULES

ROBERT BETANCOURT P.E. (MECHANICAL)
LICENSE NO. 34788
"In my professional judgement and to the best of my knowledge and belief, these plans and specifications comply with applicable Building Codes."

DATE:

SEPTEMBER 15, 2014


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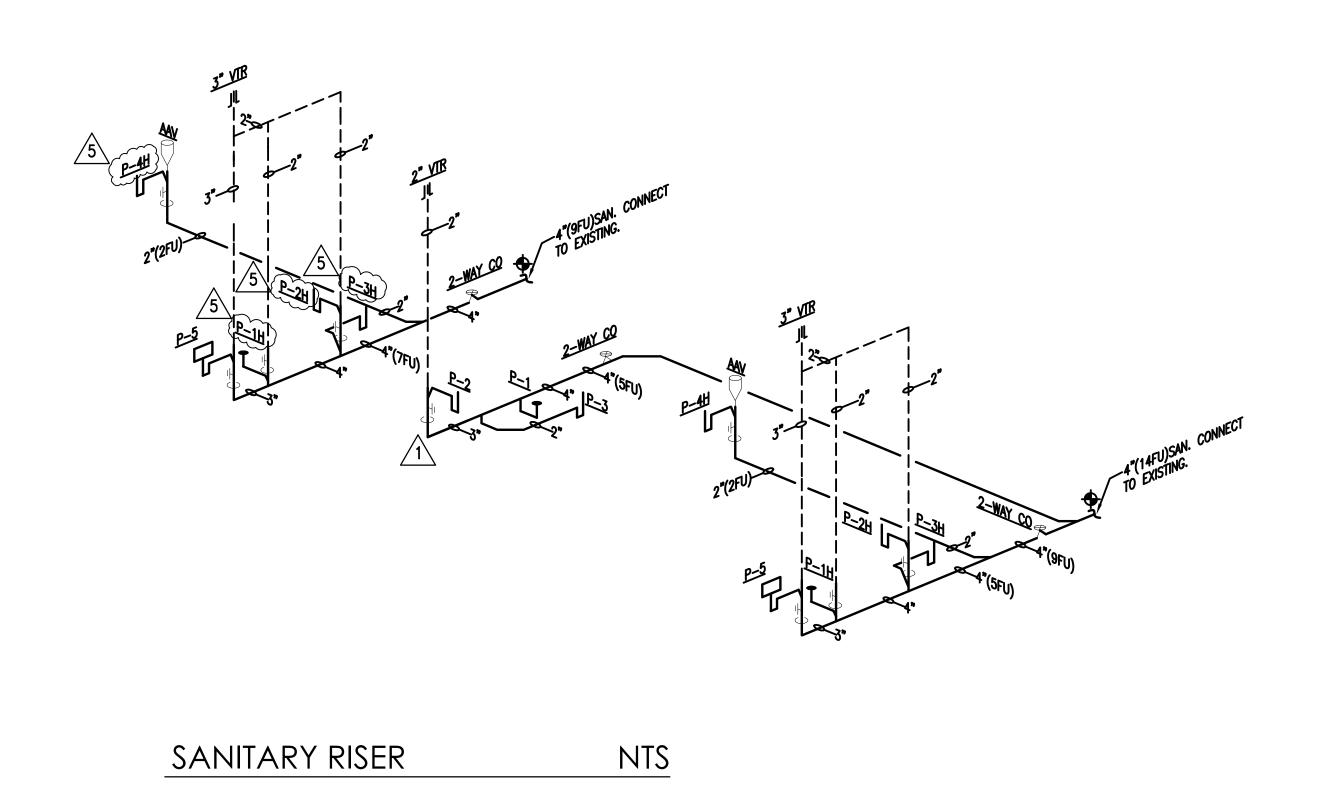
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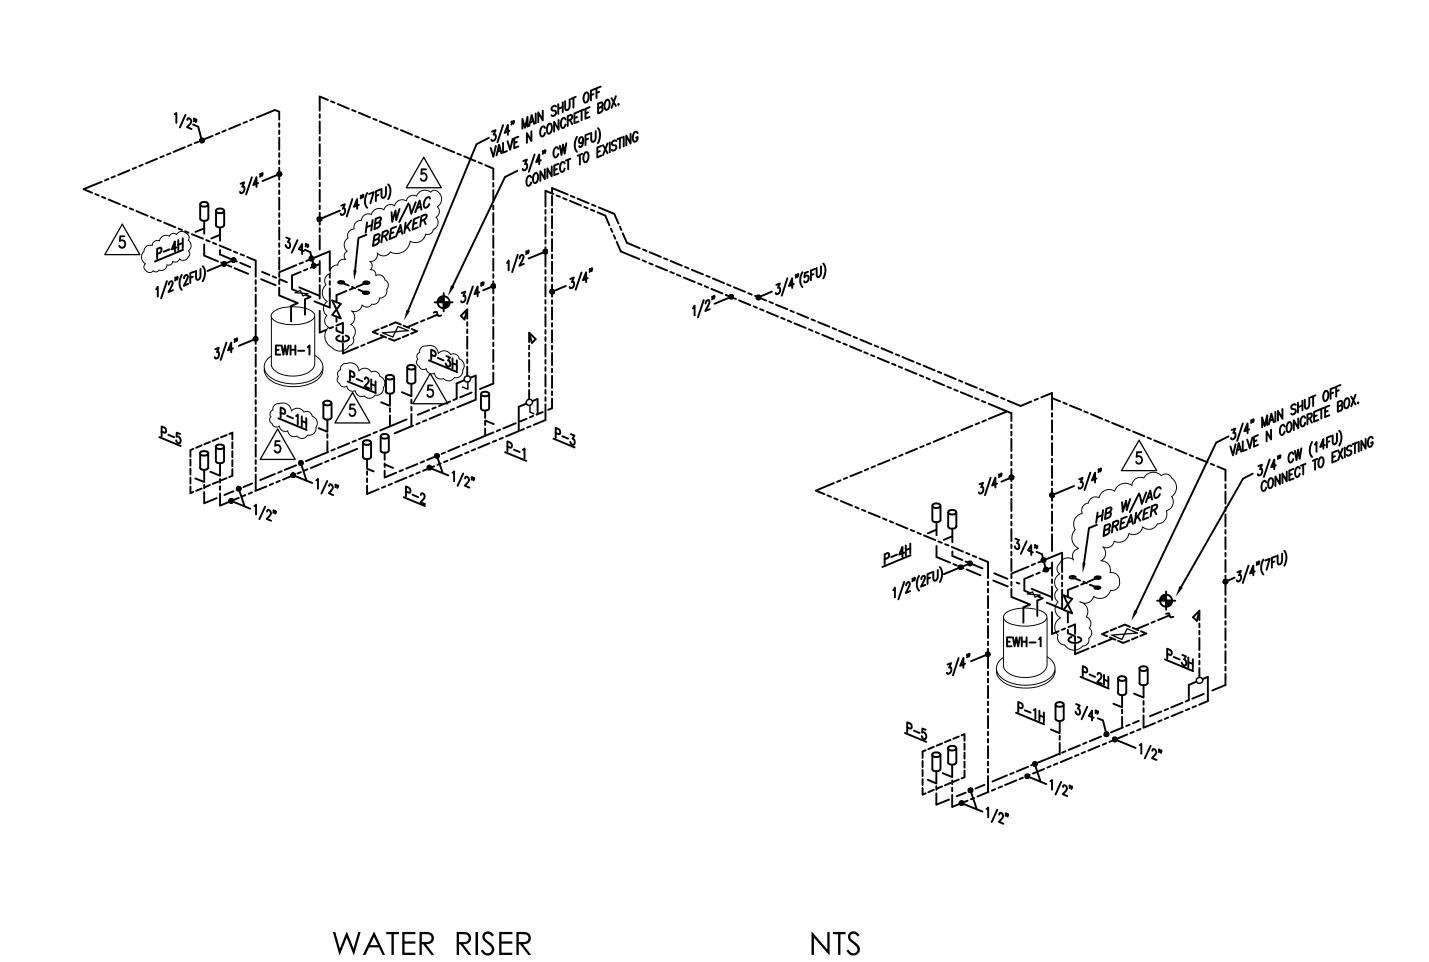
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SHEET NO.

P-1





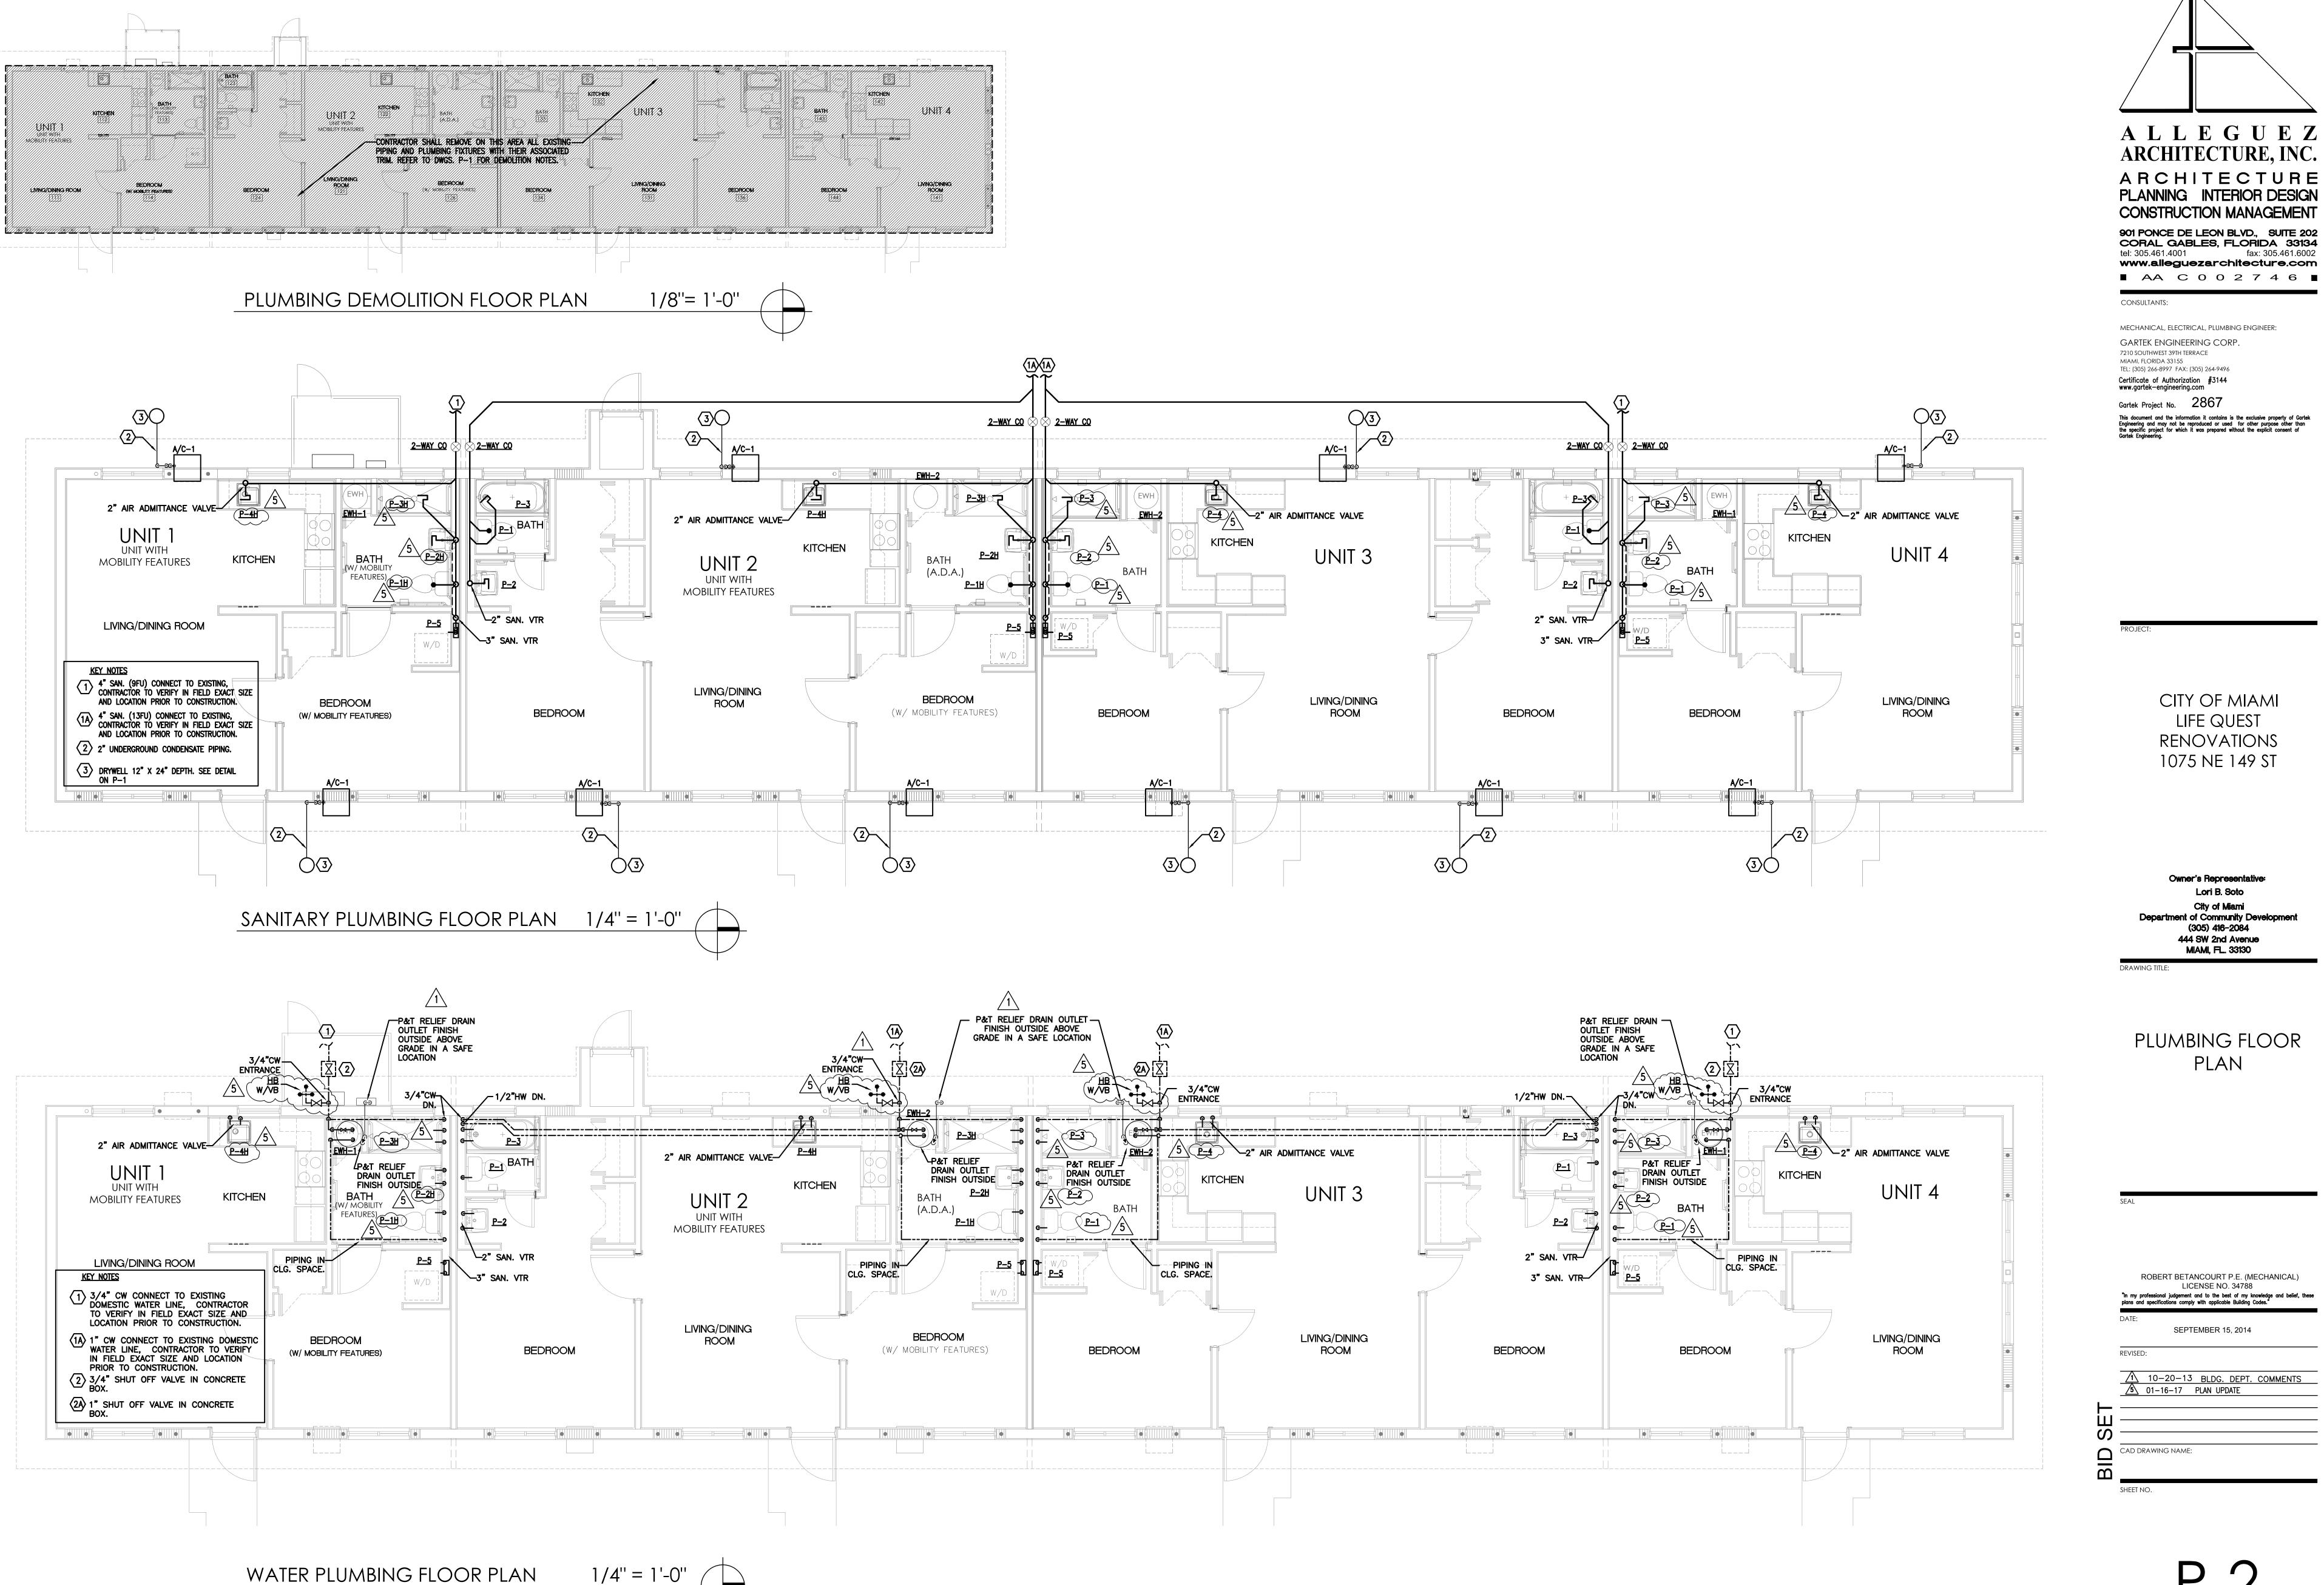

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PLUMBING RISERS

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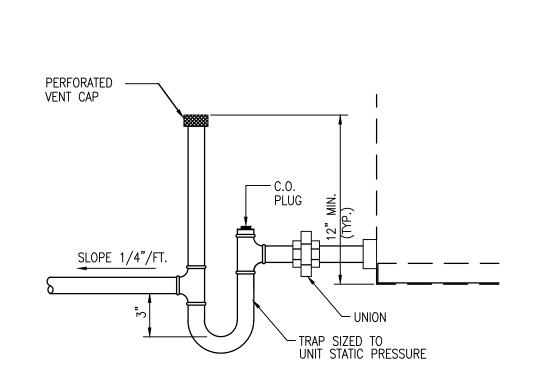
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5 01-16-17 PLAN UPDATE


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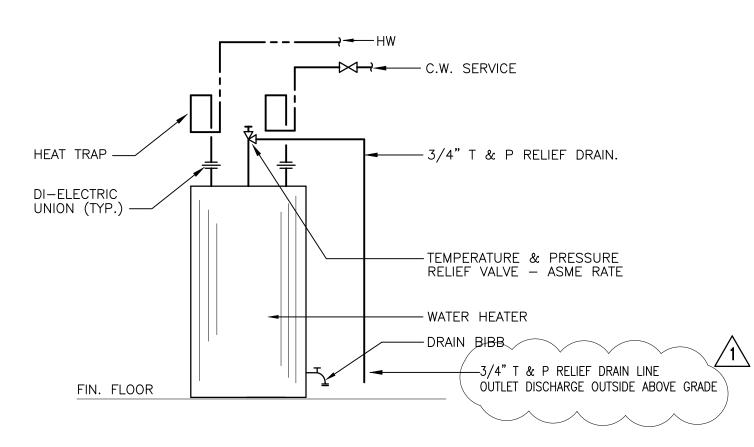
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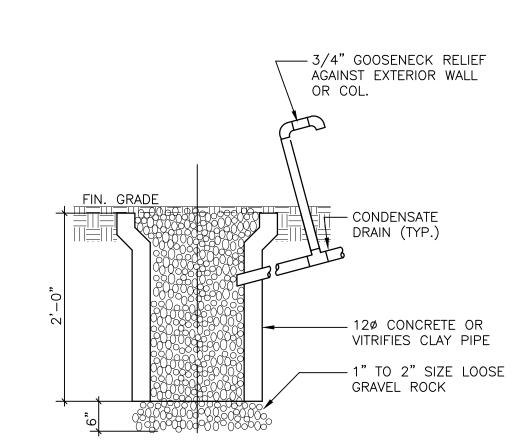
CONDENSATE TRAP DETAIL
SCALE: N.T.S.




2 TYPICAL LAVATORY MOUNTING DETAIL P4 SCALE: N.T.S.




3 ELECTRIC WATER HEATER DETAIL P4 SCALE: N.T.S.

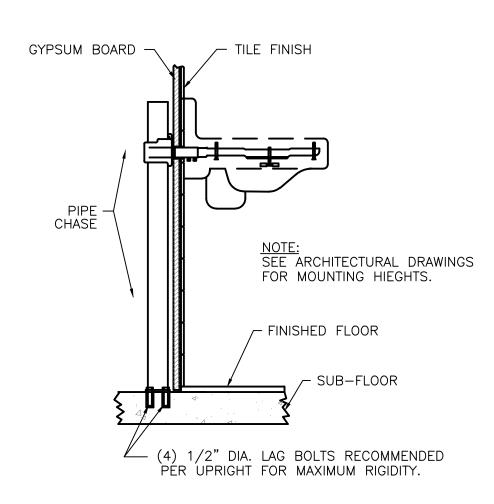


4 DRYWELL DETAIL P4 SCALE: N.T.S.

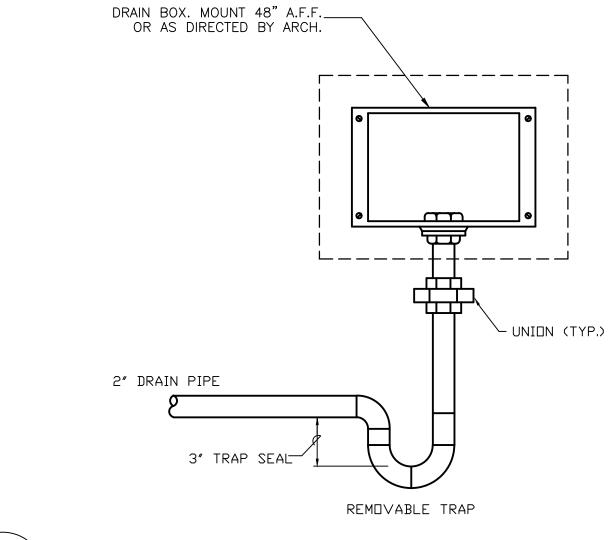

5 WASHING MACHINE DRAIN BOX DETAIL P4 SCALE: N.T.S.

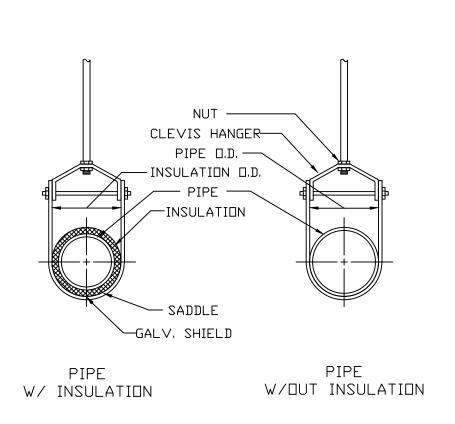


6 CLEVIS PIPE HANGER DETAIL P4 SCALE: N.T.S.

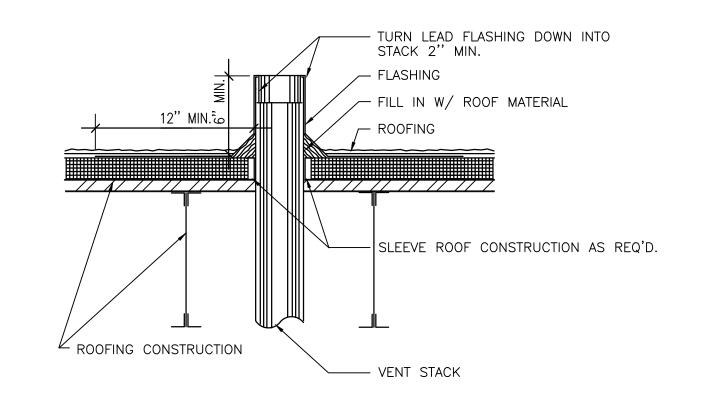


NOTE:

ANY VENT PIPE WITHIN 10' OF ANY DOOR , WINDOW , OR EXHAUST OPENING OR OUTSIDE AIR INTAKE SHALL EXTEND NOT LESS THAN 3' ABOVE SAME .

7 VENT-THRU ROOF DETAIL P4 SCALE: N.T.S.

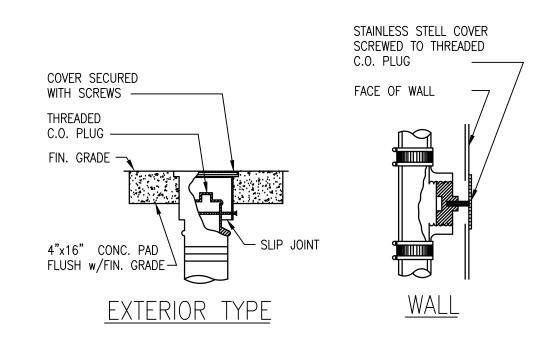

8 TYPICAL CLEANOUT DETAIL P4 SCALE: N.T.S.

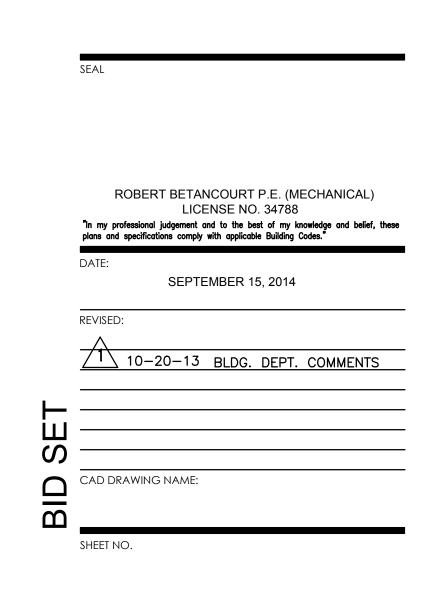

ALLEGUEZ

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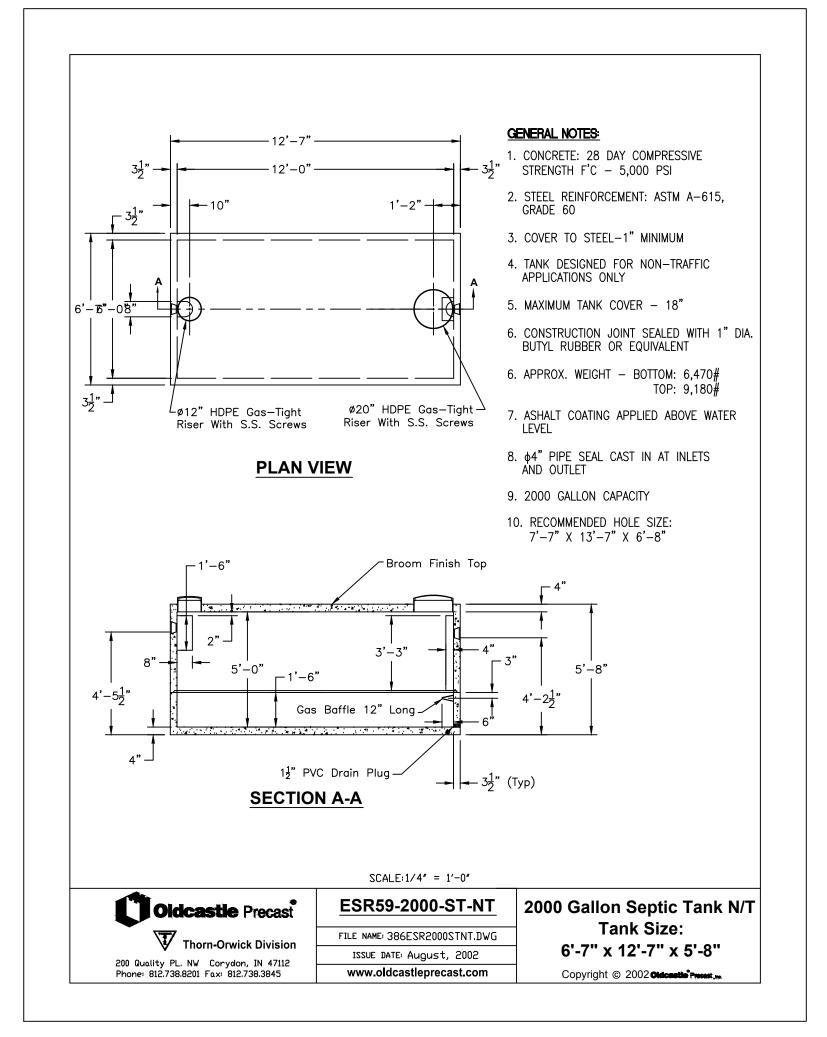
tel: 305.461.4001

CONSULTANTS:


P-4

DESIGN CRITERIA FOR	WASTE WATER DISPOSAL
BUILDING TYPE: RESIDENCE	
UNIT 1 (1 BDR, 577 SQF) = 100 GPD	TABLE I F.A.C. ESTIMATED SEWAGE FLOWS
UNIT 2 (2 BDR, 836 SQF) = 200 GPD	TABLE I F.A.C. ESTIMATED SEWAGE FLOWS
UNIT 3 (2 BDR, 836 SQF) = 200 GPD	TABLE I F.A.C. ESTIMATED SEWAGE FLOWS
UNIT 4 (1 BDR, 577 SQF) = 100 GPD	TABLE I F.A.C. ESTIMATED SEWAGE FLOWS
TOTAL ESTIMATED SEWAGE FLOW: 600 GPD	
MINIMUM SEPTIC TANK REQUIRED: 1750 GAL. / PROPOSED TANK 2,000 GAL.	TABLE II F.A.C.
TRENCH DRAIN FIELD: 0.8 GAL/SF/DAY	MINIMUM 1000 SF TRENCH DRAIN TABLE III F.A.C.

NOTE: SUB-SURFACE CONDITIONS WAS BASED ON THE "REPORT OF SURFACE SOIL EXPLORATION GEOTHECHNICAL EVALUATION AND RECOMMENDATIONS" TO CITY OF MIAMI LIFE QUEST 149502 NE11 AVENUE MIAMI, FLORIDA, DATED NOVEMBER 2013 BY NELCO TESTING AND ENGINEERING SERVICES, INC.



1 2000 GAL. SEPTIC TANK DETAIL

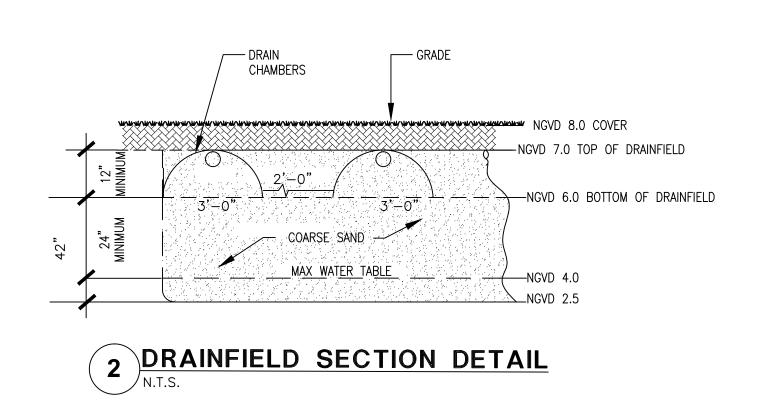

	PLUM	BING LEGEND	PLUMBING GENERAL NOTES			
	—— SAN	SANITARY DRAIN	1. UNLESS OTHERWISE SPECIFIED ON THIS DRAWING CONTRACTOR SHALL REFER TO			
—— SD	SD	STORM DRAIN	ORIGINAL LANDLORD SPECIFICATIONS FOR ALL APPLICABLE REQUIREMENTS, NOTES, DETAILS,			
CD	CD	CONDENSATE DRAIN LINE	CONSTRUCTION'S STANDARDS, ETC., COORDINATE WITH LANDLORD REQUIREMENTS PRIOR TO ORDERING AND/OR INSTALLATION OF ANY EQUIPMENT AND ACCESSORIES SHOWN.			
	cw	COLD WATER LINE				
-	BV	FULL PORT-BONZE/BRASS TEFLON SEATED BALL VALVE	2. THE CONTRACTOR SHALL FURNISH ALL LABOR, MATERIAL AND EQUIPMENT NECESSARY FOR THE INSTALLATION OF A COMPLETE SEPTIC TANK AND DRAIN FIELD SYSTEM IN ACCORDANCE WITH THIS DRAWING, THE APPLICABLE EDITION OF CHAPTER 64E-6,			
	, VIV	VALVE IN RISER	FLORIDA ADMINISTRATIVE CODE, STANDARDS FOR ON SITE SEWAGE TREATMENT AND DISPOSAL SYSTEMS.			
- *	НВ	HOSE BIBB W/ VACUUM BREAKER				
\otimes	СО	TWO WAY CO	3. THE CONTRACTOR SHALL PAY ALL COST OF PERMIT, INSPECTIONS AND OTHER COSTS INCIDENTAL TO THE COMPLETION AND TESTING OF THIS WORK. UPON FINAL INSPECTION,			
	FCO CTG	FLOOR CLEAN OUT CLEAN OUT TO GRADE	A CERTIFICATE FROM THE LOCAL STATE INSPECTION AUTHORITY SHALL BE FURNISHED TO THE OWNER.			
•	ug CNTE	UNDER GROUND CONNECT TO EXISTING	4. EXISTING PIPES SERVING AREAS NOT COVERED BY THIS CONTRACT BUT IN SERVICE AT THIS TIME SHALL NOT BE INTERRUPTED EXCEPT AS A TEMPORARY INTERRUPTION COORDINATED WITH THE OWNER AND LANDLORD.			
			5. CONTRACTOR SHALL VERIFY ALL SPACE CONDITIONS AND DIMENSIONS AT JOB SITE PRIOR TO FABRICATION AND INSTALLATION OF MATERIALS, PIPING AND EQUIPMENT.			
			6. ALL MATERIALS AND EQUIPMENT SHALL BE NEW AND MUST BE FURNISHED SO AS TO PREVENT ANY DELAY IN THE PROGRESS OF THE WORK.			
			7. CONTRACTOR SHALL SUBMIT EQUIPMENT & PLUMBING FIXTURES SHOP DRAWINGS. SHOP DRAWINGS SHALL BE COORDINATED BY CONTRACTOR WITH ALL TRADES INCLUDING STRUCTURAL, LIGHTING. ARCHITECTURAL LATEST LAYOUTS, ETC. CONTRACTOR SHALL NOT PROCEED TO ORDER AND/OR INSTALL EQUIPMENT AND ACCESSORIES UNLESS SHOP DRAWING REVIEW PROCESS HAS BEEN COMPLETED AND REVIEWED BY THE ENGINEER OF RECORD (EoR) AND APPROVED BY THE OWNER REPRESENTATIVES. THE DRAWINGS ARE NOT TO BE SCALED. UNLESS SPECIFIC DIMENSIONS ARE SHOWN, THE ARCHITECTURAL AND/OR STRUCTURAL DRAWINGS, AND SITE CONDITIONS SHALL GOVERN EXACT LOCATION OF PLUMBING EQUIPMENT AND APPURTENANCES. MANUFACTURERS USED AS THE BASIS OF DESIGN ARE LISTED ON THE DRAWING'S SCHEDULES, ANY OTHERS MUST MEET OR EXCEED ALL SPECIFIED REQUIREMENTS. ANY SUBSTITUTIONS (WHERE ALLOWED BY "OR EQUAL" ON THESE DOCUMENTS) MUST BE ACCOMPANY BY A DETAIL COST AND EQUALITY COMPARISON OF ALL ITEMS INCLUDING ANY COST DIFFERENCES AND MUST BE SUBMITTED FOR EOR REVIEW TEN (10) WORKING DAYS PRIOR TO BIDS. IF "OR EQUAL" IS NOT LISTED AFTER THE MANUFACTURER'S NAME ON THESE DOCUMENTS, THE LISTED MANUFACTURER SHALL BE SUBMITTED, NO EXCEPTIONS ARE ALLOWED. NAMING ACCEPTABLE MANUFACTURERS DOES NOT RELIEVES THE CONTRACTOR FROM COMPLIANCE WITH ALL DESIGN REQUIREMENTS SHOWN ON THESE DRAWINGS OR LISTED HEREIN. EOR IS SOLEMNLY RESPONSIBLE TO MAKE FINAL EQUALITY RECOMMENDATION TO THE OWNER.			
			8. PLUMBING CONTRACTOR SHALL GUARANTEE ALL WORK FREE OF DEFECTS IN MATERIALS AND WORKMANSHIP FOR A PERIOD OF ONE YEAR FROM DATE OF ACCEPTANCE.			
			9. COORDINATE SCHEDULING OF ALL REQUIRED INSPECTIONS WITH APPROPRIATE			

FLORIDA ADMINISTRATIVE CODE 64E-6.011 ABANDONMENT OF SYSTEMS.

REGULATORY BODIES.

(1) WHENEVER THE USE OF AN ONSITE SEWAGE TREATMENT AND DISPOSAL SYSTEM IS DISCONTINUED FOLLOWING CONNECTION TO A SANITARY SEWER, FOLLOWING CONDEMNATION OR DEMOLITION OR REMOVAL OR DESTRUCTION, OF A BUILDING OR PROPERTY, OR DISCONTINUING THE USE OF A SEPTIC TANK AND REPLACEMENT WITH ANOTHER SEPTIC TANK, THE SYSTEM SHALL BE ABANDONED WITHIN 90 DAYS AND ANY FURTHER USE OF THE SYSTEM FOR ANY PURPOSE SHALL BE PROHIBITED. HOWEVER, IF THE DEPARTMENT OF ENVIRONMENTAL PROTECTION OR ITS DESIGNEE APPROVES THE USE OF THE RETENTION TANK WHERE THE TANK IS TO BECOME AN INTEGRAL PART OF A SANITARY SEWER SYSTEM OR STORMWATER MANAGEMENT SYSTEM, THE SEPTIC TANK NEED NOT BE ABANDONED.

(2) THE FOLLOWING ACTIONS SHALL BE TAKEN, IN THE ORDER LISTED, TO ABANDON AN ONSITE SEWAGE TREATMENT AND DISPOSAL SYSTEM: (A) PROPERTY OWNER OR AGENT SHALL APPLY FOR A PERMIT FROM THE DEPARTMENT TO ABANDON THE EXISTING ONSITE SEWAGE SYSTEM AND SUBMIT THE REQUIRED FEE. UPON RECEIVING A PERMIT:

(B) THE TANK SHALL BE PUMPED OUT. (C) THE BOTTOM OF THE TANK SHALL BE OPENED OR RUPTURED, OR THE ENTIRE TANK COLLAPSED SO AS TO PREVENT THE TANK FROM RETAINING WATER,

(D) THE TANK SHALL BE FILLED WITH CLEAN SAND OR OTHER SUITABLE MATERIAL, AND COMPLETELY COVERED WITH SOIL. (E) AN INSPECTION OF THE SYSTEM ABANDONMENT SHALL BE CONDUCTED BY THE DEPARTMENT OR BY THE LOCAL UTILITY OR PLUMBING AUTHORITY

PERFORMING THE SYSTEM ABANDONMENT. (3) THE PERMITTING PROVISIONS OF PARAGRAPH 64E-6.011(2)(A), F.A.C., ARE NOT REQUIRED IF A LOCAL UTILITY OR LOCAL PLUMBING AUTHORITY PERFORMS A SYSTEM ABANDONMENT PROGRAM WHICH REQUIRES THE COMPLETION OF THOSE STEPS LISTED IN PARAGRAPHS 64E-6.011(2)(B), (C), (D), AND (E), F.A.C. IF THE SYSTEM ABANDONMENT IS PERFORMED BY A LOCAL UTILITY OR LOCAL PLUMBING AUTHORITY, THE LOCAL UTILITY OR LOCAL PLUMBING AUTHORITY PERFORMING THE ABANDONMENT PROGRAM SHALL MAINTAIN A LOG OF ALL INSPECTIONS PERFORMED AND SHALL FORWARD THE LOG TO THE COUNTY HEALTH

DEPARTMENT ON A MONTHLY BASIS. (4) A SEPTIC TANK SERVING A SINGLE FAMILY RESIDENCE MAY, AT THE OWNER'S DISCRETION, BE CONVERTED INTO A CISTERN PURSUANT TO THE FOLLOWING PROCEDURES:

(A) THE APPLICANT SHALL OBTAIN A SYSTEM ABANDONMENT PERMIT FROM THE COUNTY HEALTH DEPARTMENT. (B) THE PERMIT APPLICATION SHALL SPECIFY THE INTENDED USE OF THE

ABANDONED SEPTIC TANK. (C) THE ACTIVITIES RELATED TO ABANDONING THE ONSITE SEWAGE TREATMENT AND DISPOSAL SYSTEM SHALL NOT CREATE A SANITARY NUISANCE. (D) THE SEPTIC TANK SHALL BE DISCONNECTED FROM THE DRAINFIELD AND FROM THE BUILDING SEWER PIPE.

(E) ALL WORK TO DISCONNECT, CLEAN AND SANITIZE THE SEPTIC TANK SHALL BE CONDUCTED BY A REGISTERED SEPTIC TANK CONTRACTOR OR A STATE-LICENSED PLUMBER OR BY THE OWNER OF THE OWNER-OCCUPIED SINGLE

FAMILY RESIDENCE BEING SERVED BY THE SEPTIC TANK. (F) ALL SEPTAGE, WASH WATER, AND OTHER LIQUIDS REMOVED FROM THE TANK SHALL BE REMOVED AND HANDLED AS SEPTAGE (RULE 64E-6.010,

10. DRAINAGE SYSTEM DESIGN TO THE SPECTIC TANK INLET IS BASED ON 1/8" PER FOOT MINIMUM FALL FOR PIPES 3" OR LARGER AND 1/4" PER FOOT MINIMUM FALL FOR PIPES 2" OR SMALLER, ANY DEVIATIONS SHALL BE APPROVED BY ARCHITECT/ENGINEER.

> AT A DEP-REGULATED WASTEWATER TREATMENT FACILITY. (G) THE HEALTH DEPARTMENT SHALL INSPECT THE TANK ONCE IT IS DISCONNECTED, EMPTIED, CLEANED, DISINFECTED AND FILLED WITH WATER. THE INSPECTION SHALL DETERMINE WHETHER ALL OF THE FOLLOWING CONDITIONS HAVE BEEN MET: 1. THE TANK HAS BEEN DISCONNECTED FROM THE DRAINFIELD AND THE

F.A.C.) BY A DOH-LICENSED SEPTAGE DISPOSAL SERVICE AND DISPOSED OF

BUILDING SEWER. 2. THE TANK IS FULL OF WATER WITHIN 12 INCHES OF THE TOP OF THE 3. THE CLARITY OF THE WATER IS SUCH THAT A SECCHI DISK IS VISIBLE AT THE BOTTOM OF THE TANK.

4. THE PH OF THE WATER IN THE TANK IS BETWEEN 6.0 AND 8.0. 5. THE FREE CHLORINE RESIDUAL OF THE WATER IN THE TANK IS \leq 1.0

6. THE TOTAL COLIFORM COUNT IS ≤ 1000 PER 100 ML.

7. THE FECAL COLIFORM COUNT IS \leq 200 PER 100 ML. 8. NO SANITARY NUISANCE CONDITION EXISTS ON THE PROPERTY RELATED TO THE ABANDONMENT ACTIVITIES. (H) ONE INSPECTION IS INCLUDED IN THE ABANDONMENT PERMIT FEE. THE APPLICANT SHALL PAY A REINSPECTION FEE FOR ANY ADDITIONAL INSPECTION

VISITS NECESSARY UNTIL ALL OF THE CRITERIA IN SUBPARAGRAPHS 64E-6.011(4)(G)1. THROUGH 8. F.A.C., ARE MET AND FINAL APPROVAL OF THE ABANDONMENT IS GRANTED BY THE COUNTY HEALTH DEPARTMENT. (I) THE APPLICANT SHALL BE RESPONSIBLE FOR ALL REQUIRED LABORATORY FEES. ALL SAMPLING SHALL BE CONDUCTED BY COUNTY HEALTH DEPARTMENT STAFF DURING THE FINAL INSPECTION. (J) THE SEPTIC TANK SHALL BE CONVERTED AND INSPECTED WITHIN 90

DAYS AFTER CONNECTION OF THE BUILDING PLUMBING TO THE SANITARY (K) THE TANK SHALL NOT BE CONNECTED TO ANY IRRIGATION COMPONENTS NOR SHALL THE WATER USED FOR IRRIGATION PURPOSES UNTIL FINAL APPROVAL OF THE ABANDONMENT HAS BEEN GRANTED BY THE COUNTY HEALTH DEPARTMENT.

(L) UPON FINAL APPROVAL OF THE ABANDONMENT, USE OF THE TANK OR THE DRAINFIELD FOR SEWAGE STORAGE, TREATMENT OR DISPOSAL IS PROHIBITED AND CONSTITUTES A NUISANCE INJURIOUS TO HEALTH AS DEFINED BY SECTION 386.041, F.S. (M) UPON FINAL APPROVAL OF THE ABANDONMENT, THE WATER COLLECTED

FORMERLY 10D-6.053, AMENDED 6-18-03, 6-25-09.

IN THE TANK SHALL BE UTILIZED FOR NON-POTABLE, IRRIGATION PURPOSES RULEMAKING AUTHORITY 381.0065, 489.553, 489.557 FS. LAW IMPLEMENTED 381.0065, 381.00655, 381.0066, PART I 386 FS. HISTORY-NEW 12-22-82, AMENDED 2-5-85, FORMERLY 10D-6.53, AMENDED 3-17-92, 1-3-95,

PLUMBING SPECIFICATION

. GENERAL:

MATERIAL SHALL BE NEW, UNUSED, BEST OF THEIR RESPECTIVE KINDS AND FREE FROM DEFECTS IN WORKMANSHIP; IN CONFORMANCE WITH THE LATEST PUBLICATIONS IN FORCE AT TIME OF BIDDING.

2. PIPE AND FITTINGS: (TO SEPTIC TANK INLET)


A. SANITARY SOIL/DRAINAGE BELOW GROUND: SCHEDULE 40 SOLID PLASTIC PVC PIPE ASTM D1785.

B. DISPOSAL SYSTEM PIPING AS FOLLOWS: DRAINFIELD: PE PLASTIC PERFORATED FIELD TUBING 4" DIAMETER. SANITARY PIPING &

CONNECTIONS: SEE PLUMB. SPECS


3. JOINTS AND METHODS OF CONNECTION:

A. SCHEDULE 40 PVC MOLDED PERFORMED FITTINGS, PVC-DWV, SOCKET SOLVENT CEMENT, ASTM D-2467

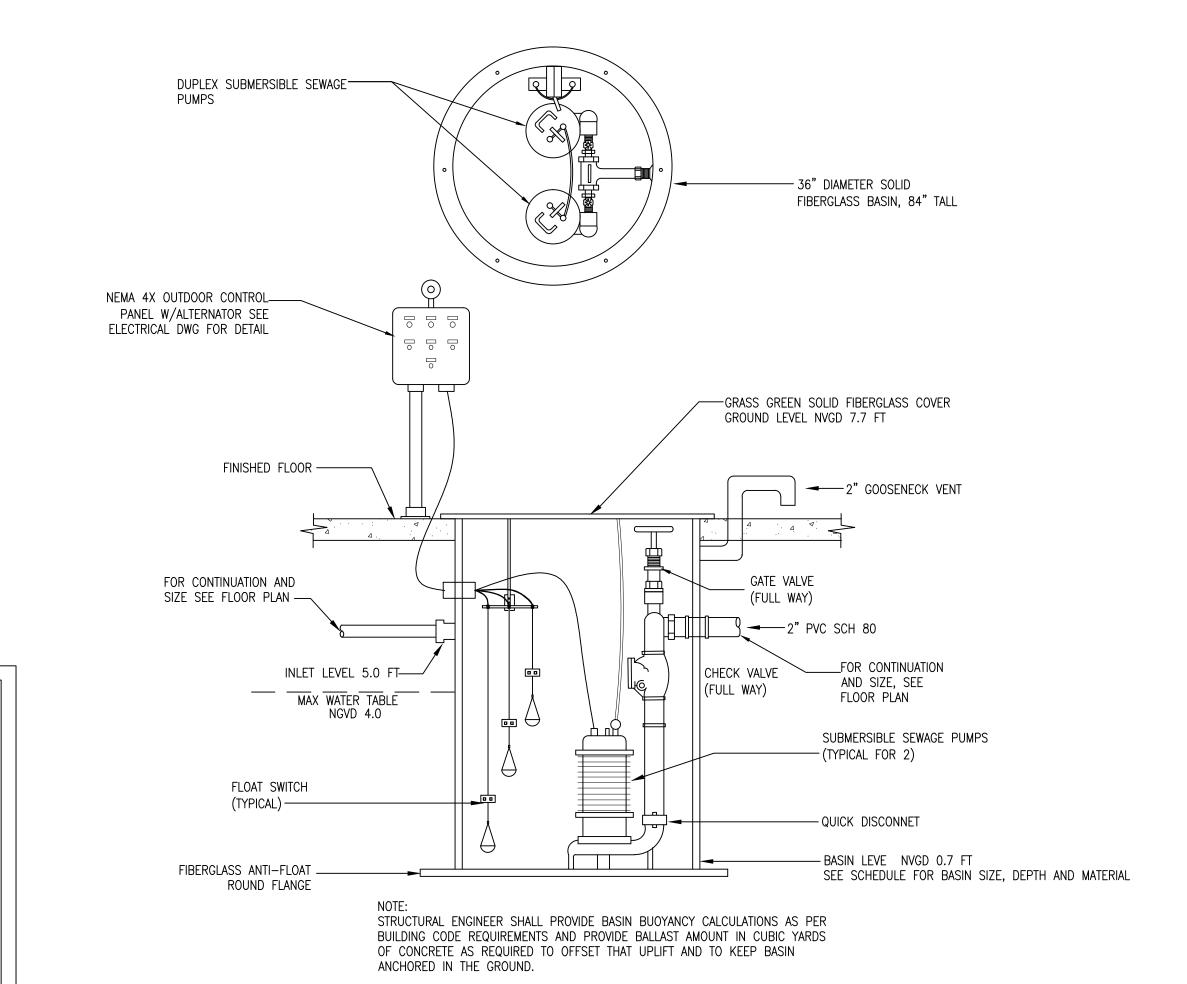

DUPLEX SEWAGE PUMPS - PACKAGE DETAIL

	SEWAGE PUMP SYSTEM SCHEDULE						
PLAN MARK	MFG. NAME	MODEL	PUMP HEAD (FT)	PUMP CAPACITY (G.P.M.)	H.P.	VOLT PHASE	
SP-1	BELL & GOSSET	DUPLEX GRINDER PUMP PACKAGE DPGSN4 WITH A BASIN KIT. 2)PUMPS MODEL 12GS2012 (1) DUPLEX OUTDOOR CONTROL PANEL D10020 (3) MECHANICAL LEVEL SWITCH A2D23W. 4K639 CAST IRON PUMP LEG. (1) BASIN D4UGR84, 36" DIAMETER 84" TALL FIBERGLASS	20	30 GPM/PUMP ALTERNATE OPERATION NOT SIMULTANEOUS OPERATION	2	208/1/60	

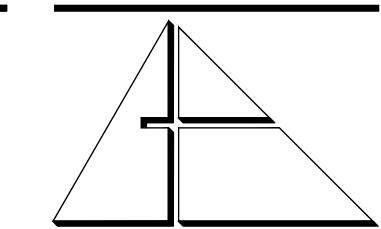

ALLEGUEZ ARCHITECTURE, INC.

ARCHITECTURE PLANNING **DESIGN** INTERIOR CONSTRUCTION MANAGEMENT

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CITY OF MIAMI LIFE QUEST RENOVATIONS 1075 NE 149 ST

MIAMI, FL

DRAWING TITLE:

SEPTIC TANK DEMO NOTES AND DETAILS

ROBERT BETANCOURT P.E. (MECHANICAL) LICENSE NO. 34788 "In my professional judgement and to the best of my knowledge and belief, these plans and specifications comply with applicable Building Codes." DATE:

February 05, 2015 05-19-15 DOH. COMMENTS

CAD DRAWING NAME:

