

CITY OF MIAMI - LIFE QUEST RENOVATIONS FOR 1301 N.E. 111th STREET

City of Miami Department of Community Development

BID SET - January 9th 2017

Miami-Dade County - Alteration Level 2

Owner's Representative: Dollila Pinkhasov Contract Compliance Analyst City of Miami

<u>Mayor</u> Tomas P. Regalado

Chairman Leon Hardemon

Vice-Chairman


Ken Russell


Commissioner


Frank Carollo Commissioner

Marc Sarnoff Commissioner

Francis Suarez City Manager

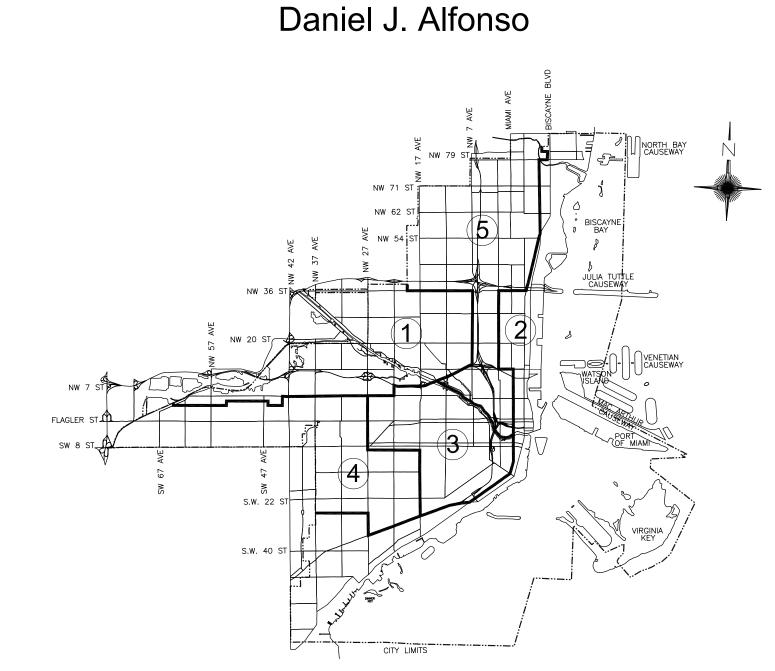

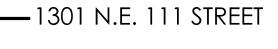

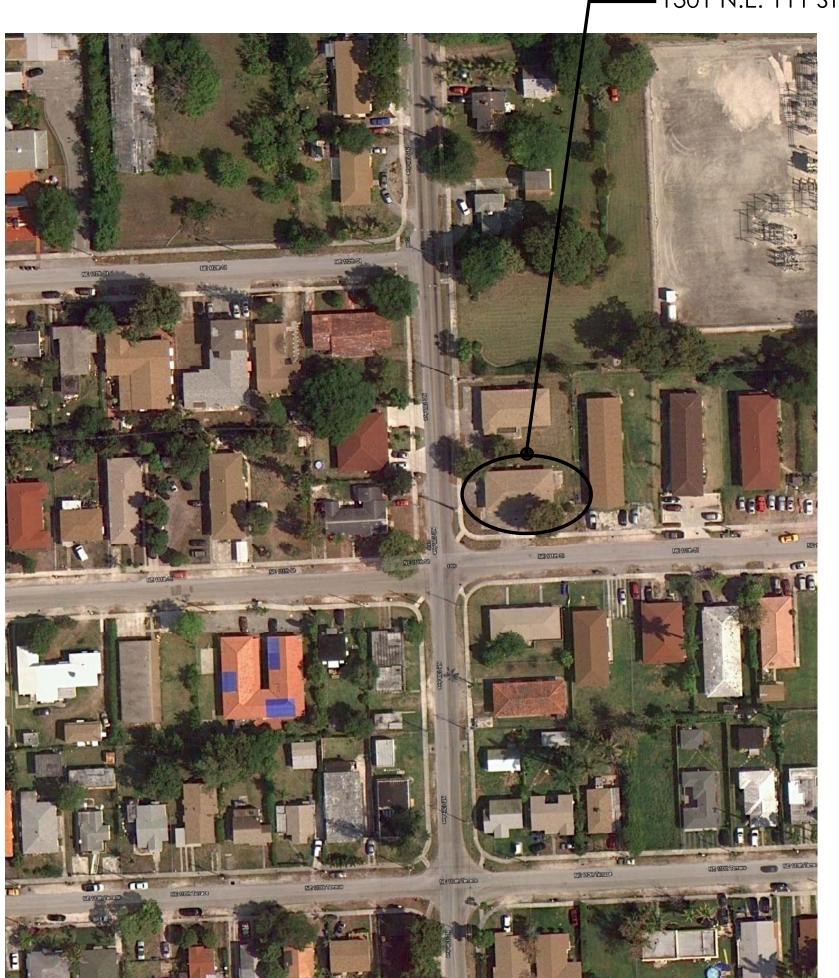

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N.T.S.

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ARCHITECT:

ALLEGUEZ ARCHITECTURE, INC. 901 PONCE DE LEON BOULEVARD, SUITE 202


CORAL GABLES, FLORIDA 33134 TEL: (305) 461-4001 FAX: (305) 461-6002 WWW.ALLEGUEZARCHITECTURE.COM




MECHANICAL, ELECTRICAL, PLUMBING ENGINEER:

GARTEK ENGINEERING CORP.

7210 SOUTHWEST 39TH TERRACE MIAMI, FLORIDA 33155 TEL: (305) 266-8997 FAX: (305) 264-9496 WWW.GARTEK-ENGINEERING.COM

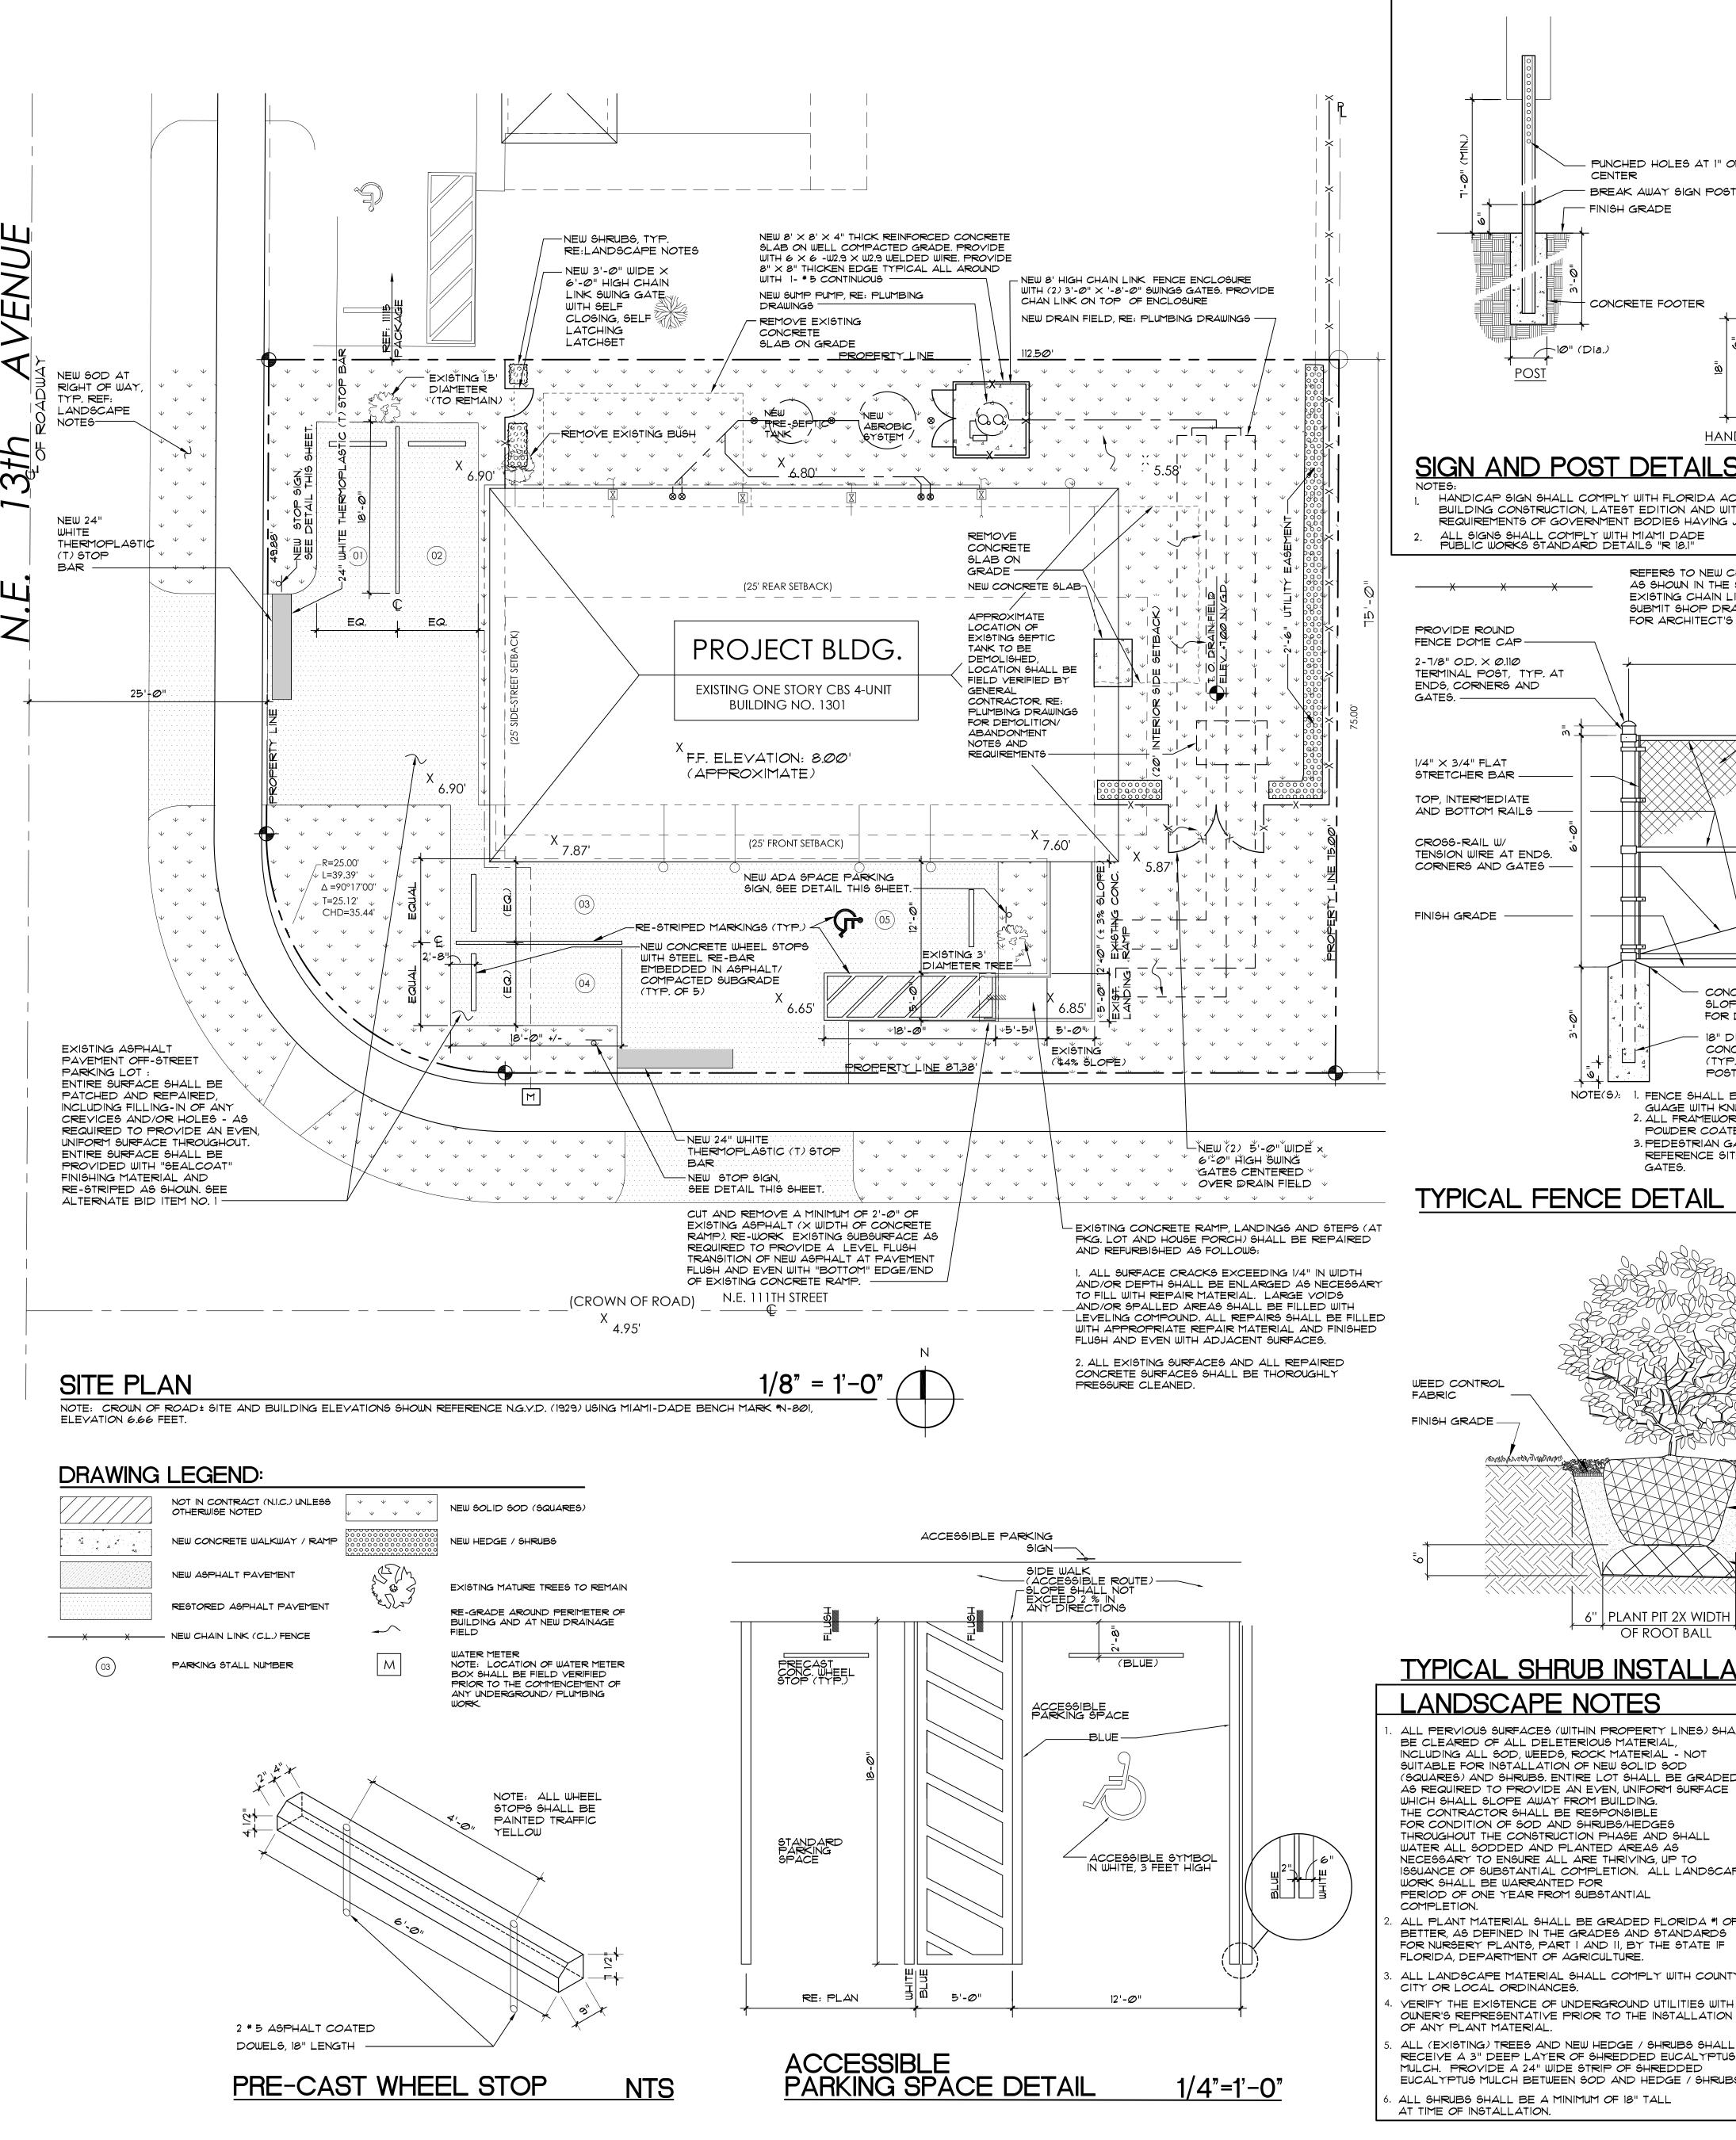

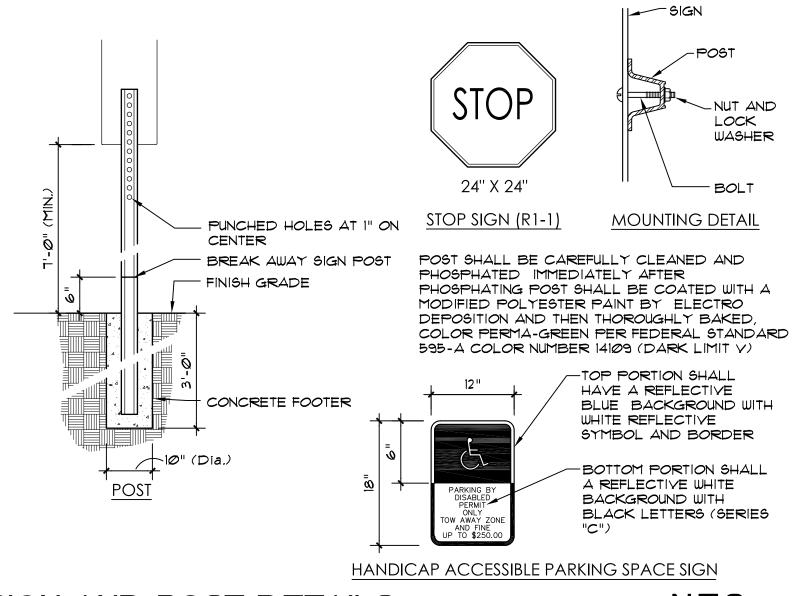

REFERS TO NEW CHAIN LINK (C/L) FENCE AS DETAILED BELOW AND


3. PEDESTRIAN GATES SHALL HAVE (BLACK) FORK LATCHES.

REFERENCE SITE PLAN FOR OF LOCATION OF PEDESTRIAN

SIGN AND POST DETAILS

HANDICAP SIGN SHALL COMPLY WITH FLORIDA ACCESSIBILITY CODE FOR BUILDING CONSTRUCTION, LATEST EDITION AND WITH THE LATEST REQUIREMENTS OF GOVERNMENT BODIES HAVING JURISDICTION. ALL SIGNS SHALL COMPLY WITH MIAMI DADE PUBLIC WORKS STANDARD DETAILS "R 18.1"

AS SHOWN IN THE SITE PLAN.

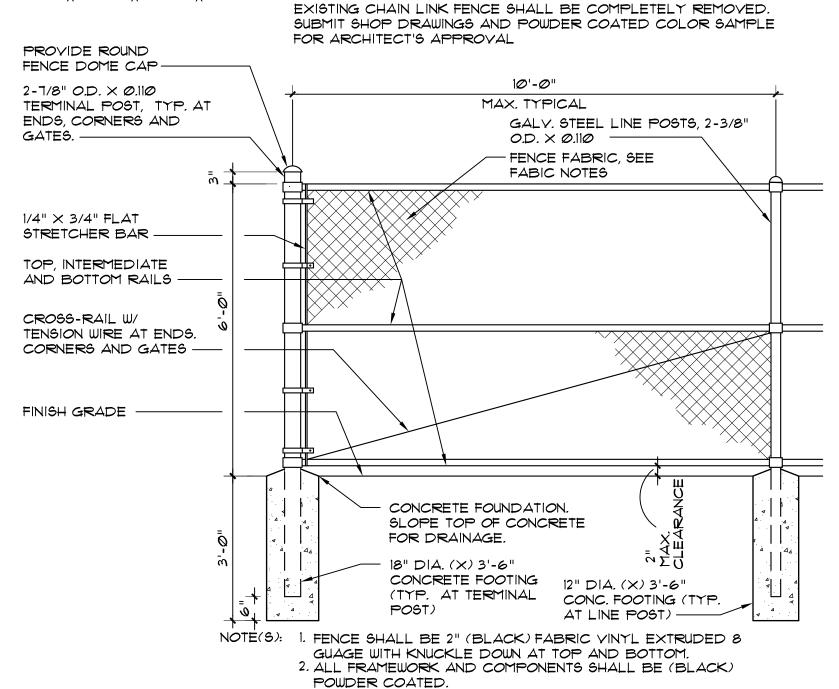

TYPICAL FENCE DETAIL

PLANT MATERIAL SHALL NOT BE PRUNED PRIOR TO INSTALLATION ± AFTER PLANTS HAVE BEEN INSTALLED, EACH PLANT SHALL BE PRUNED FOR UNIFORMITY MIN. 3" DEEP LAYER OF MULCH TO COVER ENTIRE PLANT BED. WET DOWN TO STABILIZE - DO NOT MULCH TO TRUNK. WEED CONTROL FABRIC FINISH GRADE -PREPARED PLANTING SOIL, COMPACTED FULLY PLANTING DOME SLOPE SHALL DRAIN AWAY FROM ROOT BALL 6" | PLANT PIT 2X WIDTH |

TYPICAL SHRUB INSTALLATION

OF ROOT BALL

LANDSCAPE NOTES

ALL PERVIOUS SURFACES (WITHIN PROPERTY LINES) SHALL 7. NEW HEDGE: BE CLEARED OF ALL DELETERIOUS MATERIAL, INCLUDING ALL SOD, WEEDS, ROCK MATERIAL - NOT SUITABLE FOR INSTALLATION OF NEW SOLID SOD (SQUARES) AND SHRUBS, ENTIRE LOT SHALL BE GRADED AS REQUIRED TO PROVIDE AN EVEN, UNIFORM SURFACE WHICH SHALL SLOPE AWAY FROM BUILDING. FOR CONDITION OF SOD AND SHRUBS/HEDGES THROUGHOUT THE CONSTRUCTION PHASE AND SHALL WATER ALL SODDED AND PLANTED AREAS AS NECESSARY TO ENSURE ALL ARE THRIVING, UP TO ISSUANCE OF SUBSTANTIAL COMPLETION. ALL LANDSCAPE WORK SHALL BE WARRANTED FOR

- COMPLETION. ALL PLANT MATERIAL SHALL BE GRADED FLORIDA #1 OF BETTER, AS DEFINED IN THE GRADES AND STANDARDS FOR NURSERY PLANTS, PART I AND II, BY THE STATE IF FLORIDA, DEPARTMENT OF AGRICULTURE.
- ALL LANDSCAPE MATERIAL SHALL COMPLY WITH COUNTY CITY OR LOCAL ORDINANCES. VERIFY THE EXISTENCE OF UNDERGROUND UTILITIES WITH
- OF ANY PLANT MATERIAL. ALL (EXISTING) TREES AND NEW HEDGE / SHRUBS SHALL RECEIVE A 3" DEEP LAYER OF SHREDDED EUCALYPTUS MULCH. PROVIDE A 24" WIDE STRIP OF SHREDDED EUCALYPTUS MULCH BETWEEN SOD AND HEDGE / SHRUBS. ALL SHRUBS SHALL BE A MINIMUM OF 18" TALL
- PROVIDE COCOPLUM HEDGE, 3 GALLON (24 (x) 24") AT 2' ON CENTER, AS SHOWN. REFER TO LANDSCAPE NOTES AND INSTALLATION DETAIL THIS SHEET. NEW PLANTING:
- LINES) SHALL BE CLEARED OF ALL DELETERIOUS MATERIAL, INCLUDING ALL SOD, WEEDS, ROCK AND MATERIAL(S) - NOT SUITABLE FOR INSTALLATION OF NEW SOLID SOD (SQUARES. AND SHRUBS. ENTIRE LOT SHALL BE GRADED AS REQUIRED TO PROVIDE AN EVEN, UNIFORM SURFACE WHICH SHALL SLOPE AWAY FROM BUILDING. ENTIRE LOT / PROPERTY SHALL BE PROVIDED WITH NEW ST. AUGUSTINE SOLID SOD AS PER LANDSCAPE NOTES THIS SHEET.

ALL PERVIOUS SURFACES (WITHIN PROPERTY

PROVIDE 3" (DEEP) TOPSOIL MIX FOR ALL SODDED AREAS CONSISTING OF 80% SAND AND 20% MUCK THOROUGHLY MIXED BY A COMMERCIAL SHREDDER. MIXTURE SHALL BE FREE OF ROCKS, ROOTS BRANCHES AND OTHER SIMILAR MATTER. ALL SITE AREAS NOT COVERED BY BUILDING PAVING, SIDEWALKS, AND HEDGES / SHRUBS ARE TO BE SODDED. 10. SOLID SOD SHALL BE ST. AUGUSTINE

FLORATAM.

SCOPE OF WORK

SCOPE OF WORK CONSISTS OF THE COMPLETE DEMOLITION AND REMOVAL OF ALL EXISTING INTERIOR COMPONENTS AND SELECTED EXTERIOR COMPONENTS INCLUDING, BUT NOT LIMITED TO, ALL INTERIOR FRAME PARTITIONS, FURRING, ALL GYPSUM WALLBOARD CLADDING THROUGHOUT ALL INTERIOR SPACES - WALL AND CEILINGS, ALL TRIM, ALL CABINETWORK, ALL DOORS AND FRAMES (INTERIOR AND EXTERIOR) AND ALL WINDOWS.

EXTERIOR DEMOLITION AND REMOVAL INCLUDES, BUT IS NOT LIMITED TO, SHINGLE ROOF SYSTEM, INCLUDING TRIM, AND ALL FRAMING. SELECTED SITE DEMOLITION TASKS ARE IDENTIFIED IN THE DRAWINGS. ADDITIONALLY ALL PLUMBING FIXTURES, INCLUDING ALL ACCESSORIES AND TRIM, SHALL BE COMPLETELY REMOVED.

NEW CONSTRUCTION CONSISTS OF MIAMI-DADE COUNTY ALTERATION LEVEL 2 WORK AND INCLUDES, BUT IS NOT LIMITED TO, NEW SHINGLE ROOF SYSTEM, NEW IMPACT RESISTANT WINDOWS AND DOORS, NEW RAILING, NEW GYPSUM WALLBOARD FRAME PARTITIONS AND GYPSUM WALLBOARD OVER FRAMING AT CEILINGS AND EXTERIOR MASONRY WALLS. NEW INTERIOR WORK ALSO INCLUDES ALL NEW CABINETWORK, DOORS AND FRAMES, TRIM AND ALL FINISHES, NEW SITE WORK INCLUDES CLEARING OF EXISTING PERVIOUS/SODDED AREAS, PRIVACY HEDGES AT PERIMETER AND NEW CHAIN-LINK FENCE WITH PEDESTRIAN GATES.

COMPLETE (DEMOLITION AND NEW WORK) MECHANICAL, ELECTRICAL AND PLUMBING (MEP) SCOPE IS IDENTIFIED IN TH CONSTRUCTION DOCUMENTS FOR THOSE DISCIPLINES.

GENERAL NOTES

- GENERAL NOTES ON THE PROJECT PLANS AND DRAWINGS ARE SOLELY TO AID AND ASSIST THE CONTRACTOR WITH THE FIELD OPERATIONS FOR THE PROJECT. SAID GENERAL NOTES MAY NOT FULLY DESCRIBE ALL OF THE REQUIREMENTS FOR AN ITEM. THEREFORE, THE CONTRACTOR SHALL READ AND VERIFY THE CONTRACT DOCUMENTS, INCLUDING BUT NOT LIMITED TO THE PLANS, SPECIFICATIONS, GENERAL TERMS AND CONDITIONS, AND THE SUPPLEMENTAL TERMS AND CONDITIONS, TO FULLY UNDERSTAND AND COMPLY WITH ALL THE REQUIREMENTS THEREIN.
- THE CONTRACTOR IS RESPONSIBLE FOR REMOVING ALL UTILITY MARKINGS ONCE THE WORK IS COMPLETED. CONTRACTOR SHALL USE SPECIAL CARE WHEN REMOVING THE UTILITY MARKINGS. THE REMOVAL METHOD NEEDS TO BE SUCH THAT IT DOES NOT DAMAGE THE SURFACES OF THE EXISTING WORK ALREADY IN PLACE . IF WATER-BLASTING OLDER ASPHALT PAVEMENT, CARE NEEDS TO BETAKEN TO NOT DISCOLOR THE ASPHALT OR PLISH THE AGGREGATE. IF THE REMOVALS ARE ON OLDER E-MAIL alleguez@bellsouth.net CONCRETE SURFACES, THE ENTIRE SURFACEOF A PANEL OR SECTION NEEDS TO BE BLASTED TOSHOW UNIFORM COLOR ■AA C 0 0 2 7 4 6 ■ THROUGHOUT THAT SAME PANEL OR SECTION. IN ANY CASE (ASPHALT OR CONCRETE SURFACE), THE METHOD NEEDS TO BE SUCH THAT A SLICK SURFACE IS NOT LEFT BEHIND. FINAL PAYMENT TO THE CONTRACOTR MAY BE WITHHELD UNITL THE UTILITY MARKS ARE PROPERLY REMOVED.

. THE GENERAL NOTES AND CONSTRUCTION DOCUMENTS HEREWITH SHALL APPLY TO THE WORK OF THIS PROJECT, AND SHALL BE CAREFULLY REVIEWED BY THE CONTRACTOR AND ALL HIS SUBCONTRACTORS. THE CONTRACTOR SHALL COORDINATE EACH OF THE SUBCONTRACTORS' WORK WITH OTHER SUBCONTRACTORS' WORK ASSOCIATED WITH THIS PROJECT. 4. THE CONTRACTOR AND ALL SUBCONSTRACTORS SHALL VERIFY ALL EXISTING CONDITIONS & DIMENSIONS AT THE JOBSITE THE CONTRACTOR SHALL COORDINATE ACTUAL FIELD CONDITIONS WITH THE WORK SPECIFIED IN THE CONSTRUCTION DOCUMENTS PRIOR TO BIDDING AND ANY CONSTRUCTION. AND SHALL NOTIFY THE ARCHITECT IMMEDIATELY IF ANY DISCREPANCIES ARE ENCOUNTERED. BY SUBMISSION OF A BID FOR CONSTRUCTION, THE CONTRACTOR AND HIS SUBCONTRACTORS ACKNOWLEDGE PERFORMING THE ABOVE INSPECTION, AND INCLUDE IN IT'S PROPOSAL ALL COSTS AND/OR FEES PERTAINING TO THE COMPLETION OF THE PROJECT AS INTENDED IN THE BIDDING CONSTRUCTION DOCUMENT SET AND ANY ADDENDA. THESE COSTS MIGHT INCLUDE, BUT ARE NOT LIMITED TO, THE REMOVAL, RELOCATION, AND/OR

- REPAIR OF ANY EXISTING OBJECTS OR OBSTRUCTIONS WHICH MAY BE ENCOUNTERED IN PERFORMING THE WORK. ALL WORK SHALL COMPLY WITH THE LATEST EDITION OF ALL NATIONAL, STATE AND LOCAL CODES HAVING JURISDICTION, THE FLORIDA BUILDING CODE, AND WITH THE REQUIREMENTS OF THE UTILITY COMPANIES WHOSE SERVICES SHALL BE UTILIZED. ALL MODIFICATIONS REQUIRED BY ANY OF THESE ENTITIES SHALL BE IMMEDIATELY BROUGHT TO THE ATTENTION OF THE ARCHITECT. RESULTING CHANGES, MAY BE SHOWN, AS DETERMINED BY THE ARCHITECT, ON REVISED DRAWINGS ISSUED TO THE CONTRACTOR. ANY ADJUSTMENTS TO CONSTRUCTION FEES SHALL TAKE PLACE AT THIS TIME, AND SUBMITTED FOR CONSIDERATION AND APPROVAL OF THE ARCHITECT AND OWNER.
- TESTS, INSPECTIONS, AND APPROVALS REQUIRED FOR IT'S PORTION OF THE WORK. 1. THE CONTRACTOR AND EACH SUBCONTRACTOR SHALL BE RESPONSIBLE FOR NOTIFYING THE ARCHITECT OF ALL MANDATORY BUILDING INSPECTIONS REQUIRED BY THE BUILDING DEPARTMENT TO BE MADE BY THE ARCHITECT OR ANY OF HIS ENGINEERS UPON ISSUANCE OF THE PERMIT. THE CONTRACTOR MUST CONTACT THE ARCHITECT OR ENGINEER PRIOR TO

6. THE CONTRACTOR AND EACH SUBCONTRACTOR SHALL MAKE ARRANGEMENTS FOR, OBTAIN, AND PAY, FOR ALL PERMITS

- SCHEDULING THE INSPECTION WITH THE BUILDING INSPECTOR SO THAT THE ENGINEER CAN CONDUCT THE SAME INSPECTION AND INITIAL THE INSPECTION LOG AS REQUIRED BY THE FLORIDA BUILDING CODE. 3. THE CONTRACTOR SHALL MAINTAIN RECORDS OF DEVIATIONS FROM THE DRAWINGS AND PREPARE AS-BUILT RECORD DRAWINGS SHOWING CORRECTLY AND ACCURATELY ALL CHANGES AND DEVIATIONS MADE DURING CONSTRUCTION TO
- REFLECT THE WORK AS IT WAS ACTUALLY CONSTRUCTED. REFER TO FRONT END SPECIFICATIONS FOR FURTHER INFORMATION AND REQUIREMENTS PERTAINING TO THE AS-BUILT DRAWINGS/ DOCUMENTATION. 9. THE CONTRACTOR SHALL PROVIDE, INSTALL, AND MAINTAIN ALL BARRICADES, BARRIERS, AND DUST CONTROL SYSTEMS
- NECESSARY TO PROTECT THE HEALTH AND SAFETY OF THE PERSONS USING OR OCCUPYING ADJACENT ROW AND/OR SITES. 10. WRITTEN DIMENSIONS AND NOTES ARE TYPICAL FOR ALL SIMILAR CONDITIONS, UNLESS OTHERWISE SPECIFIED IN THE CONSTRUCTION DOCUMENTS. DO NOT SCALE DRAWINGS. IF REQUIRED DIMENSIONS OR NOTES ARE NOT INDICATED, THE CONTRACTOR SHALL NOTIFY THE ARCHITECT FOR RESOLUTION.
- . THE CONTRACTOR AND SUBCONTRACTORS SHALL BE RESPONSIBLE FOR ANY CUTTING, FITTING, AND PATCHING THAT MAY BE REQUIRED TO PROPERLY COMPLETE THE WORK OF HIS CONTRACT. NO SUBCONTRACTOR SHALL ENDANGER THE WORK OF ANY OTHER SUBCONTRACTOR.

PROVIDE SQUARE FOOTAGE UNIT COST TO REPLACE ALL DAMAGED SECTIONS OF EXISTING ON-GRADE CONCRETE SIDEWALKS, INCLUDING, AT A MINIMUM, ANY SURFACE CRACKS EXCEEDING 1/4" IN WIDTH AND DEPTH. COST SHALL BE PROVIDED FOR ENTIRE WIDTH OF SIDEWALK, WHICH ENCOMPASSES THE DAMAGED AREA(S)

SIDEWALK SHALL MATCH EXISTING FINISH, WIDTHS AND THICKNESS (4" MINIMUM, 6" AT DRIVEWAYS). PROVIDE 6×6×10 WIRE WELDED MESH AT DRIVEWAYS. PROVIDE 1/8" × 1-1/2"(DEEP) SAWED JOINTS @5'-0" O.C. MAXIMUM AND 1/4" OPEN JOINTS WITH 1/2" RADIUS TOP EDGES AT CHANGE OF DIRECTION AREAS.

<u>STUCCO REPAIRS</u>

- PROVIDE SQUARE FOOTAGE UNIT COSTS FOR STUCCO REPAIRS AS FOLLOW: a. LOCATED EXPOSED STUCCO WALL AREAS WITH CRACKINGS, DELAMINATION FROM THE SUBSTRATE
- 6. AT DELAMINATED AREAS, REMOVE STUCCO SURFACING, CLEAN SUBSTRATE "APPLY PRIMER AND /OR BONDING COMPOUND. APPLY STUCCO RESURFACING TO MATCH EXISTING THICKNESS AND TEXTURE.
- c. AT CRACKS, CLEAN OUT LOOSE MATERIALS, PRIME INSIDE SURFACES. FOR LARGE CRACKS, FILL WITH STUCCO PATCHING LEVELING MATERIAL. FOR SMALL CRACKS, FILL CRACK WITH COMPATIBLE SEALANT AND STRIKE FLUSH WITH ADJACENT
- d. UPON COMPLETION OF REPAIRS AND ADEQUATE CURING TIME, PAINT ENTIRE WALL SURFACES PER PROJECT
- CONCRETE STAIRS, LANDINGS AND RAMP REPAIRS PROVIDE SQUARE FOOTAGE UNIT COST TO PERFORM REPAIRS AND MAINTENANCE WORK TO THE EXISTING EXPOSED CONCRETE STAIRS, RARAMPS AND LANDING AS FOLLOWS
- a. INSPECT ALL EXISTING CAST-IN PLACE CONCRETE STAIRS, RAMPS AND LANDING. SURFACES FOR DAMAGE AND/OR DETERIORATION.
- b. REMOVE ALL AREAS OF CRACKED AND/OR SPALLED CONCRETE DOWN TO SOLID SUBSTRATE
- c. CLEAN AND TREAD ANY EXPOSED REINFORCING STEEL WHICH EXHIBITS CORROSION OR DETERIORATION PER THE REPAIR COMPOUND MANUFACTURER.
- d. APPLY CONCRETE REPAIR COMPOUND TO SEAL AND RESTORE PROFILE OR SURFACE.
- BOARD AND/OR PLYWOOD ROOF SHEATHING:
- PROVIDE COSTS TO REPLACE ALL DAMAGED ROOF SHEATHING SECTIONS WITH SAME. BOARD SHEATHING COSTS SHALL BE SUBMITTED IN LINEAR FOOTAGE (L.F.), PLYWOOD SHEATHING COSTS SHALL BE SUBMITTED IN SQUARE FEET (S.F.).

CODE COMPLIANCE STATEMENTS

. HUD SECTION 504 STATEMENT: AT LEAST ONE BUILDING UNIT TYPE (I.E. :EFFICIENCY AND/ OR NUMBER OF BEDROOMS) HAVE BEEN MODIFIED AND RENOVATED TO COMPLY WITH FBCA 2010, MOBILITY SECTIONS 233.2 AND COMMUNICATION SECTION 233.3 TO THE GREATEST EXTENT POSSIBLE -IN COMPLIANCE WITH HUD SECTION 504

2. THIS PROJECT IS FUNDED THRU THE FEDERAL GOVERNMENT AND IS COVERED BY TITLE II OF THE ADA

- . CONTRACTOR SHALL PROVIDE AN ADD ALTERNATE BID PRICE FOR MILLING AND RESURFACING ONE-INCH(I")MINIMUM DEPTH FOR PARKING FIELD & DRIVE WITH A FINAL COMPACTED THICKNESS OF SP-95 (5-111)
- 2. CONTRACTOR SHALL PROVIDE AN ADD ALTERNATE BID PRICE FOR REMOVAL OF THE EXISTING STUCCO (ALL SIDES) BY SANDBLASTING DOWN TO THE CMU SUBSTRATE AND PROVIDING A NEW 2 COAT STUCCO SYSTEM (MINIMUM OVERALL THICKNESS 5/8"). ALL NEW STUCCO SURFACES SHALL BE PRIMED AND PAINTED. REMOVE GRADING AROUND PERIMETER OF BUILDING TO ALLOW FOR PROPER AND COMPLETE REMOVAL OF EXISTING STUCCO AND TO ALLOW FOR NEW STUCCO APPLICATION 12" BELOW FINISH GRADE MIN.

CODE COMPLIANCE NOTES


- PROVIDE HORIZONTAL FIRE BLOCKING IN CONCEALED SPACES/CAVITIES OF FRAME STUD PARTITIONS AND FURRED SPACES AT VERTICAL INTERVALS NOT TO EXCEED 10'-0".
- WALLS AND CEILINGS SHALL HAVE A SMOKE DEVELOPED INDEX NOT GREATER THAN 450 AS PER FBC 2010 R302.9.2 . A COMMON 2HR FIRE RESISTANCE RATED WALL TO UNDERSIDE OF ROOF SHEATHING (UL 263) IS REQUIRED, AS PER R302 FIRE RESISTANT CONSTRUCTION
- ROOF TO BE COVERED WITH A MINIMUM CLASS C ROOF COVERINGS AND THE ROOF DECKING OR SHEATHING IS OF NONCOMBUSTIBLE MATERIALS OR APPROVED FIRE RETARDANT TREATED WOOD FOR A DISTANCE OF 4 FEET ON EACH SIDE OF THE WALL OR ONE LAYER 5/8" TYPE GYPSUM BOARD IS INSTALLED DIRECTLY BENEATH THE ROOF DECKING OF
- SHEATHING TO COMPLY WITH FBC 2010 SECTION R302.2.2. 5. ENCLOSED ACCESSIBLE SPACE UNDER STAIR SHALL HAVE WALLS, UNDER STAIR SURFACE AND ANY SOFFITS PROTECTED ON THE ENCLOSED SIDE WITH ½ INCH GYPSUM BOARD AS PER FBC 2010 SECTION R302.7 UNDER-STAIR PROTECTION. 6. WALL AND CEILING FINISHES SHALL HAVE A FLAME SPREAD INDEX OF NOT GREATER THAN 200 AS PER FBC 2010 SECTION
- R302.9 FLAME SPREAD INDEX. . WALL AND CEILING FINISHES SHALL HAVE A SMOKE DEVELOPED INDEX OF NOT GREATER THAN 450 AS PER FBC 2016 8. INSULATION FLAME SPREAD INDEX SHALL NOT EXCEED 25 WITH AN ACCOMPANYING SMOKE -DEVELOPED INDEX NOT TO
- EXCEED 450 AS PER R302.10. 9. GLAZING MUST BE NOT LESS THAN 8 SQ FT. NATURAL VENTILATION IS REQUIRED, 4 PERCENT OF FLOOR AREA. R303." HABITABLE ROOMS.
- 10.EMERGENCY EGRESS AT ALL SLEEPING UNITS IS PROVIDED AND LABELED AS PER FBC 2010 SECTION R310.1. CONTRACTOR TO PROVIDE SMOKE ALARM IN EACH SLEEPING ROOM AND OUTSIDE EACH SEPARATE SLEEPING AREA IN THE IMMEDIATE VICINITY OF THE BEDROOMS. CONTRACTOR TO INTERCONNECT SMOKE ALARMS UPON ACTIVATION AS PER FBC 2010 SECTION R314.3.
- 12. CARBON MONOXIDE ALARMS TO BE PLACED WITHIN 10 FEET OF EACH ROOM USED FOR SLEEPING PURPOSES AS PER FBC 2010 SECTION R315.1. WARNING -

AND LOCATED.

LEGAL DESCRIPTION

PRIOR TO DIGGING

72 HOURS PRIOR TO DIGGING, THE LOT 9 IN BLOCK I, OF "JAFFE SUBDIVISION" ACCORDING TO THE PLAT THEREOF, AS CONTRACTOR SHALL COORDINATE ALL SUCH WORK WITH ALL UNDERGROUND UTILITY RECORDED IN PLAT BOOK 52 AT PAGE 95 OF SERVICES COMPANIES TO VERIFY LOCATION THE PUBLIC RECORDS OF MIAMI-DADE OF ALL UNDERGROUND UTILITIES. COUNTY, FLORIDA ADDITIONALLY, THE CONTRACTOR SHALL CONTACT SUNSHINE STATE ONE CALL OF FLORIDA, INC. (1-800-432-4770) TO ASSURE THAT ALL UTILITIES HAVE BEEN IDENTIFIED

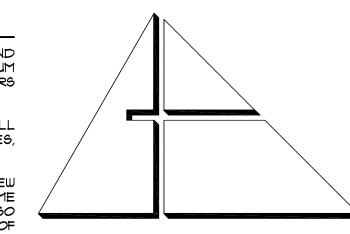

ALLEGUEZ ARCHITECTURE, INC.

ARCHITECTURE PLANNING DESIGN

CONSTRUCTION MANAGEMENT 901 PONCE DE LEON BLVD., SUITE 202 CORAL GABLES, FLORIDA 33134 (305) 461 4001 (FAX) 461 6002

MECHANICAL, ELECTRICAL, PLUMBING ENGINEER: GARTEK ENGINEERING CORP. 7210 SOUTHWEST 39TH TERRACE TEL: (305) 266-8997 FAX: (305) 264-9496

> CITY OF MIAMI LIFE QUEST **RENOVATIONS** 1301 N.E. 111 ST

Owner's Representative:


Lori B. Soto

City of Miami Department of Community Developmen (305) 416-2084 444 SW 2nd Avenue

Miami, FL. 33130


SITE PLAN, SCOPE OF WORK, GENERAL NOTES

AND DETAILS

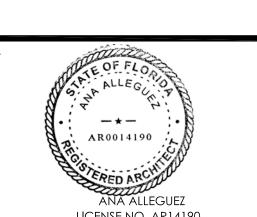

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	APRIL 15th, 2015

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GENERAL DEMOLITION NOTES

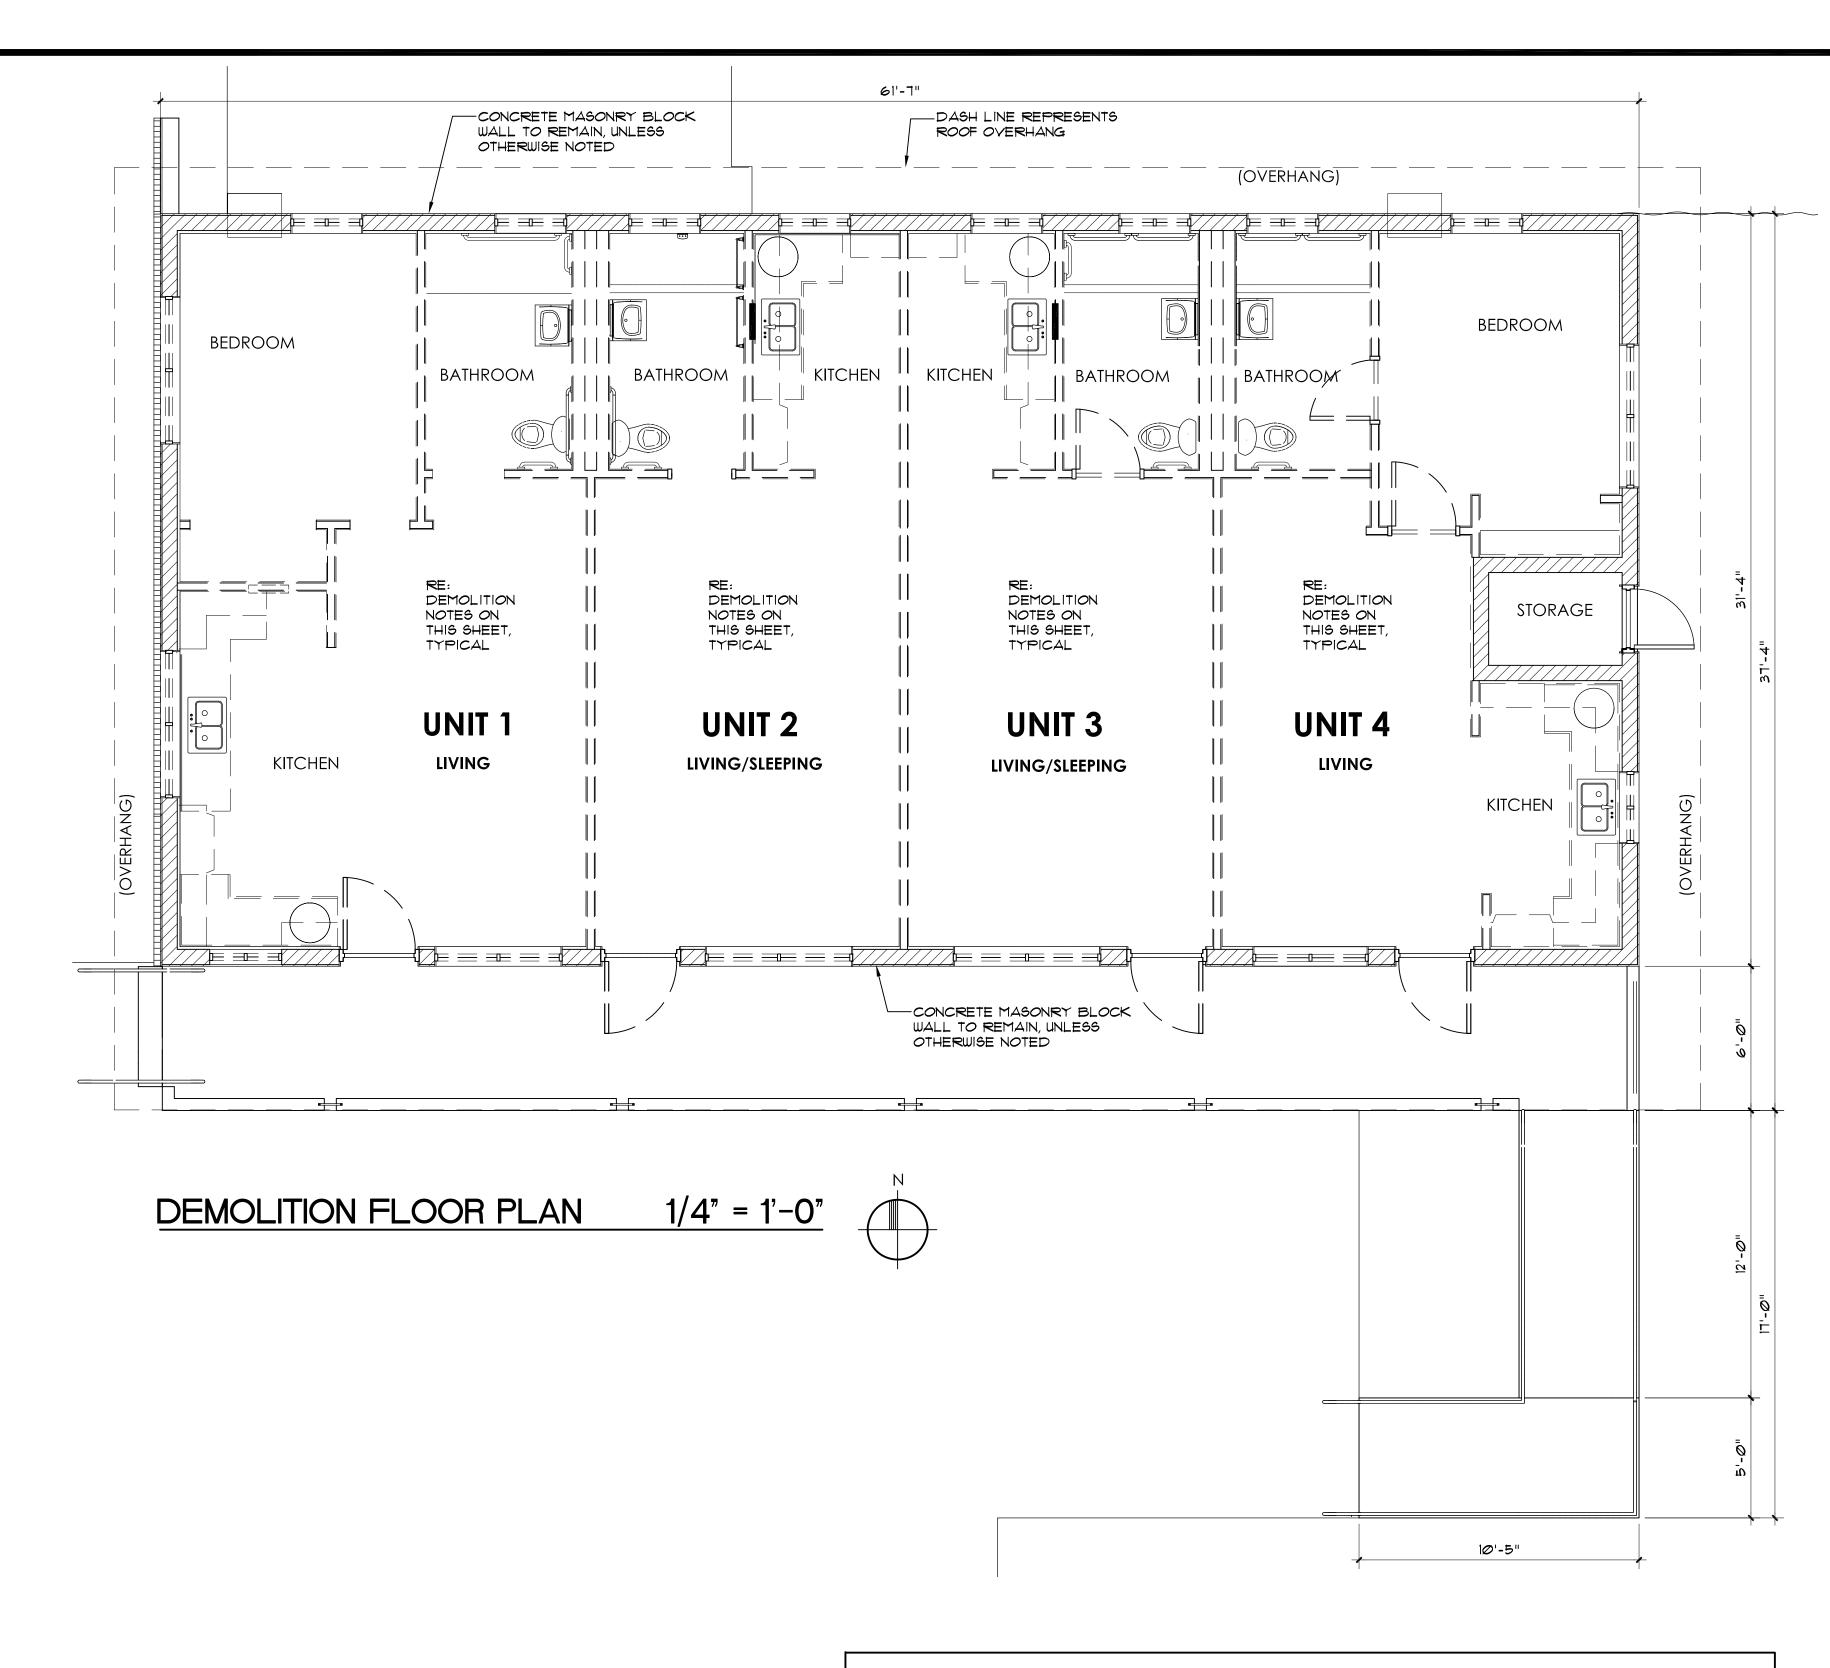- THE CONTRACTOR SHALL EXERCISE CARE DURING DEMOLITION AND REMOVAL TO ASSURE THAT ITEMS SCHEDULED FOR DEMOLITION ARE PROPERLY REMOVED AND ITEMS TO REMAIN ARE PROTECTED FROM DAMAGE. THE CONTRACTOR SHALL PROVIDE ALL SHORING AND TEMPORARY SAFEGUARDS AND WARNING SIGNS - AS REQUIRED.

 ALL FINISHES AND SURFACES TO REMAIN WHICH ARE DAMAGED DURING DEMOLITION AND/OR DURING NEW CONSTRUCTION SHALL BE REPAIRED AND REPLACED TO THE SATISFACTION OF THE ARCHITECT AT NO ADDITIONAL
- 4. THE CONTRACTOR SHALL FIELD VERIFY ALL DIMENSIONS AND EXISTING CONDITIONS PRIOR TO COMMENCEMENT OF WORK AND SHALL ADVISE THE ARCHITECT OF ANY DISCREPANCIES IN WRITTEN FORM WITHIN THREE DAYS. . ACTUAL EXISTING DIMENSIONS SHALL GOVERN.
- . DEMOLITION FLOOR PLAN DEPICTS CURRENT/EXISTING BUILDING LAYOUT-EXTERIOR, INCLUDING WINDOWS AND DOORS AND INTERIOR, INCLUDING PARTITION CONFIGURATION, PLUMBING FIXTURES AND CASEWORK.

DEMOLITION TASKS

COST TO THE OWNER.

PROPERTY LINES.

- . ALL EXISTING UNITS ROOM/PARTITION LAYOUTS, INCLUDING KITCHEN AND BATHROOM LAYOUTS ARE SIMILAR TO
- CORRESPONDING NEW LAYOUTS.
 DEMOLITION TASKS INCLUDED HEREIN APPLY TO ALL FOUR (4) INDIVIDUAL UNITS. . REMOVE ALL FRAME AND GYPSUM BOARD PARTITIONS AND ALL FURRING AND GYPSUM BOARD ON EXTERIOR CMU
- WALLS, THROUGHOUT ALL INTERIOR SPACES . REMOVE ALL GYPSUM BOARD AND FURRING CEILINGS (AT UNDERSIDE OF ROOF TRUSSES) THROUGHOUT ALL INTERIOR
- SPACES. REMOVE ALL MILLWORK AND ALL ARCHITECTURAL TRIM WORK.
- . REMOVE ALL INTERIOR WOOD DOORS AND FRAMES AND ALL EXTERIOR ALUMINUM DOORS AND WOOD FRAMES.
- REMOVE ALL ALUMINUM FRAME AND GLASS WINDOWS (IN EXTERIOR MASONRY WALLS).
- B. REMOVE ALL ARCHITECTURAL FINISHES INCLUDING YCT AND CERAMIC TILE FLOOR FINISHES. P. REMOVE ALL STEEL PIPE RAILING AT PORCH, PORCH STEPS AND RAMP.
- O. REMOVE ENTIRE SHINGLE ROOF SYSTEM DOWN TO PLYWOOD SHEATHING SUBSTRATE. 1. REMOVE ALL SOD, SHRUBS AND WEEDS - DOWN TO CLEAN, BARE TOPSOIL THROUGHOUT ENTIRE SITE.
- 2. REMOVE 6'(x)2'(x)7'(H), 8" C.B.S. EXTERIOR ROOM/ENCLOSURE AT CENTER/NORTH SIDE OF BUILDING, COMPLETELY,
- DOWN TO 8"(MIN.) BELOW GRADE 13. REMOVE EXISTING CONCRETE SLAB ON GRADE AT CENTER/NORTH SIDE OF BUILDING (APPROXIMATELY 16' (x) 4').
- 14. REMOVE EXISTING CONCRETE SLAB ON GRADE AT NORTH WEST CORNER OF PROPERTY (APPROXIMATELY 24' (x) 5'). 5. REMOVE 4' CHAIN-LINK FENCE, INCLUDING CONCRETE POST FOUNDATIONS, AT NORTH AND EAST SIDES, ALONG THOSE

A L L E G U E Z ARCHITECTURE, INC.

ARCHITECTURE PLANNING DESIGN INTERIOR CONSTRUCTION MANAGEMENT

901 PONCE DE LEON BLVD., SUITE 202 CORAL GABLES, FLORIDA 33134 (305) 461 4001 (FAX) 461 6002 E-MAIL alleguez@bellsouth.net ■AA C 0 0 2 7 4 6 ■

CONSULTANTS:

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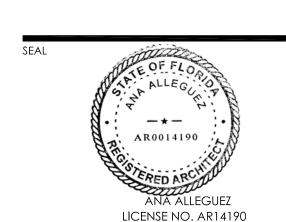
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Owner's Representative: Lori B. Soto

City of Miami **Department of Community Development** (305) 416-2084 444 SW 2nd Avenue Miami, FL. 33130

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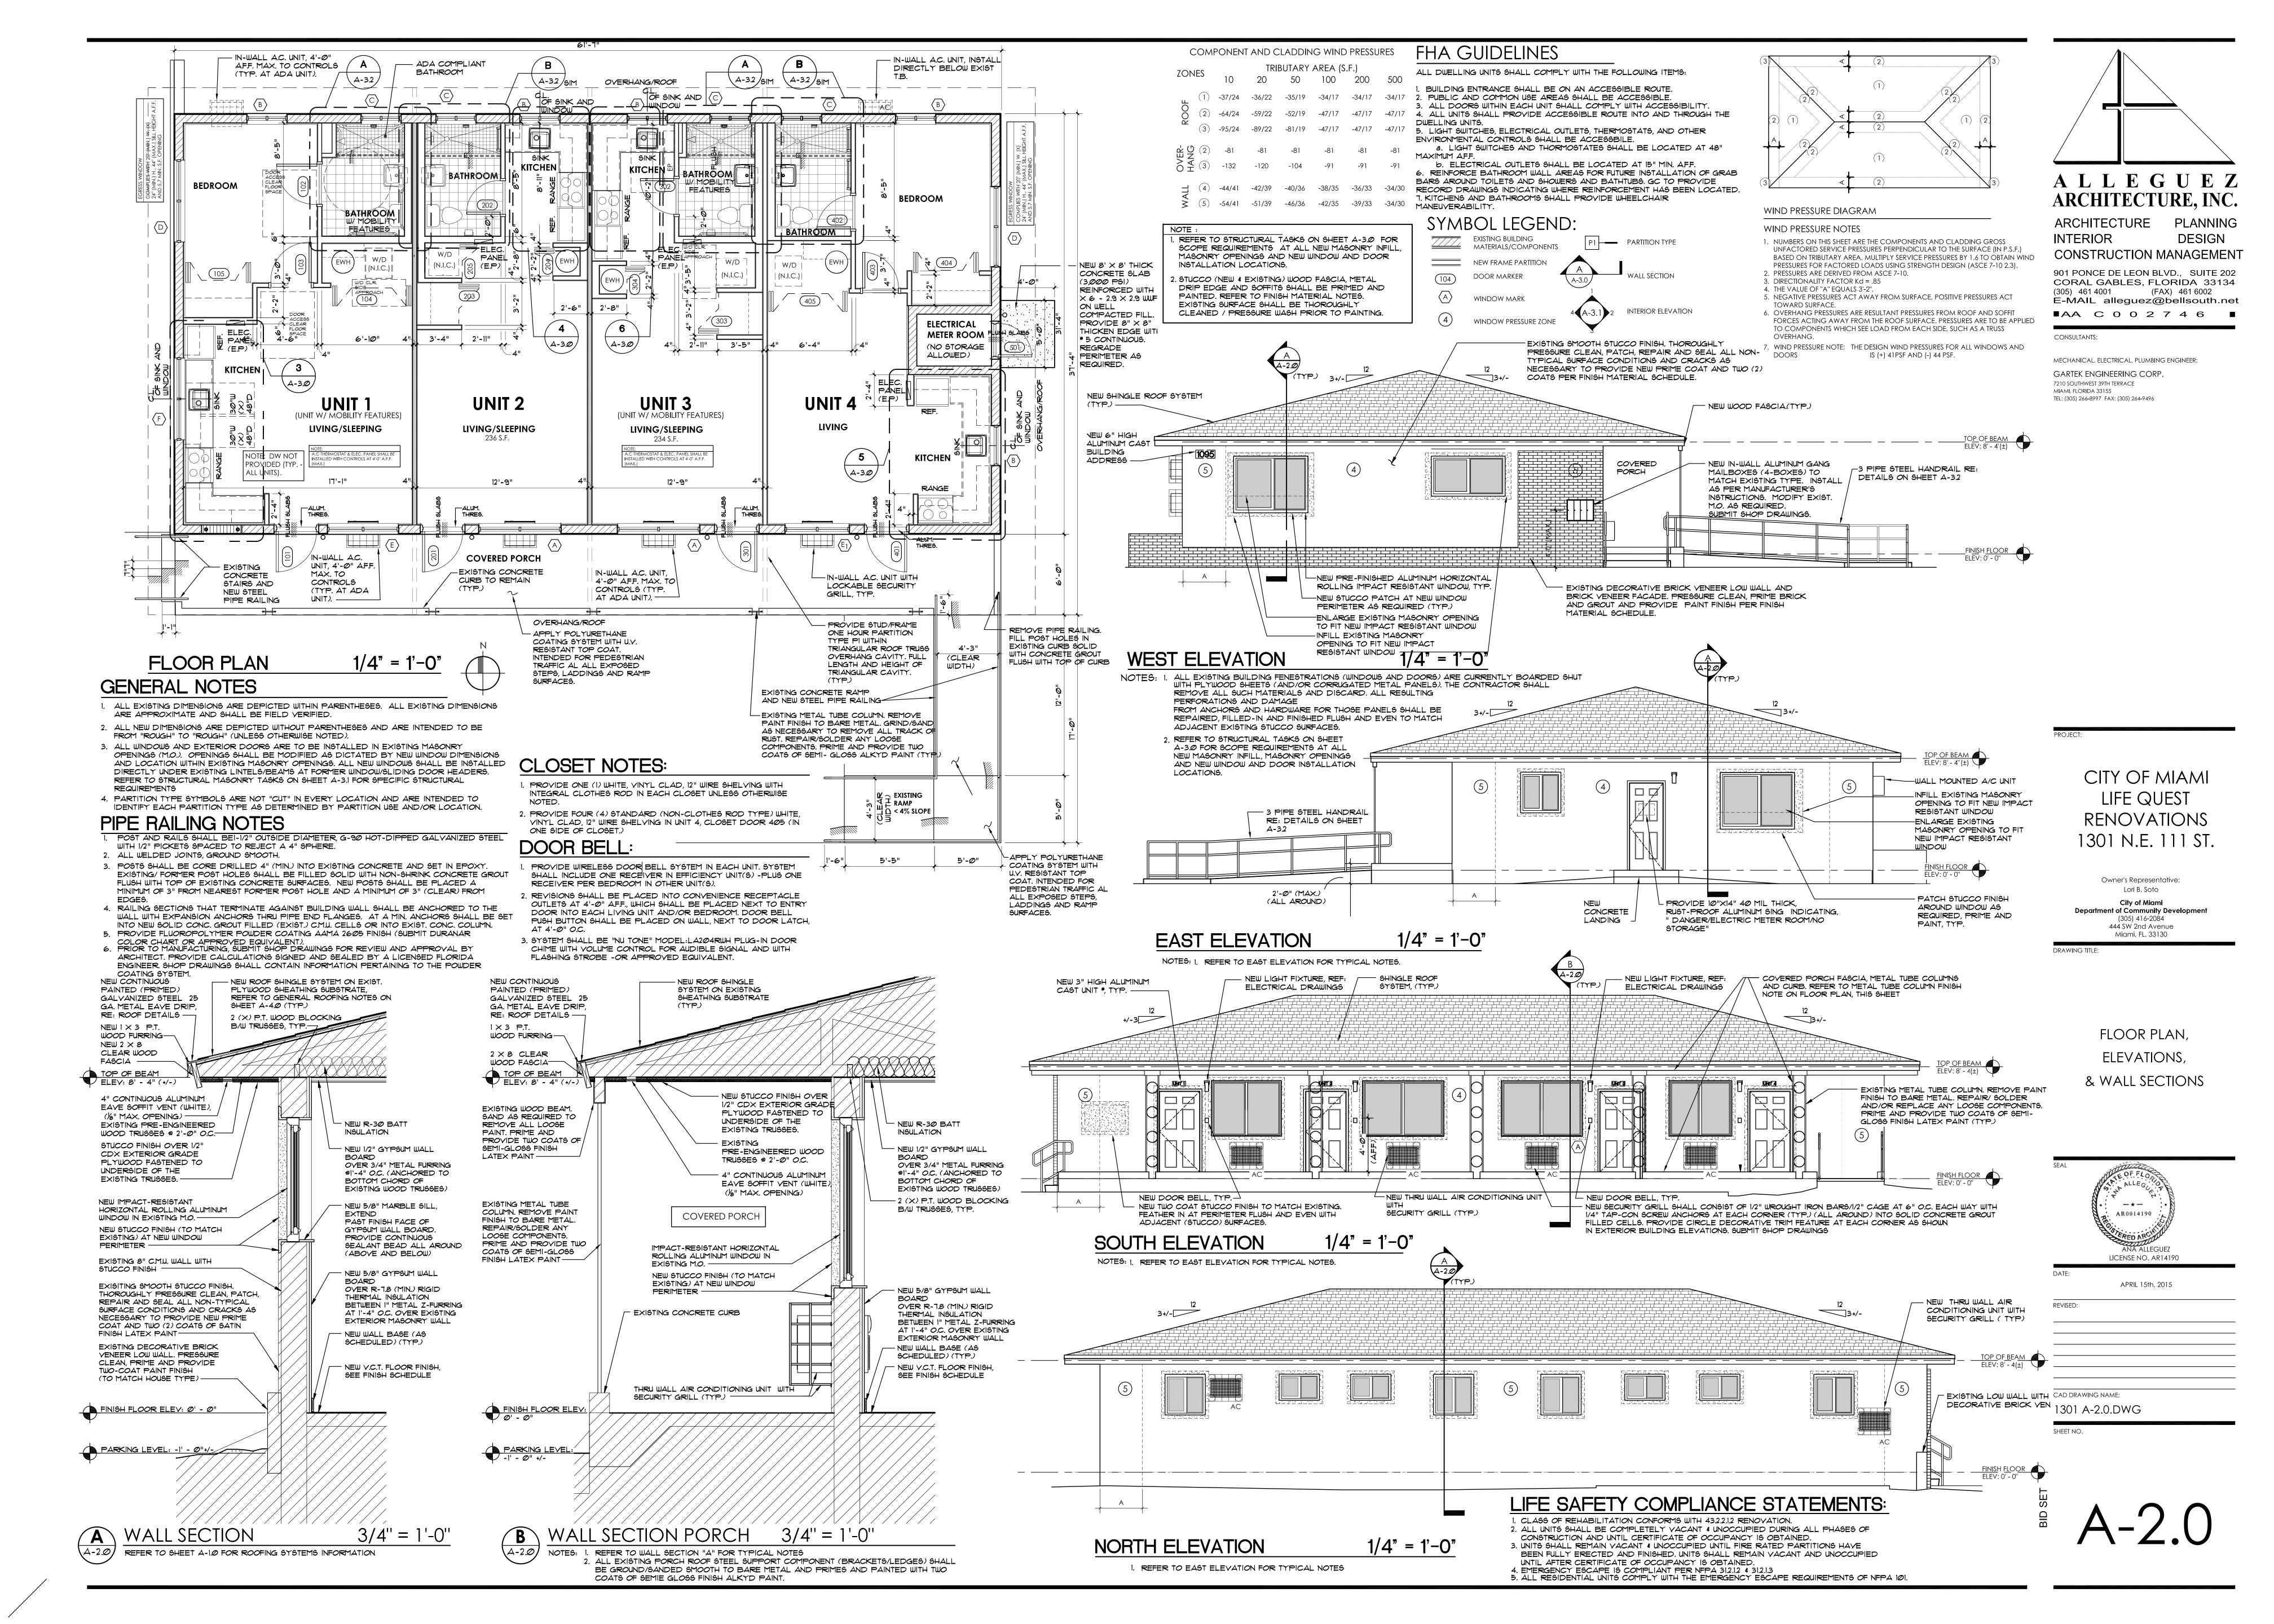
DEMOLITION FLOOR PLAN




APRIL 15th, 2015 REVISED:

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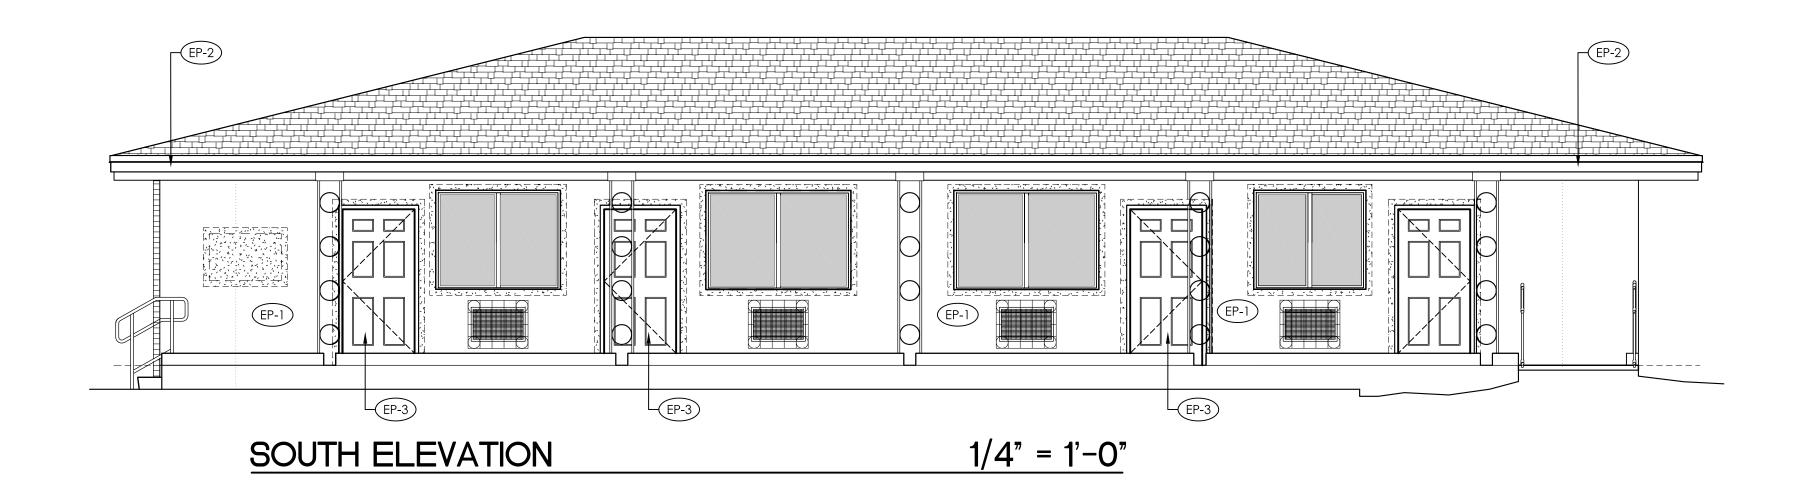
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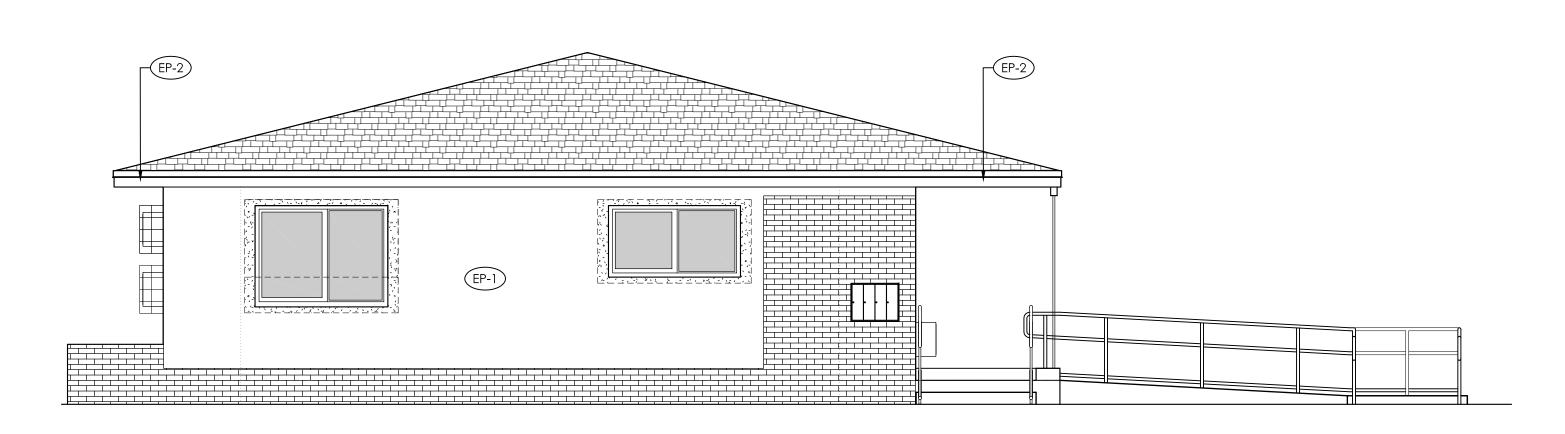




NORTH ELEVATION

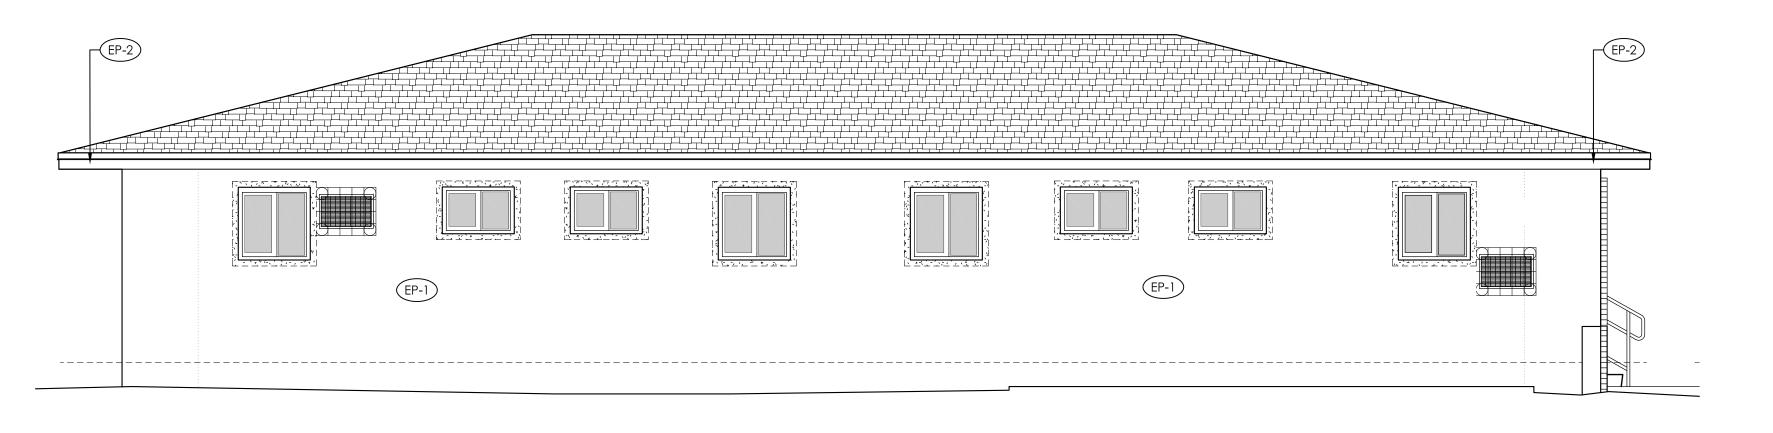
1/4" = 1'-0"





EAST ELEVATION

1/4" = 1'-0"

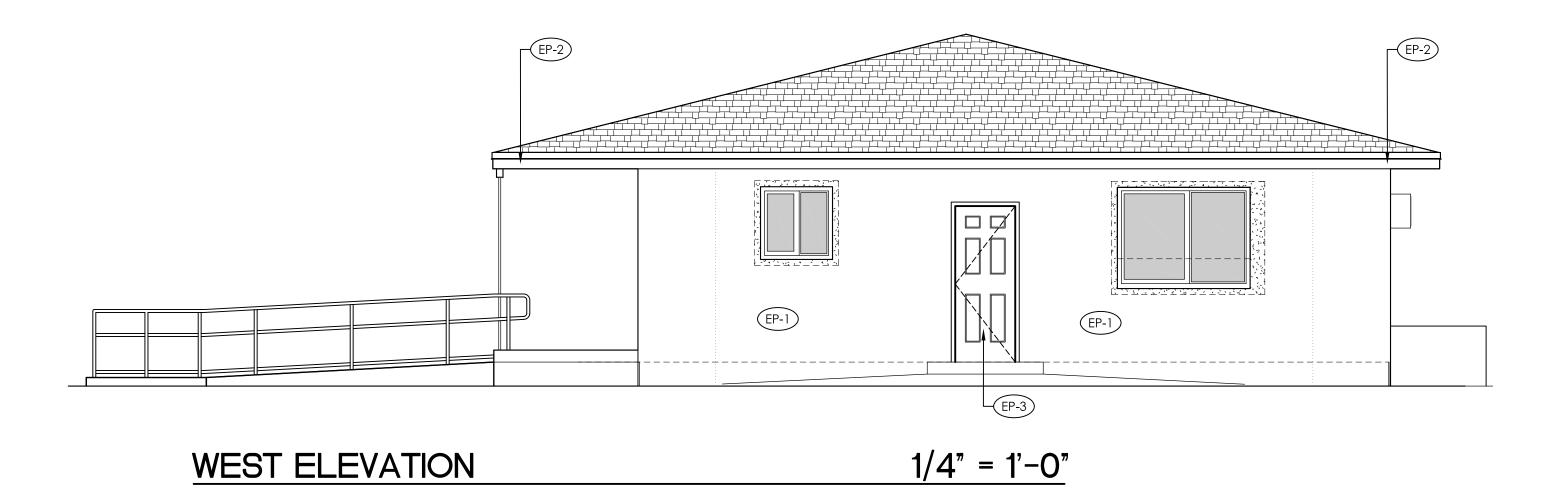


SYMBOL LEGEND

EP-1) DENOTES PAINT COLOR

EXTERIOR FINISHES SCHEDULE MARK COLOR REMARKS SLEEPY BLUE SW 6225 FIELD COLOR EP-2 EXTRA WHITE SW 7006 FASICA AND SOFFIT EP-3 EXTRA WHITE SW 7006

NOTES : . PROVIDE MOCKUP PAINT SAMPLES 4' imes 4' SQUARE FOR EACH

- COLOR OF PAINT TO BE APPROVED BY OWNER. 2. DO NOT PAINT OVER CODE-REQUIRED LABELS SUCH AS UNDERWRITERS LABORATORIES (UL) AND FACTORY MUTUAL (FM), NAME EQUIPMENT IDENTIFICATION, PERFORMANCE RATING, OR NOMENCLATURE PLATES.
- 3. PAINT WARRANTY: SIX (6) YEARS WARRANTY FOR LABOR AND MATERIAL FROM THE PAINT MANUFACTURER.
- 4. SHOP DRAWING SUBMITTAL: a. SUBMIT MANUFACTURER PRODUCT SAFETY DATA, MANUFACTURER'S TECHNICAL INFORMATION, INCLUDING PAINT LABEL ANALYSIS AND APPLICATION INSTRUCTIONS FOR EACH
- MATERIAL PROPOSED FOR USE: b. SAMPLES: PROVIDE COLOR CHIPS FOR REVIEW BY ARCHITECT C. SUBMIT PAINT MANUFACTURER'S PROPOSED 6 YEAR WARRANTY
- 5. PHASE PROJECT TO ALLOW A MINIMUM OF 28 DAYS FOR STUCCO AND PLASTER TO CURE PROPERLY. IF PAINTING BEGINS BEFORE THE 28 DAY CURING PERIOD, THEN A MOISTURE AND PH TEST SHALL BE MADE ACCORDING TO ASTM D4262 AND ASTM D4269.
- 6. DO NOT PAINT OVER FACTORY-FINISHED OR INSTALLER-FINISHED SPECIFIED ITEMS, CONCEALED SURFACES, FINISHED METAL MATERIAL (SUCH AS ANODIZED ALUMINUM, STAINLESS STEEL, BARE COPPER, BARE BRONZE AND METALS OF SIMILAR FINISH),
- OPERATING PARTS AND CODE REQUIRED LABELS. 1. BASIS OF DESIGN IS SHERWIN WILLIAMS OR APPROVED EQUIVALENT. REFER TO FINISH MATERIAL NOTES ON SHEET A-3.1 FOR PAINT SPECIFICATIONS.

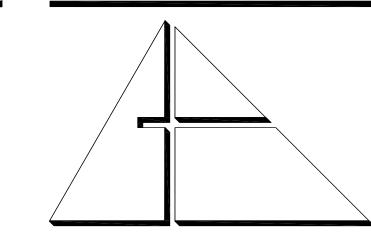

ALLEGUEZ ARCHITECTURE, INC.

ARCHITECTURE PLANNING INTERIOR DESIGN CONSTRUCTION MANAGEMENT

901 PONCE DE LEON BLVD., SUITE 202 CORAL GABLES, FLORIDA 33134 (305) 461 4001 (FAX) 461 6002 E-MAIL alleguez@bellsouth.net ■AA C 0 0 2 7 4 6 ■

CONSULTANTS:

MECHANICAL, ELECTRICAL, PLUMBING ENGINEER: GARTEK ENGINEERING CORP. 7210 SOUTHWEST 39TH TERRACE MIAMI, FLORIDA 33155 TEL: (305) 266-8997 FAX: (305) 264-9496


CITY OF MIAMI LIFE QUEST RENOVATIONS 1301 N.E. 111 ST.

Owner's Representative:

City of Miami
Department of Community Development
(305) 416-2084
444 SW 2nd Avenue
Miami, FL. 33130


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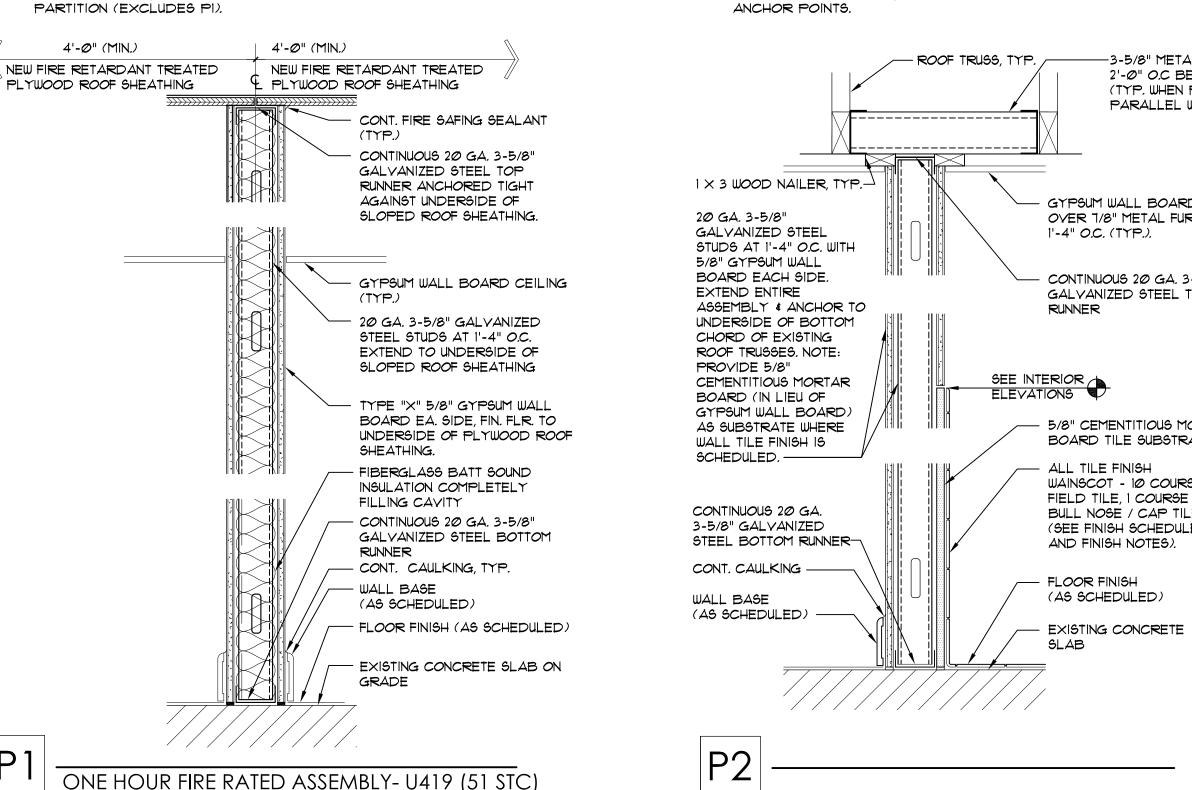
EXTERIOR FINISHES

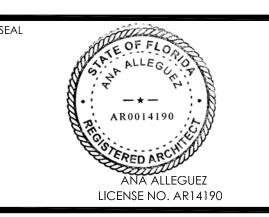

APRIL 15th, 2015

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METAL STUD FRAMING AT O.C BETWEEN TRUSSES, WHEN PARTITION IS LLEL WITH ROOF TRUSS)	1/2 " SPACE +++	-3-5/8" ME 2'-Ø" O.C (TYP. WHE PARALLE!
BOARD (CEILING) AL FURRING AT GA. 3-5/8" TEEL TOP		GYPSUM W, (CEILING) (FURRING A CONTINUOU
OUS MORTAR IBSTRATE	PARTITION TYPE PI SEE INTERIOR ELEVATIONS CONTINUOUS 20 GA. 3-5/8" GALVANIZED STEEL BOTTOM	GALVANIZE RUNNER TO ROOF TRUS CHORD 20 GA. 6" STEEL STUI WITH 5/8" O BOARD EA ENTIRE AS ANCHOR TO BOTTOM C
COURSES DURSE AP TILE HEDULE TES).	WALL TILE FINISH WAINSCOT - FULL TILE AT BOTTOM & TOP (SEE FINISH SCHEDULE AND FINISH NOTES)	EXISTING F NOTE: PRO CEMENTITION BOARD (IN WALL BOA' SUBSTRATE TILE FINISH FLOOR FINI (AS SCHED EXISTING C
	D2	
-4" <i>O.C.</i>	P3 SAME AS P3, BUT WITH (DUAL) 6" FRAME ASSIPROVIDED WITH GYPSUM BOARD ONLY, FRONTO TO TOP OF ASSEMBLY (IN LIEU OF MORTAR EFOR WAINSCOT).	1 FLOOR
	• SAME AS P3, BUT WITH (SINGLE) 6" FRAME AS PROVIDED WITH GYPSUM BOARD ONLY, FROM TO TOP OF ASSEMBLY (IN LIFT OF MORTAR E	M FLOOR

	ROOF TRUSS, TYP.
- GYPSUM WALL BOARD (CEILING) OVER 1/8" METAL FURRING AT 1'-4" O.C. (TYP.). - CONTINUOUS 20 G.A. 6" GALVANIZED STEEL TOP RUNNER TO UNDERSIDE OF ROOF TRUSS BOTTOM	1 × 3 WOOD NAILER, TYP. GYPSUM WALL BOARD (CEILING) OVER 1/8" METAL FURRING AT 1'-4" O.C. (TYP.). CONTINUOUS 20 GA. 3-5/8" GALVANIZED STEEL TOP RUNNER
CHORD - 20 GA. 6" GALVANIZED STEEL STUD AT 1'-4" O.C. WITH 5/8" GYPSUM WALL BOARD EACH SIDE. EXTEND ENTIRE ASSEMBLY & ANCHOR TO UNDERSIDE OF BOTTOM CHORD OF EXISTING ROOF TRUSSES. NOTE: PROVIDE 5/8" CEMENTITIOUS MORTAR BOARD (IN LIEU OF GYPSUM WALL BOARD) AS SUBSTRATE WHERE WALL TILE FINISH IS SCHEDULED.	20 GA. 3-5/8" GALVANIZED STEEL STUD AT 1'-4" O.C. WITH 5/8" GYPSUM WALL BOARD EACH SIDE. EXTEND ENTIRE ASSEMBLY & ANCHOR TO UNDERSIDE OF BOTTOM CHORD OF EXISTING ROOF TRUSSES. CONTINUOUS 20 GA. 3-5/8" GALVANIZED STEEL BOTTOM RUNNER FLOOR FINISH
(AS SCHEDULED) - EXISTING CONCRETE SLAB	P4
SSEMBLIES FOM FLOOR R BOARD	• SAME AS P3, BUT WITH 6" METAL STUD FRAMING AT 1'-4" O.C.

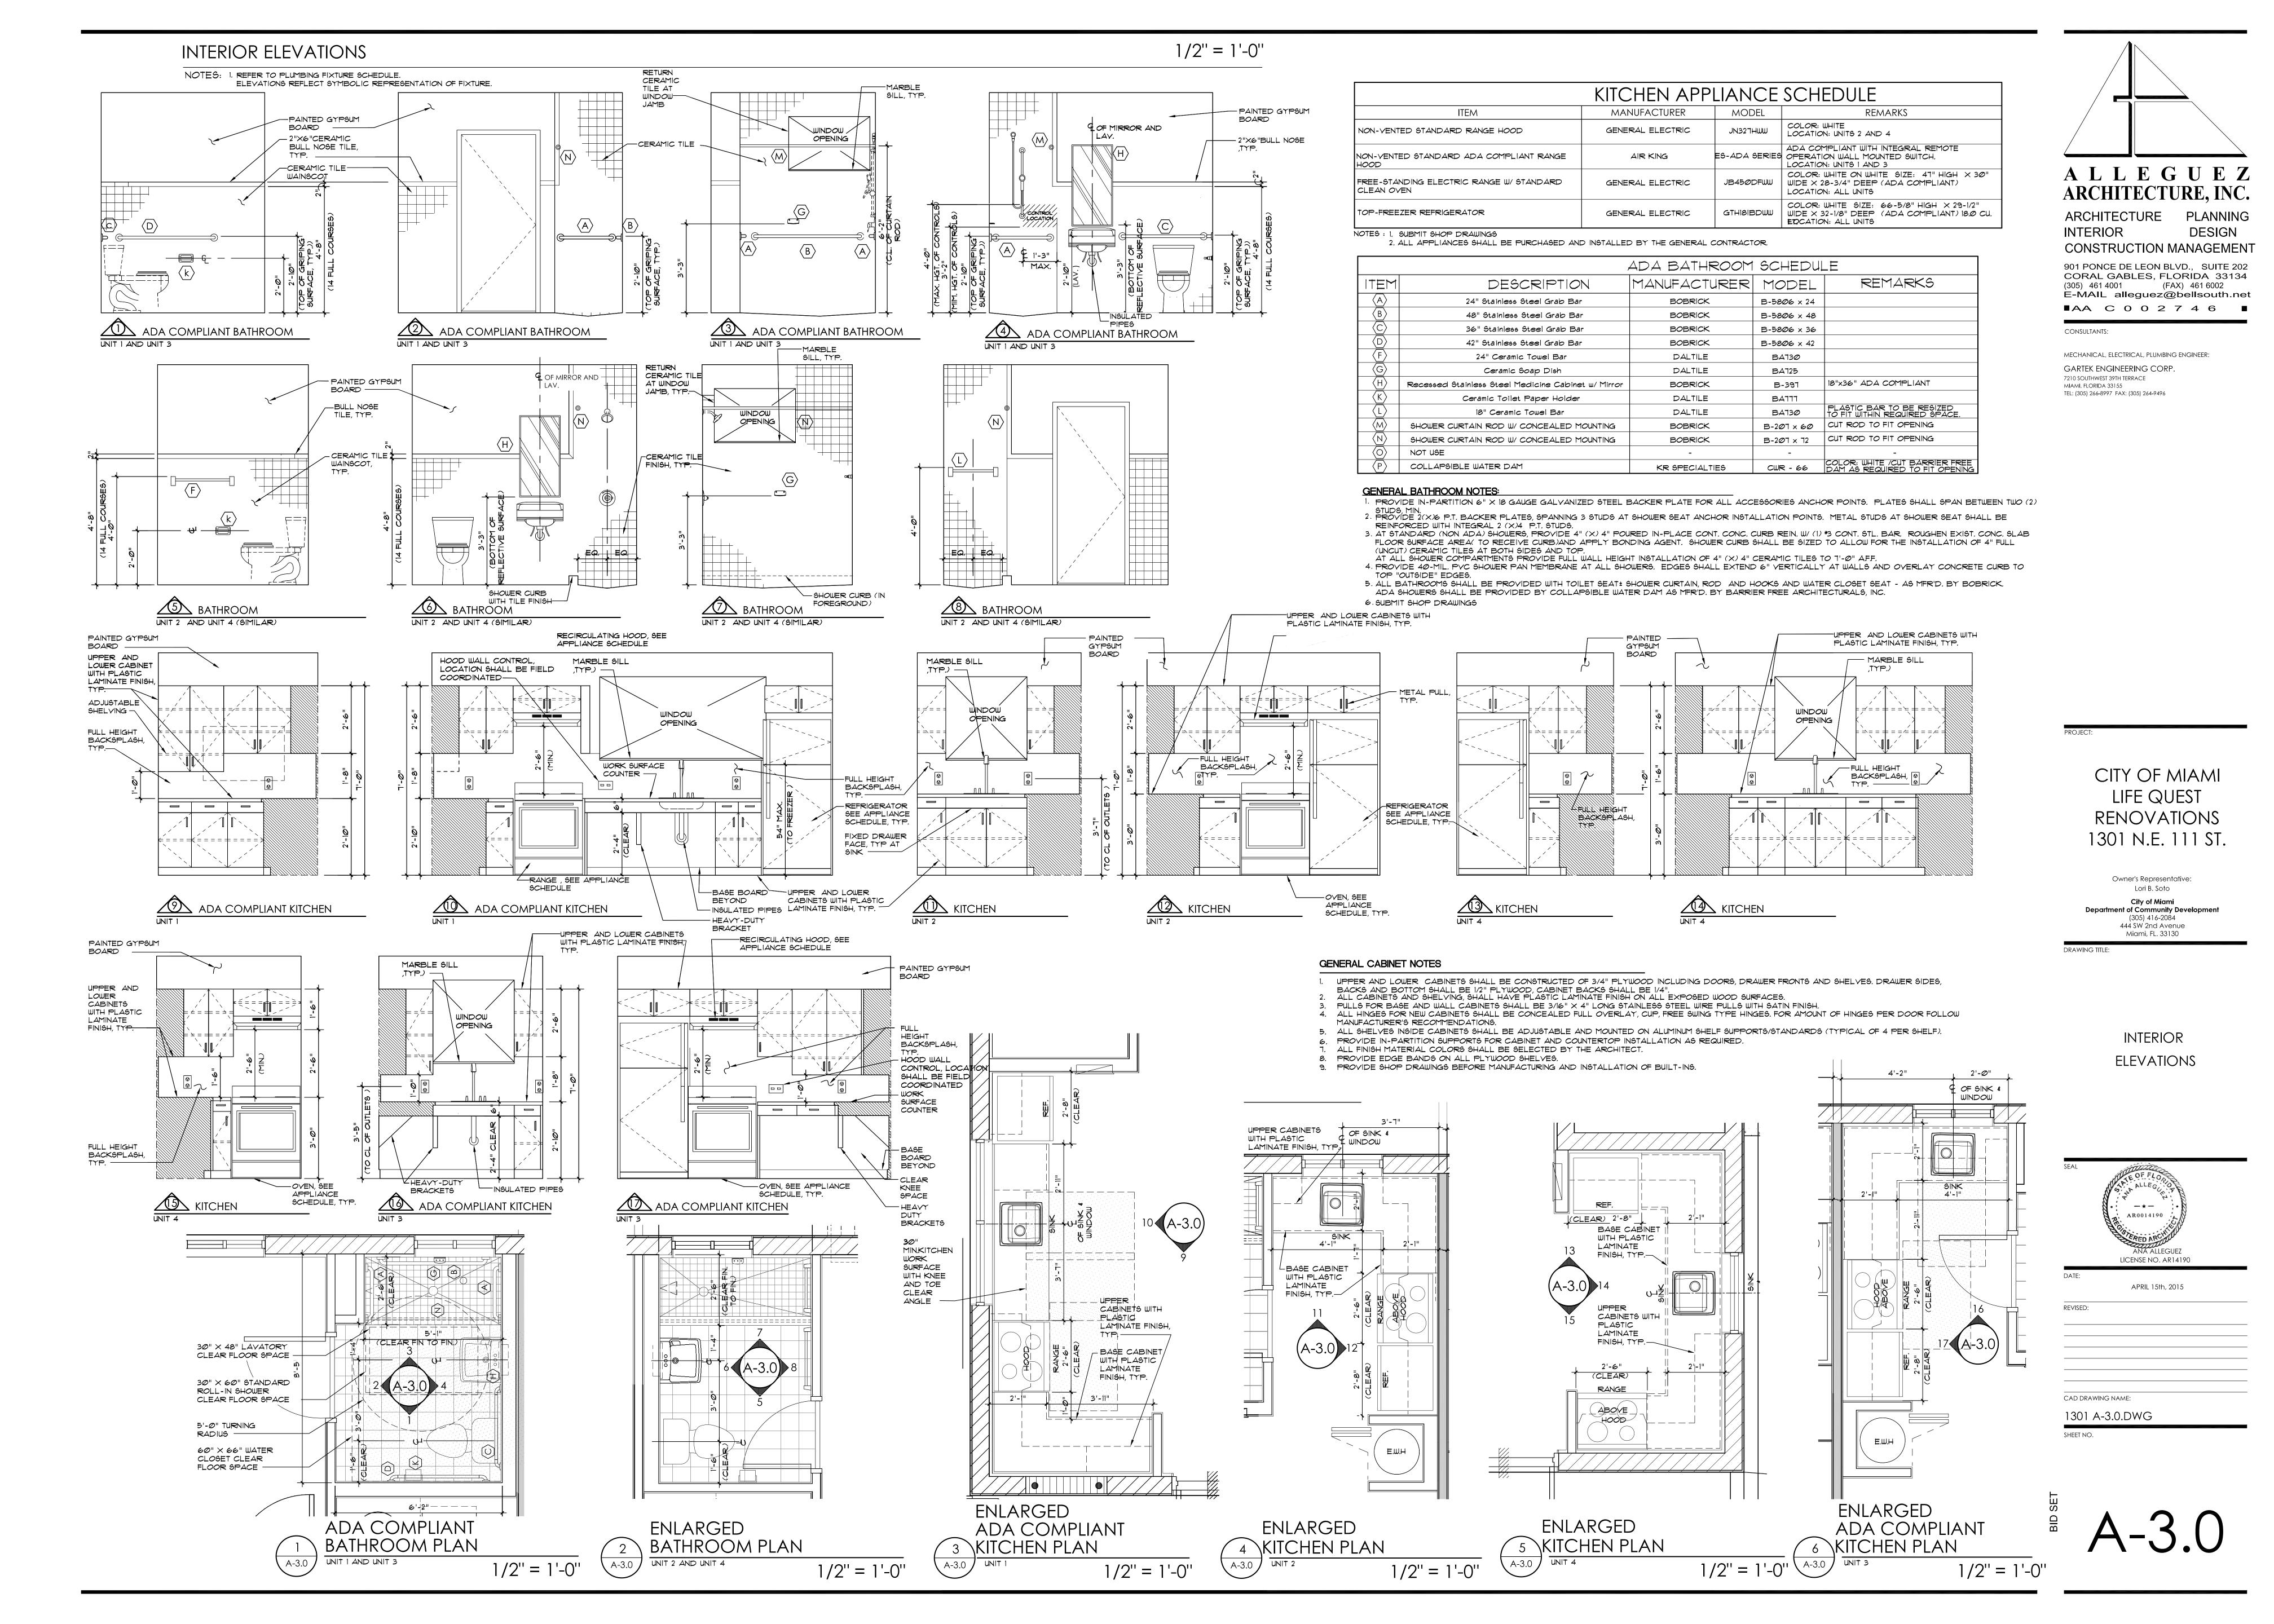FL# 11136.2. PROVIDE WITH ADA THRESHOLD

TO TOP OF ASSEMBLY (IN LIEU OF MORTAR BOARD

MATERIA

S.C. WOOD

S.C. WOOD

WOOD

WOOD

S.C. WOOD

WOOD

5.C. WOOD

S.C. WOOD

PROVIDE 1/2" MAX. HEIGHT ALUMINUM THRESHOLD WITH 1:2 (MAX.) CHAMFERED EDGES AT EXTERIOR DOORS.

3. PROVIDE PRE-FAB 1/2" MAX. HT. MARBLE THRESHOLD WITH CHAMFERED EDGES AT BATHROOM DOORS.

6. ALL WOOD DOORS AND FRAMES SHALL RECEIVE ONE PRIMER COAT AND TWO COATS SATIN LATEX PAINT.

FOR WAINSCOT).

1-3/4"

1-3/4"

1-3/4"

1-3/4"

1-3/4"

1-3/4"

5. WOOD BI-FOLD DOORS SHALL BE PROVIDED WITH METAL TRACK AT HEAD.

DOOR DOOR DOOR OPENING SIZE

C | 2' - 6"| 6' - 8"

A |3' - Ø"| 6' - 8"|

B |2' - 8"| 6' - 8"|

B | 2' - 6"| 6' - 8"|

5' - 0" 6' - 8"

6 - 0 6 - 8

HEAD; PROVIDE (3) STUD ANCHORS PER JAMB.

1. ALL EXTERIOR DOORS SHALL BE INSULATED (TYPE).

AT 3'-0" A.F.F. COMPLYING WITH FBCA-10.

DOOR ELEVATIONS

SINGLE

SWING

6-PANEL

A 2' - 10" 6' - 8" 1-3/4"

| B | 3' - 0" | 6' - 8" | 1-3/4"

TYPE | WIDTH | HEIGHT | THICKNESS

DOOR SCHEDULE

PAINT

PAINT 2

PAINT I DI

WOOD PAINT PAINT 1 D1 FL# 11136.2. PROVIDE WITHOUGH A TOPRESSION TO THE TOP OF THE TOP O

FRAME | DOOR | FRAME

PAINT

PAINT

PAINT

PAINT PAINT

PAINT

PAINT

PAINT

PAINT

PAINT

PAINT

PAINT

WOOD PAINT PAINT

NOT USED

WOOD | PAINT

WOOD PAINT

NOT USED

NOT USED

NOT USED

WOOD | PAINT

ALL DOORS SHALL BE INSTALLED WITH BACK OF DOOR FRAME, HINGE SIDE, AT 4" FROM NEAREST/ADJACENT PARTITION UNLESS OTHERWISE NOTED.

CONSISTING OF 1 (X) MAIN FRAME; 3" "CLAMSHELL" TYPE CASING ALL AROUND, BOTH SIDES AND INTEGRAL STOP. PROVIDE SHIM AS REQUIRED AND CONTINUOUS SEALANT BEAD BETWEEN ALL DISSIMILAR MATERIALS (BACK OF CASING TO GYPSUM BOARD). PROVIDE 2 (X) SUB-FRAME AT JAMBS &

8. PROVIDE "PEEP" HOLE IN EACH EXTERIOR/ENTRY DOOR. PROVIDE A SECOND (TWO) PEEP HOLE AT UNITS WITH MOBILITY FEATURES (HC. ACCESSIBLE)

WOOD

WOOD

WOOD

WOOD

WOOD WOOD

WOOD

WOOD

WOOD

WOOD

WOOD

4. INTERIOR DOORS SHALL BE SMOOTH FLUSH HARDWOOD COMPOSITE SOLID CORE PRE-HUNG (TYPE). FRAME SHALL BE WOOD, PAINT GRADE

1/4" = 1'-0"

4 - LEAF

BI FOLD

LOUVER

1/2" = 1'-0"

	WINDOW SCHEDULE \bigcirc												
MARK	TYPE	SIZE		MAT	TERIAL			FINIS			REMARKS		
TVI/ (IXIX		SIZL	FRA	ME	GLA	zing	FRA	FRAME GLAZING		\mathcal{G}	KLIVIAKKS		
Д	HORIZONTAL ROLLING	72" × 48"	ALUN	1INUM I	LAMINA GLASS		ESP - WHITE TINTED			MIAMI-DADE COUNTY NOTICE OF ACCEPTANCE (N.O.A.): 15-0929.13			
В	HORIZONTAL ROLLING	36" × 36"											
С	HORIZONTAL ROLLING	36" × 24"							FROSTE	D			
D	HORIZONTAL ROLLING	66" × 50-5/8"											
E	HORIZONTAL ROLLING	60" × 48"											
E1	HORIZONTAL ROLLING	54" × 48"											
F	HORIZONTAL ROLLING	66" × 36"		/									

- WINDOW SCHEDULE VALUES ARE BASED ON WINDOW MODELS MANUFACTURED BY CGI WINDOWS AND DOORS, SENTINEL HORIZONTAL ROLLING WINDOW SERIES 120 AND ARE SPECIFIED TO ESTABLISH PROJECT WINDOW STANDARDS. WINDOWS SHALL HAVE CURRENT MIAMI-DADE COUNTY PRODUCT APPROVAL NOTICE OF ACCEPTANCE (N.O.A.).
- GLÁZING SHALL BE 5/16" IMPACT RESISTANT LO E 366 WITH GRAY TINT, SUBMIT GLÁZING SAMPLE FOR APPROVAL 4. ALL WINDOWS WITHIN 4'-O" ADJACENCY TO A DOOR, AND ALL WINDOWS WITHIN BATHROOMS SHALL BE OF
- CATEGORY II SAFETY GLAZING PROVIDE 8" X 8" CONCRETE SILL WITH 2 # 5 REINFORCING CONTRACTOR SHALL FIELD VERIFY MASONRY OPENINGS PRIOR TO FABRICATION OF WINDOWS.

9. EACH WINDOW SHALL HAVE AN INSECT SCREEN.

UL U419 (51 STC)

• PROVIDE CONTINUOUS FIRE SEALANT BEAD AROUND ENTIRE PERIMETER

UNITS) WITHIN OPPOSITE STUD-TO-STUD CAVITIES.

INFILL THE TRIANGULAR OVERHANG CAVITY.

(BOTH SIDES) AND AROUND CUTOUTS. LOCATE CUTOUTS (FOR ADJACENT

• TOP OF ASSEMBLY SHALL BE EXTENDED THROUGH OVERHANG, TO BACK

• FIRE RETARDANT-TREATED ROOF SHEATHING SHALL EXTEND TO FASCIA

RESISTANT GWB (IN LIEU OF STANDARD TYPE "X" GWB), OMIT INSULATION.

• PI WITHIN TRUSS CAVITY SHALL BE PROVIDED WITH TYPE "X" MOISTURE

OF FASCIA, TOP/INSIDE FACE OF OVERHANG SOFFIT TO COMPLETELY

CONTRACTOR SHALL BE RESPONSIBLE TO COORDINATE DOORS / WINDOWS OVERALL DIMENSIONS WITH ROUGH MASONRY OPENINGS. CONTRACTOR SHALL SUBMIT WINDOW SHOP DRAWINGS PRIOR TO ORDERING WINDOWS FOR ARCHITECT'S REVIEW FOR APPROVAL.

-									
FINISH SCHEDULE									
UNIT	NAME	ROOM NO.	FLOOR	BASE	WALL	WAINSCOT	CEILING	REMARKS	
LINUT 1	LIVING	111	Y.C.T.	WOOD/TYPE 1	PAINT	N/A	PAINT		
UNIT 1	KITCHEN	112	Y.C.T.	WOOD/TYPE 1	PAINT	N/A	PAINT		
(ADA	BATHROOM	113	CERAMIC TILE	COVE C.T.	PAINT	CERAMIC TILE	PAINT	SEE GENERAL FINISH NOTES 2 AND 3	
COMP.)	BEDROOM	114	Y.C.T.	WOOD/TYPE 1	PAINT	N/A	PAINT		
	LIVING/SLEEPING	121	Y.C.T.	WOOD/TYPE 1	PAINT	N/A	PAINT		
UNIT 2	KITCHEN	122	Y.C.T.	WOOD/TYPE 1	PAINT	N/A	PAINT		
	BATHROOM	123	CERAMIC TILE	COVE C.T.	PAINT	CERAMIC TILE	PAINT	SEE GENERAL FINISH NOTES 2 AND 3	
UNIT 3 (ADA	LIVING/SLEEPING	131	V.C.T.	WOOD/TYPE 1	PAINT	N/A	PAINT		
(ADA	KITCHEN	132	V.C.T.	WOOD/TYPE 1	PAINT	N/A	PAINT		
COMP.)	BATHROOM	133	CERAMIC TILE	CERAMIC TILE	PAINT	CERAMIC TILE	PAINT	SEE GENERAL FINISH NOTES 2 AND 3	
	LIVING	141	V.C.T.	WOOD/TYPE 1	PAINT	N/A	PAINT		
UNIT 4	KITCHEN	142	V.C.T.	WOOD/TYPE 1	PAINT	N/A	PAINT		
	BATHROOM	143	CERAMIC TILE	CERAMIC TILE	PAINT	CERAMIC TILE	PAINT	SEE GENERAL FINISH NOTES 2 AND 3	
	BEDROOM	144	V.C.T.	WOOD/TYPE 1	PAINT	N/A	PAINT		
N/A	STORAGE	151	CONCRETE (EXISTING)	N/A	PAINT	N/A	PAINT		

GENERAL FINISH NOTES

- ALL NEW GYPSUM BOARD SURFACES SHALL BE PROVIDED WITH TAPED AND COMPOUND LEVEL 4 (SMOOTH). 2. ALL VERTICAL SURFACES SCHEDULED TO RECEIVE CERAMIC TILE SHALL BE PROVIDED WITH 5/8" CEMENTITIOUS BOARD AS SUBSTRATE FOR WALL TILE
- 3. REFER TO INTERIOR ELEVATIONS FOR TILE INSTALLATION HEIGHTS. 4. PROVIDE FIRE STOP AT ALL CAVITY WALLS/ PARTITION A 8'-0" MAX.
- 5. ALL CONCRETE SURFACES SCHEDULED TO RECEIVE YCT SHALL RECEIVE ARMSTRONG 5-184 FAST SETTING PATCH/ UNDERLAYMENT LEVELING COMPOUND OR APPROVED EQUIVALENT.
- 6. PRIOR TO YCT INSTALLATION, FOLLOW RESILIENT TILE MANUFACTURER'S INSTRUCTIONS AND PERFORM BOND TEST, MOISTURE TEST, PH TEST AND YAPOR EMISSION TESTS IN ACCORDANCE THE RESPECTIVE ASTM STANDARDS.

FINISH MATERIALS

FLOORING VINYL COMPOSITION TILE:

- MANUFACTURER / TYPE: ARMSTRONG EXCELON (OR APPROVED EQUIVALENT) COLOR / PATTERN: TO BE SELECTED BY ARCHITECT
- PORCELAIN FLOOR TILE MANUFACTURER: DALTILE (OR APPROVED EQUIVALENT)
 MODEL: KEYSTONE 2 × 2 (GROUP 1 OR 2) AT SHOWERS
 COLOR: TO BE SELECTED BY ARCHITECT
 MODEL:PORCEALTO 8 × 8 AT BATHROOMS
 COLOR: TO BE SELECTED BY ARCHITECT
- TO BE SELECTED BY ARCHITEC' NOTES: CENTER TILE IN ROOM ADJUST AS NECESSARY TO AVOID LESS THAN HALF A TILE AT PERIMETER. WALL TILE (WAINSCOT AND SHOWER WALLS): MANUFACTURER / TYPE: DALTILE SEMI-GLOSS WALL TILE
- WALL TILE: $4" \times 4" \times 1/4"$ (NOMINAL) WAINSCOT BULL NOSE: 2" X 6" (NOM.) NOTE: PROVIDE COVE EDGE TILES AT ALL TILE EXPOSED

GROUP I AND 2 (OR APPROVED EQUIVALENT)

TILE GROUT: MANUFACTURER: MAIPEI OR APPROVED EQUIVALENT GROUT COLOR - TO BE SELECTED BY ARCHITECT NOTE: ALL GROUT JOINTS SHALL BE 1/8" - OR MINIMUM

RECOMMENDED BY TILE MANUFACTURER.

WALL WOOD BASE: DOOR WOOD CASING / TRIM:

PAINT GRADE PINE, $4" \times 1/2"$ (NOMINAL) REFER TO DETAIL PAINT GRADE PINE, 3-1/2" X 3/4" (NOMINAL) REFER TO DETAIL.

WALL FINISH (PAINT):

- MANUFACTURER: SHERWIN WILLIAMS PAINTS (OR APPROVED EQUIVALENT) INTERIOR (GYPSUM BOARD SURFACES - WALLS AND CEILINGS)
- ALL GYPSUM BOARD SURFACES SHALL RECEIVE ONE COAT OF PROMAR 200 ZERO YOC INTERIOR LATEX PRIMER WHITE AND TWO (2) COATS OF LATEX BASED SEMI-GLOSS PROMAR 200 ZERO VOC. CONTRACTOR SHALL PROVIDE 4' X 4' PAINT SAMPLES OF EACH COLOR FOR APPROVAL COLOR: ONE COLOR - TO BE SELECTED

 $igcolone{1}$ SAME AS P2 BUT WITH 6" METAL STUD FRAMING AT 1'-

- INTERIOR (WOOD TRIM BASE BOARDS, DOOR FRAMES AND INTERIOR WOOD DOORS): ALL WOOD TRIM SURFACES SHALL RECEIVE ONE COAT OF PREPRITE PROBLOCK LATEX PRIMER/ SEALER WHITE AND TWO (2) COATS OF GLOSS FINISH PAINT PRO INDUSTRIAL DTM ACRYLIC GLOSS EXTRA WHITE CONTRACTOR SHALL PROVIDE PAINT SAMPLE (ON MATERIAL) FOR APPROVAL
- COLOR: WHITE EXTERIOR METAL DOORS: ALL EXTERIOR METAL DOORS SHALL BE PAINTED WITH ONE (1) COAT OF PRO INDUSTRIAL PRO-CRYL UNIVERSAL ACRYLIC PRIMER AND 2 COATS OF PRO INDUSTRIAL DTM ACRYLIC GLOSS
- EXTERIOR (CEMENT / PLASTER SURFACES): CEMENT STUCCO / PLASTER SURFACES SHALL RECEIVE ONE COAT HOT STUCCO SEALER AND TWO (2) COATS OF SUPERPAINT ACRYLIC LATEX SATIN PAINT FINISH

COUNTERTOP AND BACKSPLASH (PLASTIC LAMINATE): MANUFACTURER: WILSONART OR APPROVED EQUIVALENT COLOR: TO BE SELECTED BY ARCHITECT

SUBMIT SAMPLES FOR APPROVAL BY ARCHITECT

INTERIOR FINISHES AND INSULATION CLASSIFICATIONS INTERIOR WALL AND CEILING FINISH SHALL BE CLASS C. • INSULATION MATERIALS SHALL HAVE A FLAME SPREAD INDEX OF NOT MORE THAN 25 AND A SMOKE-DEVELOPED INDEX OF NOT MORE THAN 450.

SINGLE-

SWING

FLUSH

2 - LEAF

BI FOLD

LOUVER

BURGLARY SECURITY + FORCED ENTRY


- EXTERIOR DOORS LOCK SETS: SHALL RESIST A FORCE OF 300 LBS. APPLIED IN ANY MOVEABLE DIRECTION IN ACCORDANCE WITH THE RESISTANCE STANDARDS
- 2. EXTERIOR WINDOWS: SHALL BE LOCKED WITH LOCKING DEVICE LOCATED ON THE INTERIOR SIDE OF THE WINDOW AND SHALL BE CAPABLE OF WITHSTANDING A
- 3. WINDOW SUB-BUCKS: SHALL CONSIST OF 2" MIN. (NOMINAL) PRESSURE TREATED

- IN THE LATEST EDITION OF THE F.B.C.
- FORCE OF 150 LBS. APPLIED IN ANY OPERABLE DIRECTION
- SUB-BUCKS ANCHORED TO CONC. / MASONRY IN A MIN. OF SIX (6) ON EACH SIDE, WITH 3" (LONG) FASTENERS.

DOOR FINISH HARDWARE SCHEDULE GROUP 1 (FRONT ENTRY DOORS) <u>QUAN.</u> DESCRIPTION <u>MODEL</u> <u>FIN.</u> F51 ELA 626 SCH KEYED ENTRY LOCKSET 626 B60R6 SCH DEADBOLT 3 EA. 630 HAGER SET WEATHERSTRIPING (BY DOOR MFR.) 7785 DOOR BOTTOM SWEEP HAGER 623A UM.AL ZERO THRESHOLD SPRING CHAIN (DOOR SWING STOP) 1 E.A. **GROUP 2** (BEDROOM/BATHROOM DOORS)

N.T.S. <u>QUAN.</u> <u>MODEL</u> <u>DESCRIPTION</u> <u>FIN.</u> 626 SCH PRIVACY LOCKSET F51 ELA 3 EA. HINGES 630 HAGER 1 E*A.* US26D IVES WALL STOP MARBLE THRESHOLD (AT BATHROOM 1 E.A. DOOR ONLY) NOTES: ENTRY DOORS LOCKSETS COMBO SHALL BE KEYED ALIKE.

- PROVIDE OWNER WITH MASTER KEY FOR ALL UNITS. PROVIDE IN-PARTITON METAL BACKING PLATE FOR WALL STOP. 4. SUBMIT SHOP DRAWINGS FOR REVIEW.
 - 5. ALL CATALOG NUMBERS REFERRED TO IN THE HARDWARE SCHEDULE ARE TAKEN FROM CATALOGUES OF THE MANUFACTURERS LISTED. THEY ARE USED ONLY TO ESTABLISH THE QUALITY AND TYPE OF HARDWARE TO BE USED. HARDWARE EQUAL IN QUALITY AND UTILITY WILL BE ACCEPTED PROVIDED I CONFORMS IN OPERATION, QUALITY, WEIGHT, SIZE, WORKMANSHIP, AND FINISH-TO THE PRODUCTS DESCRIBED - AS DETERMINED BY THE ARCHITECT.

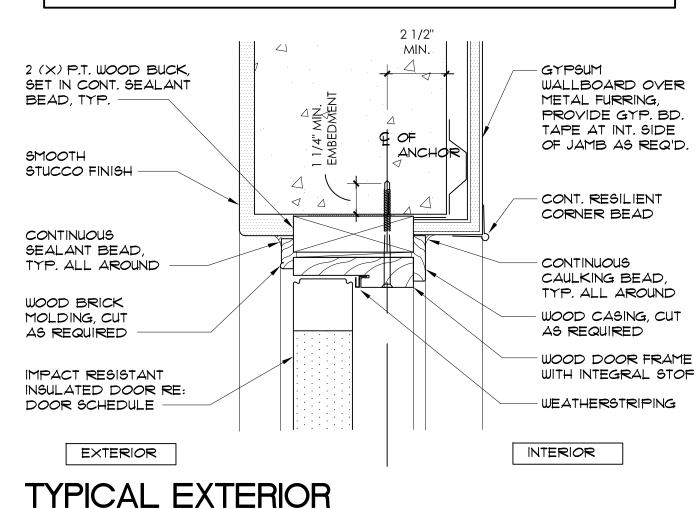

DOOR HEAD DETAIL


JAMB SIMILAR

ARCHITECTURE, INC. ARCHITECTURE PLANNING DESIGN INTERIOR CONSTRUCTION MANAGEMENT 901 PONCE DE LEON BLVD., SUITE 202 CORAL GABLES, FLORIDA 33134 (FAX) 461 6002 (305) 461 4001 E-MAIL alleguez@bellsouth.net **S**AA C 0 0 2 7 4 6 CONSULTANTS:

ALLEGUEZ

GARTEK ENGINEERING CORP. 7210 SOUTHWEST 39TH TERRACE MIAMI, FLORIDA 33155 TEL: (305) 266-8997 FAX: (305) 264-9496

MECHANICAL, ELECTRICAL, PLUMBING ENGINEER:

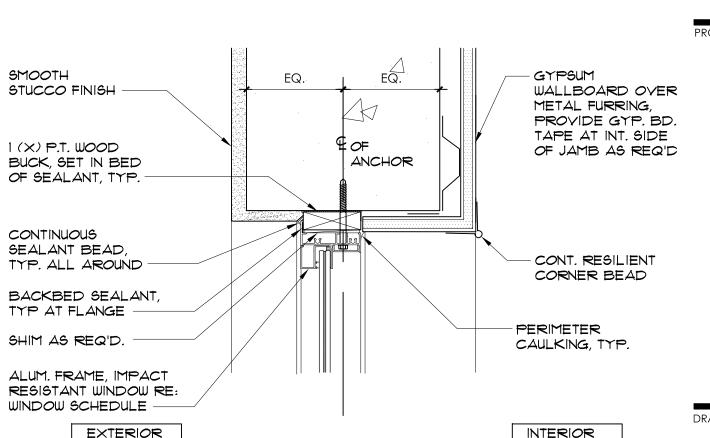

EXTERIOR INTERIOR

TYPICAL WINDOW HEAD DETAIL 3"=1'-0' JAMB SIMILAR

- DOOR CASING, TYPE "I" BELOW (TYP.) 1-3/4" DOOR, RE: DOOR SCHEDULE INTEGRAL DOOR STOP DOOR CASING, TYPICAL INTERIOR DOOR


HEAD + JAMB DETAIL CASING **BOARD** PAINT GRADE PINE 3 1/2" EDGE <u>TYPE "1"</u>

<u>TYPE "1"</u>

CITY OF MIAMI LIFE QUEST **RENOVATIONS** 1301 N.E. 111 ST.


Owner's Representative: City of Miami Department of Community Developmen (305) 416-2084 444 SW 2nd Avenue Miami, FL. 33130

PARTITION TYPES, WALL SECTIONS, **SCHEDULES & DETAILS**

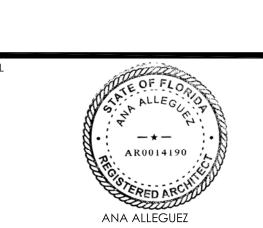

LICENSE NO. AR14190 DATE: SEPTEMBER 15, 2014

CAD DRAWING NAME: 1301 A-3.1.DWG

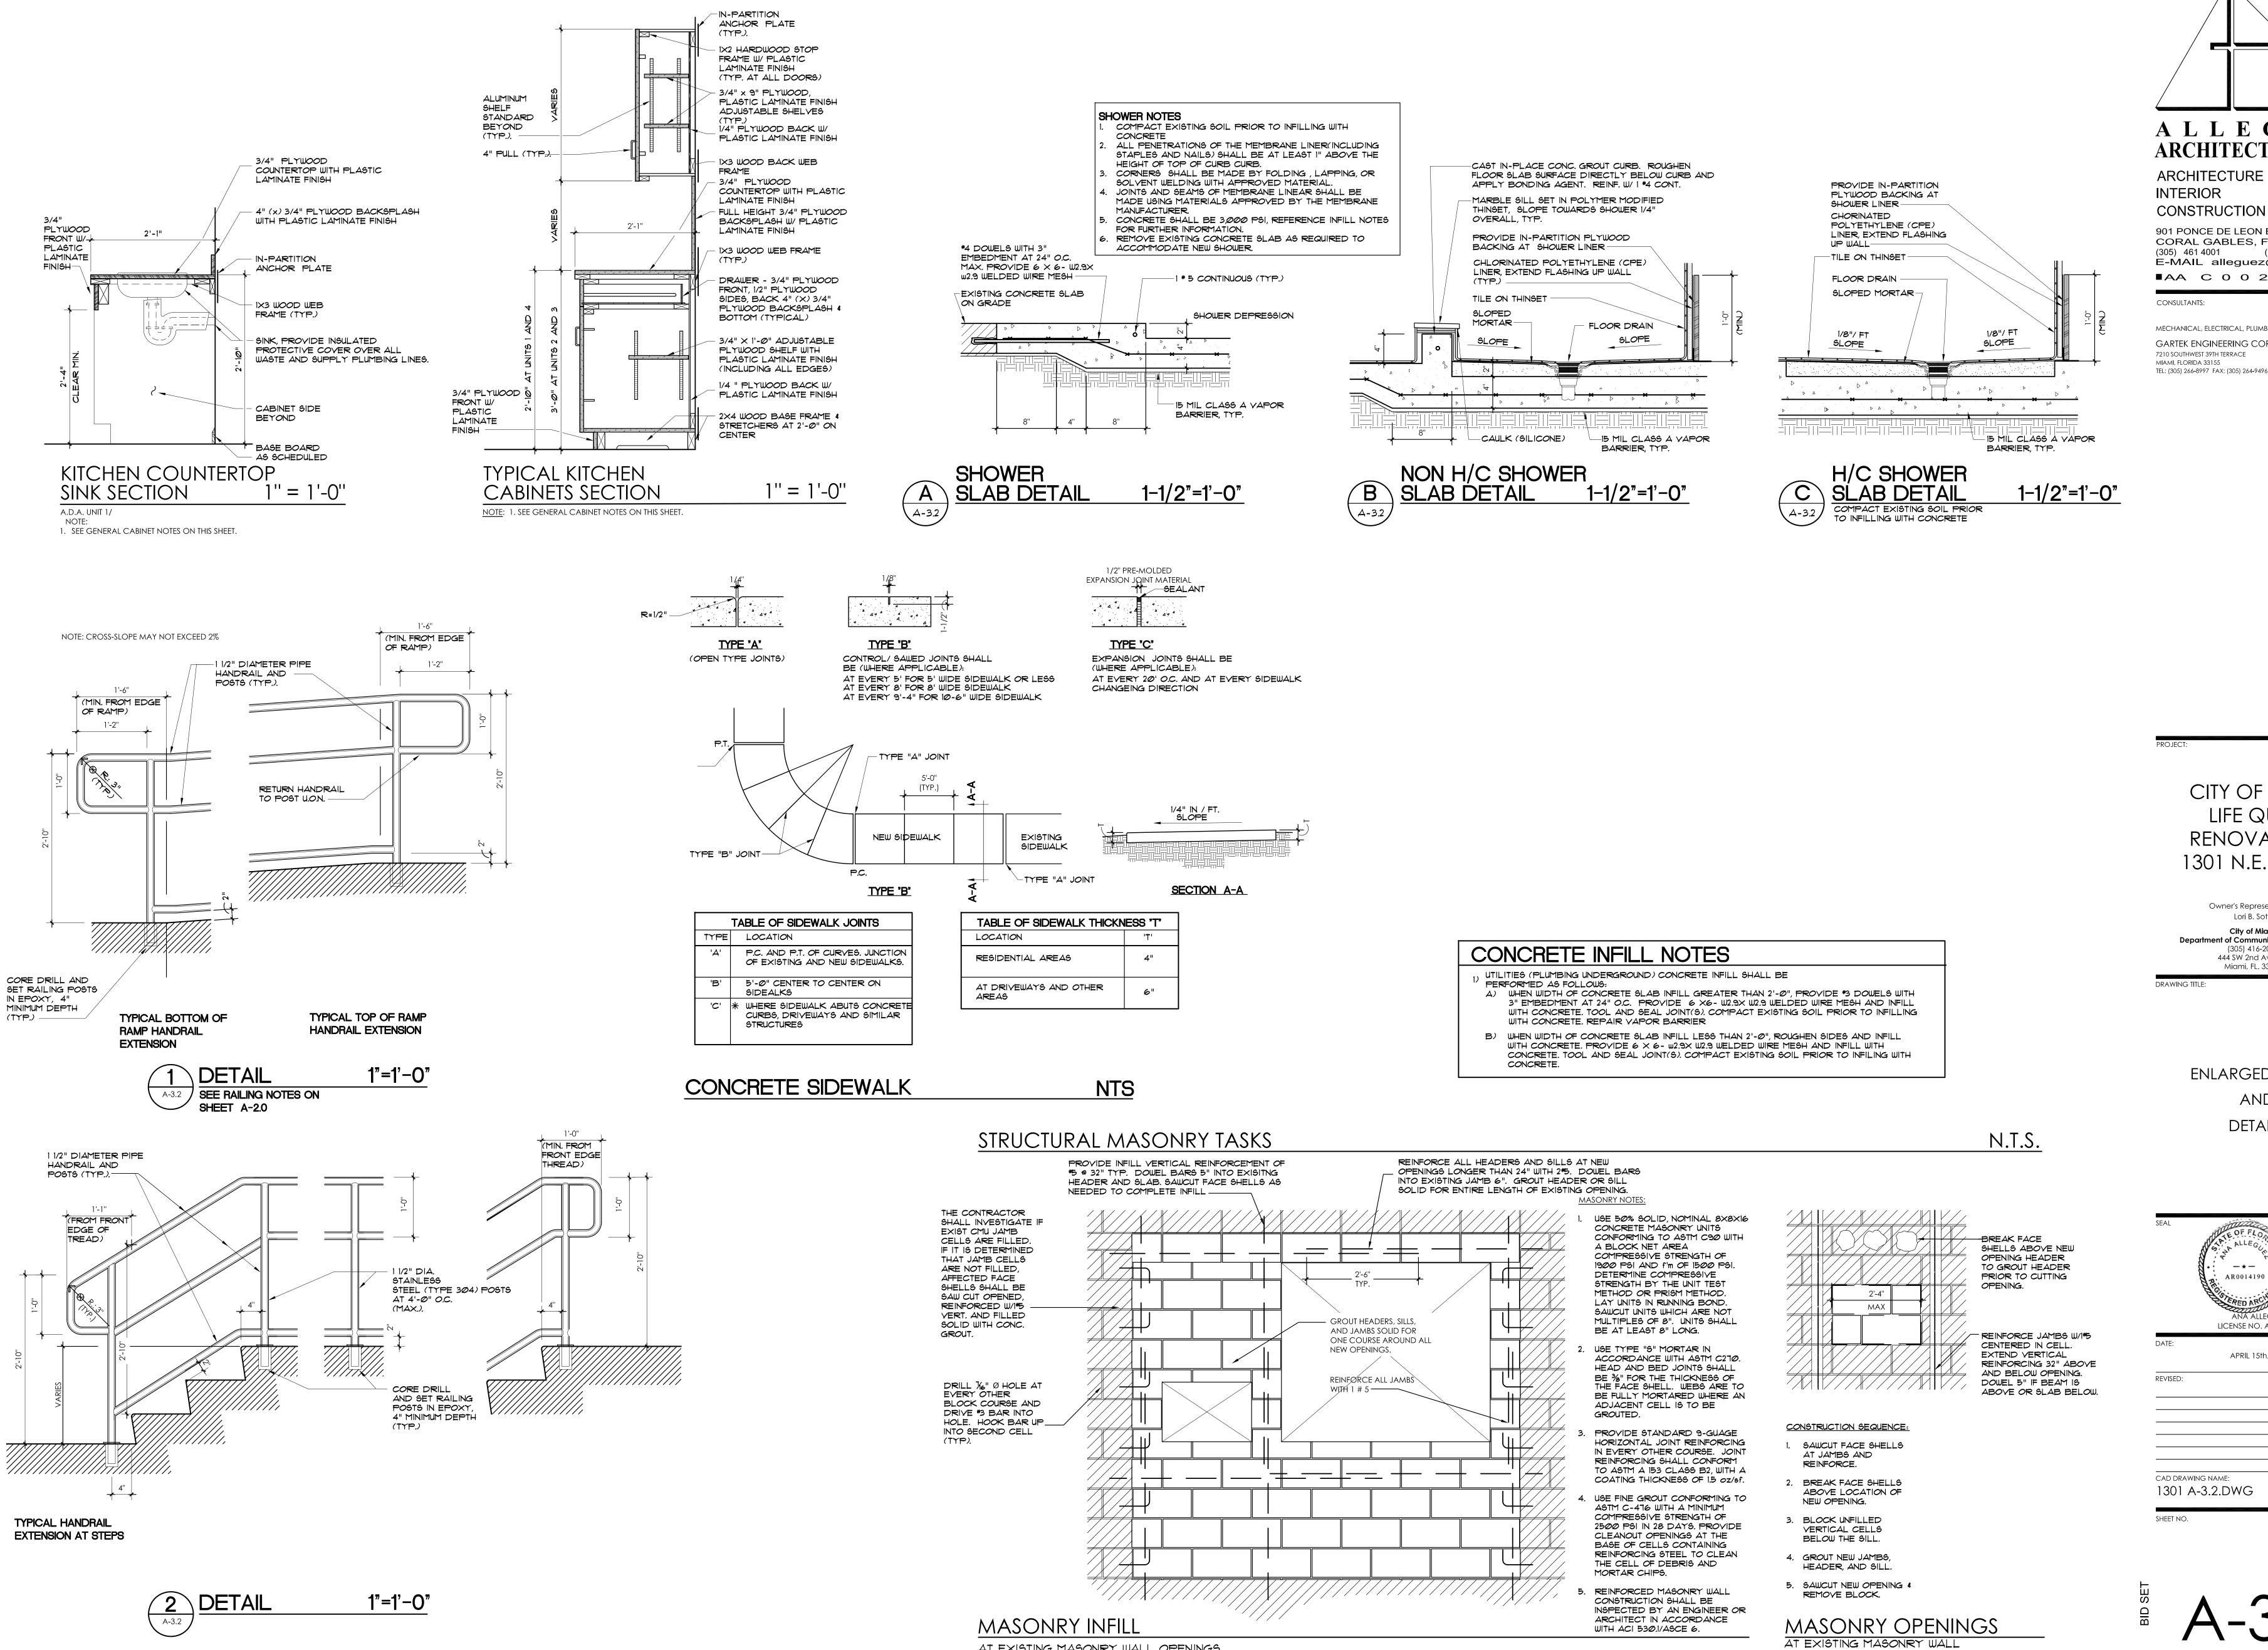

AT EXISTING MASONRY WALL OPENINGS

ALLEGUEZ

ARCHITECTURE, INC.

ARCHITECTURE PLANNING DESIGN INTERIOR **CONSTRUCTION MANAGEMENT**

901 PONCE DE LEON BLVD., SUITE 202 CORAL GABLES, FLORIDA 33134 (305) 461 4001 (FAX) 461 6002 E-MAIL alleguez@bellsouth.net ■AA C 0 0 2 7 4 6 ■

CONSULTANTS:

MECHANICAL, ELECTRICAL, PLUMBING ENGINEER: GARTEK ENGINEERING CORP. 7210 SOUTHWEST 39TH TERRACE MIAMI, FLORIDA 33155

CITY OF MIAMI LIFE QUEST RENOVATIONS 1301 N.E. 111 ST.

Owner's Representative: Lori B. Soto City of Miami Department of Community Development (305) 416-2084

444 SW 2nd Avenue

Miami, FL. 33130

DRAWING TITLE:

ENLARGED PLANS AND


DETAILS

-- * --AR0014190 LICENSE NO. AR14190


APRIL 15th, 2015

CAD DRAWING NAME: 1301 A-3.2.DWG


SHEET NO.

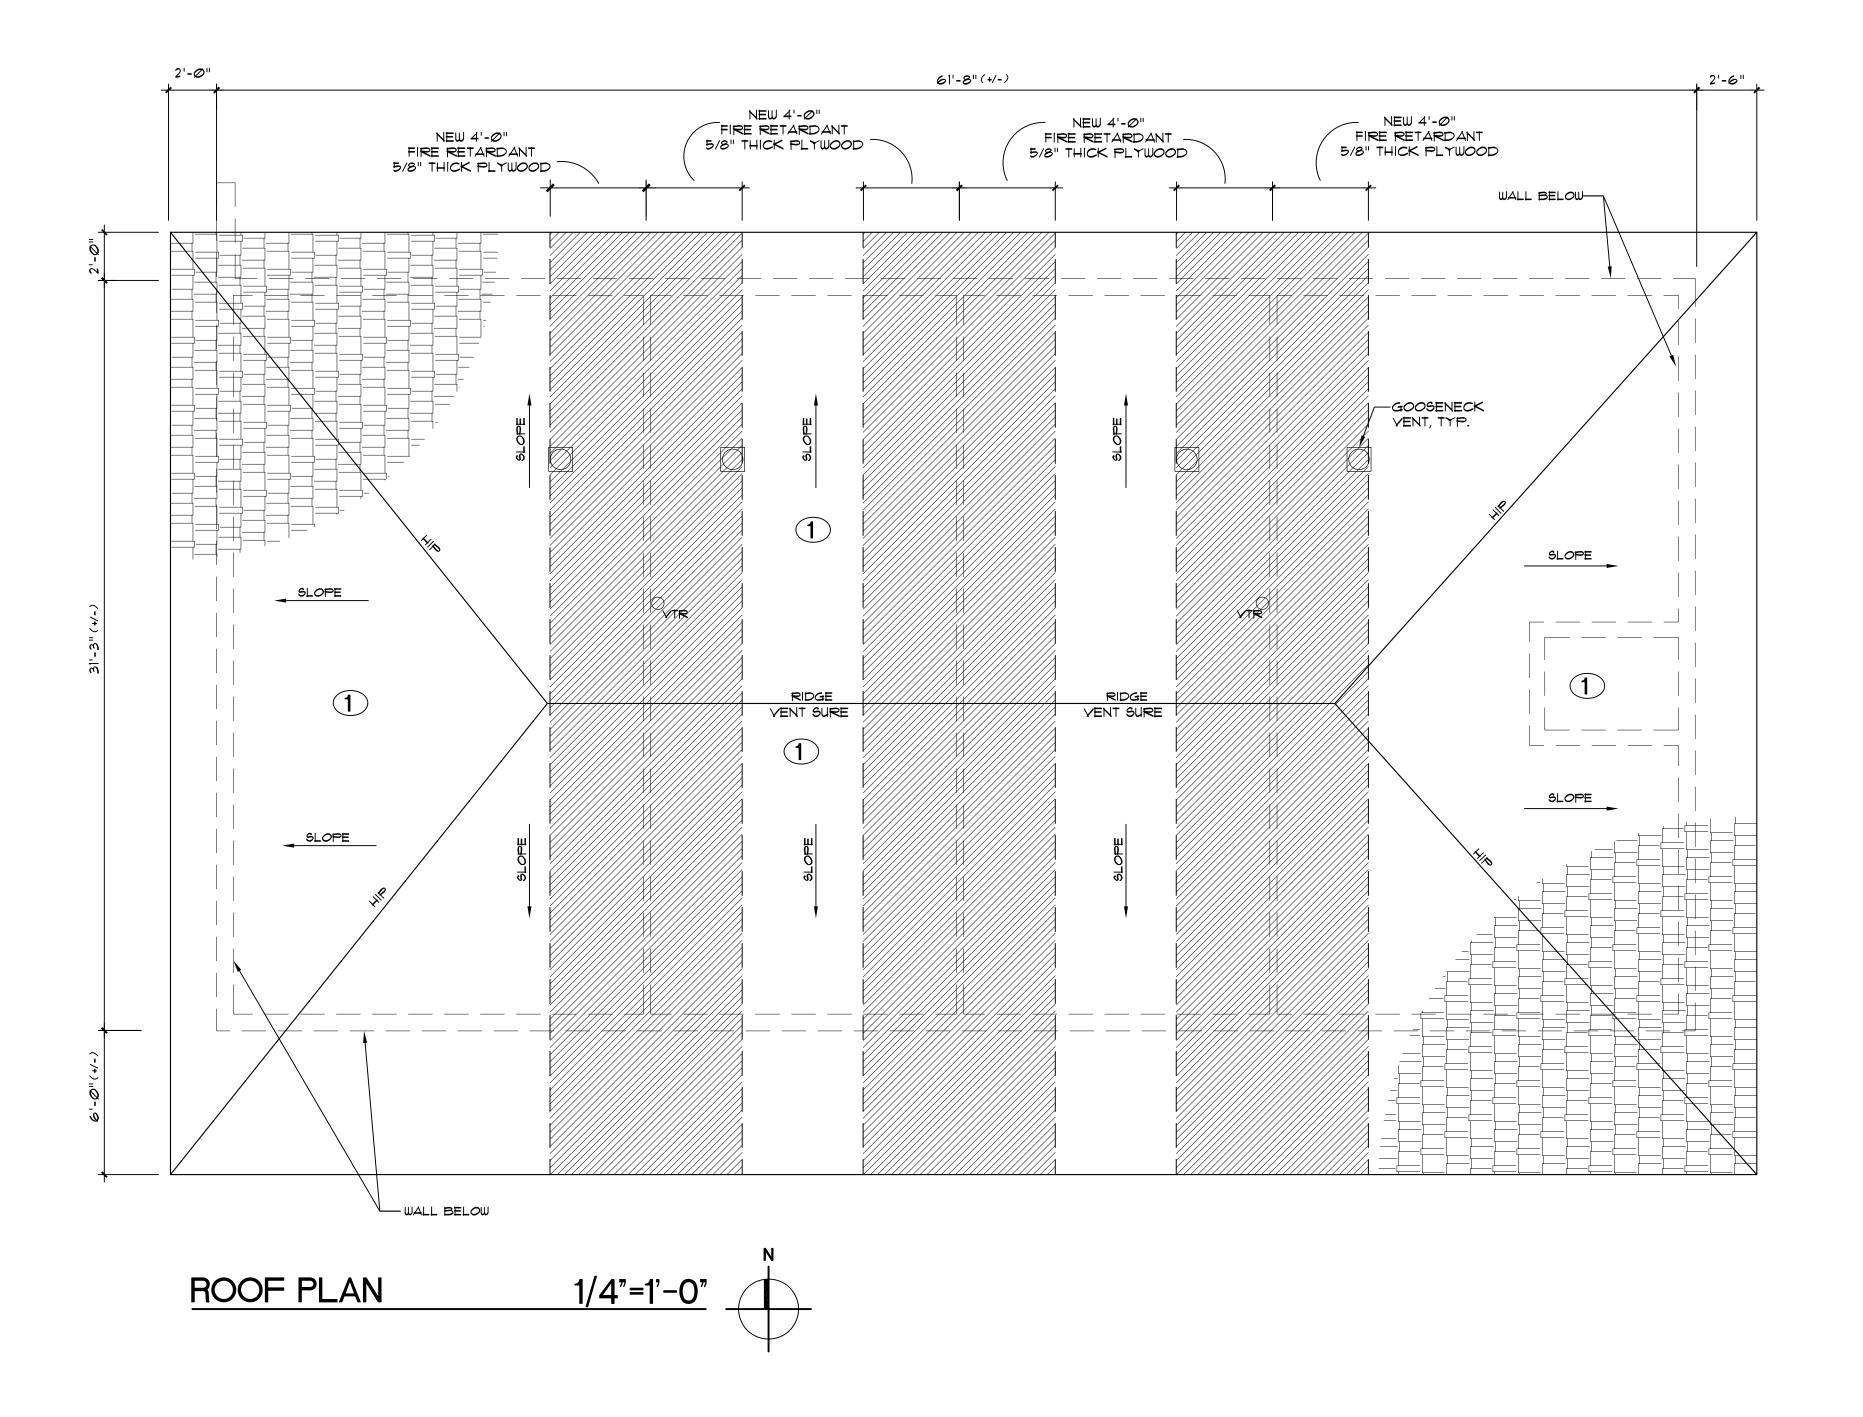



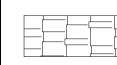

FIBERGLASS FOUR TAB ASPHALT SHINGLES

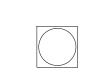

GOOSENECK VENT



ATTIC OFF-RIDGE VENT (SEE DETAILS ON SOFFIT A-4.1

O YTR VENT THROUGH ROOF

ROOF SYSTEM

(1) FIBERGLASS REINFORCED FOUR TAB ASPHALT SHINGLE ROOFING SYSTEM

> DECK TYPE: EXISTING WOOD PLANK OR PLYWOOD SHEATHING (SEE

UNDERLAYMENT: PRO ARMOR SYNTHETIC ROOF

UNDERLAYMENT NOA. # 14-1215.05

TRUEDEFINITION DURATION AS MANUFACTURED BY OWENS CORNING ROOFING & ASPHALT LIC., NOA. # 16-0425.01 COLOR: QUARRY GRAY

ASPHALT SHINGLE SYSTEM WARRANTY

MANUFACTURER'S WARRANTY: PROVIDE OWENS CORNING 20 YEARS PLATINUM PROTECTION ROOFING SYSTEM LIMITED WARRANTY. <u>APPLICATOR'S WARRANTY:</u> APPLICATOR SHALL PROVIDE A 2 YEARS (NO DOLLAR LIMIT) WARRANTY. SEE APPLICATOR'S WARRANTY NOTE FOR ADDITIONAL INFORMATION.

ROOFING NOTES

- CONTRACTOR SHALL OBTAIN A HIGH VELOCITY ROOFING PERMIT FROM THE GOVERNING AGENCY. ROOFING SYSTEM SHALL HAVE CURRENT MIAMI-DADE COUNTY PRODUCT APPROVAL, NOTICE OF ACCEPTANCE.
- ALL WORK SHALL BE IN ACCORDANCE WITH NRCA STEEP ROOFING MANUAL AND MANUFACTURER'S INSTALLATION REQUIREMENTS. CONTRACTOR SHALL RE-NAIL WOOD DECK IN
- ACCORDANCE WITH THE CURRENT PROVISIONS OF CHAPTER 15 (HIGH VELOCITY HURRICANE ZONES) OF THE FLORIDA BUILDING CODE.
- ROOFING SYSTEMS NOTED WITHIN ARE FOR BASIS AND DESIGN AND ARE SPECIFIED TO ESTABLISH PROJECT STANDARDS.
- . ROOFER MUST BE AN OWENS CORNING ROOFING PLATINUM PREFERRED CONTRACTOR.
- MANUFACTURER SHALL INSPECT ROOFING INSTALLATION AS REQUIRED TO SATISFY WARRANTY TERMS.


SHOP DRAWING SUBMITTAL

SUBMIT SHOP DRAWINGS FOR ARCHITECT'S APPROVAL PRIOR TO ORDERING ROOFING SYSTEMS. SHOP DRAWINGS SHALL INCLUDE AT A MINIMUM THE

- FOLLOWING: A. PRODUCT DATA: PROVIDE MANUFACTURER'S INFORMATION ON MEMBRANE MATERIALS, BASE FLASHING, MATERIAL AND INSULATION INCLUDING
- . CALCULATIONS: MANUFACTURER SHALL PROVIDE WIND-UP LIFT DESIGN CRITERIA PER THE FLORIDA BUILDING CODE AND ASCE-7-98. INFORMATION SHALL BE PREPARED AND CERTIFIED BY A FLORIDA LICENSED PROFESSIONAL ENGINEER.
- MANUFACTURER'S CERTIFICATE: CERTIFY THAT PRODUCTS MEET OR EXCEED SPECIFIED
- REQUIREMENTS . SUPPLY FLORIDA PRODUCT APPROVAL OR MIAMI DADE PRODUCT APPROVAL NOTICE OF ACCEPTANCE (N.O.A.) APPROVAL FOR SELECTED SYSTEM.
- E. MATERIAL SAFETY DATA SHEETS: PROVIDE MSDS FOR ALL ROOFING PRODUCTS SUBMITTED.

APPLICATOR'S WARRANTY NOTE:

THE ROOFING CONTRACTOR SHALL FURNISH WRITTEN WARRANTIES FOR A PERIOD OF TWO (2) YEARS FROM THE DATE OF PROJECT SUBSTANTIAL COMPLETION. THE ROOFER SHALL CERTIFY IN WRITING THAT SYSTEM HAS BEEN INSTALLED PER MANUFACTURER'S INSTALLATION INSTRUCTION/ N.O.A. AND WHEREAS ROOFING CONTRACTOR HAS CONTRACTED (EITHER DIRECTLY WITH OWNER OR INDIRECTLY AS A SUBCONTRACTOR) TO WARRANT SAID WORK AGAINST LEAKS, FAULTY OR DEFECTIVE MATERIALS, ROOFING COMPONENTS DEEMED FAULTY OR IN DISREPAIR, AND WORKMANSHIP FOR THE DESIGNATED WARRANTY PERIOD. DURING THE WARRANTY PERIOD THE CONTRACTOR WILL AT HIS/ HER OWN EXPENSE, MAKE OR CAUSE TO BE MADE SUCH REPAIRS TO OR REPLACEMENTS OF SAID WORK AS ARE NECESSARY TO CORRECT FAULTY AND DEFECTIVE WORK, AND AS ARE NECESSARY TO MAINTAIN SAID WORK IN WATERTIGHT CONDITION. ROOFING CONTRACTOR SHALL BE AN APPROVED SYSTEM MANUFACTURER APPLICATOR.

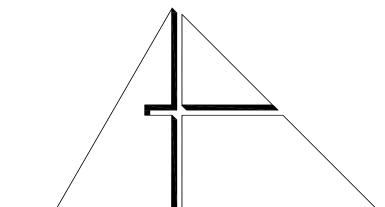

ALLEGUEZ

ARCHITECTURE, INC. ARCHITECTURE PLANNING

DESIGN

CONSTRUCTION MANAGEMENT 901 PONCE DE LEON BLVD., SUITE 202 CORAL GABLES, FLORIDA 33134 (305) 461 4001 (FAX) 461 6002 E-MAIL alleguez@bellsouth.net ■AA C 0 0 2 7 4 6 ■

CONSULTANTS:

INTERIOR

MECHANICAL, ELECTRICAL, PLUMBING ENGINEER: GARTEK ENGINEERING CORP. 7210 SOUTHWEST 39TH TERRACE MIAMI, FLORIDA 33155 TEL: (305) 266-8997 FAX: (305) 264-9496

> CITY OF MIAMI LIFE QUEST RENOVATIONS 1301 N.E. 111 ST.

> > Owner's Representative: Lori B. Soto


City of Miami **Department of Community Development** (305) 416-2084 444 SW 2nd Avenue

Miami, FL. 33130

DRAWING TITLE:

ROOF


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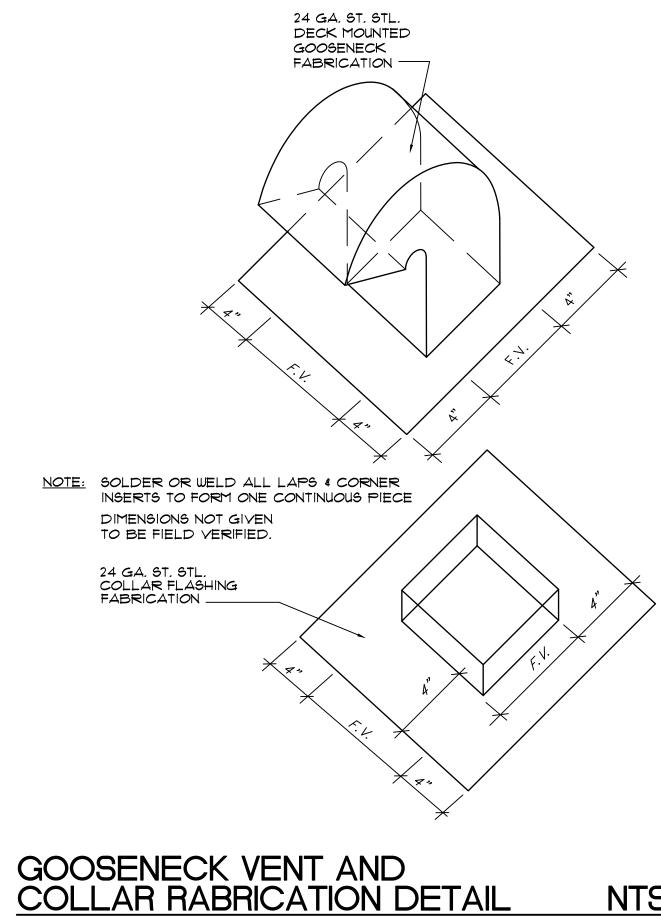


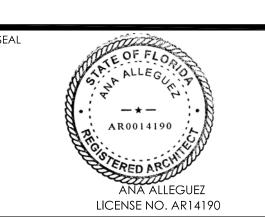
DATE:

APRIL 15th, 2015 REVISED:


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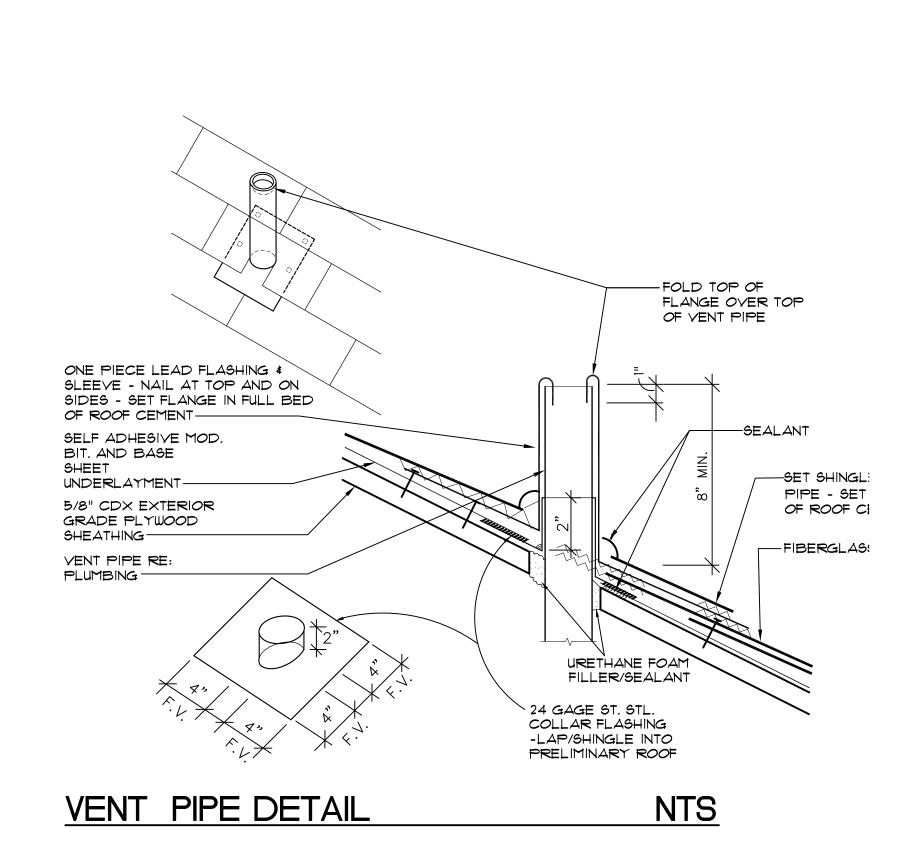





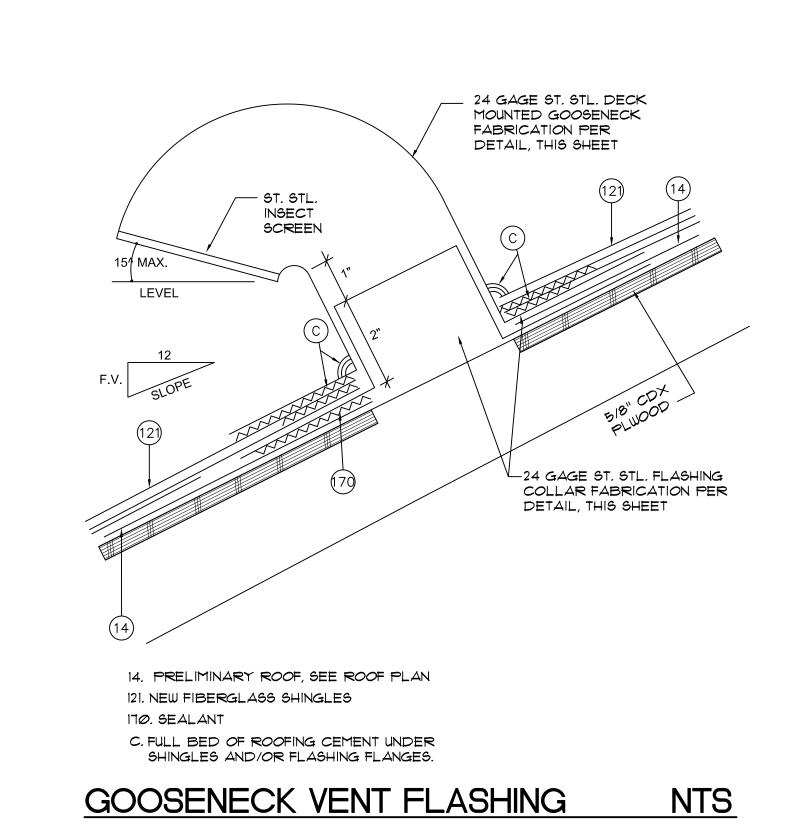

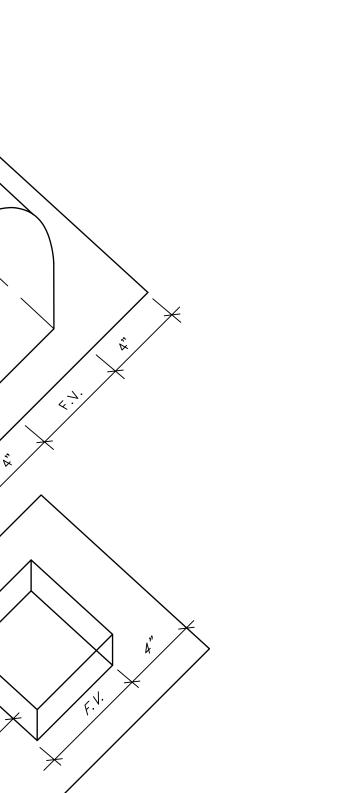
NTS



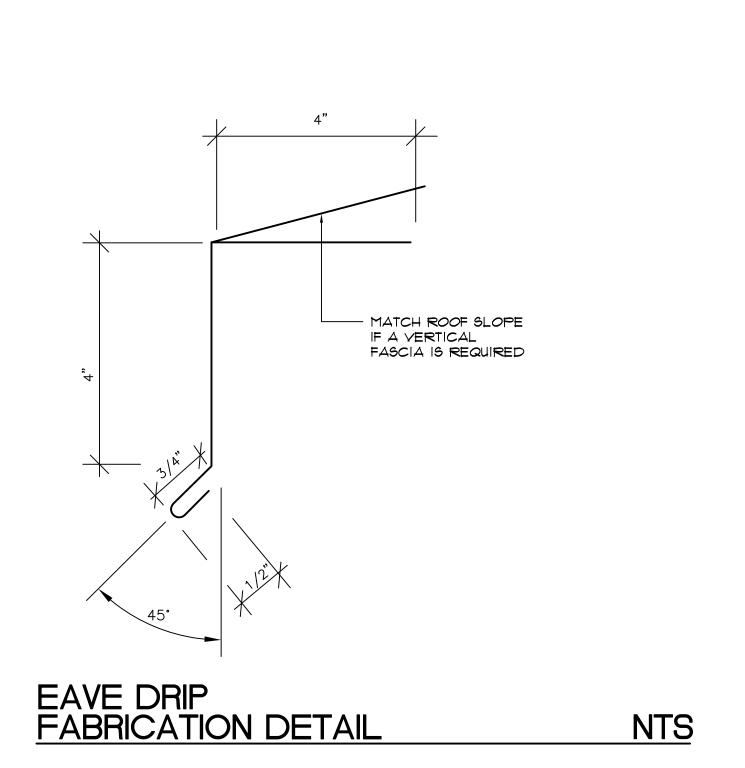

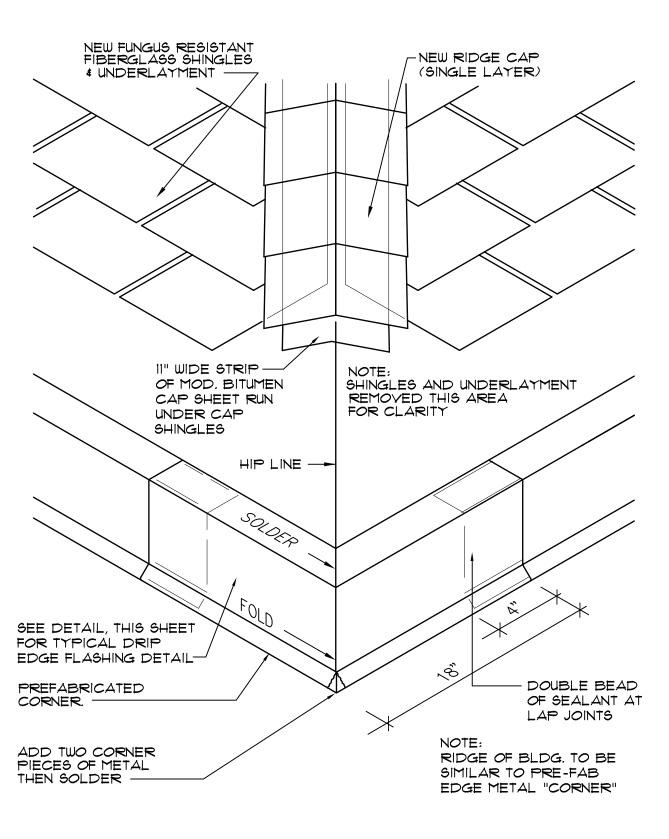



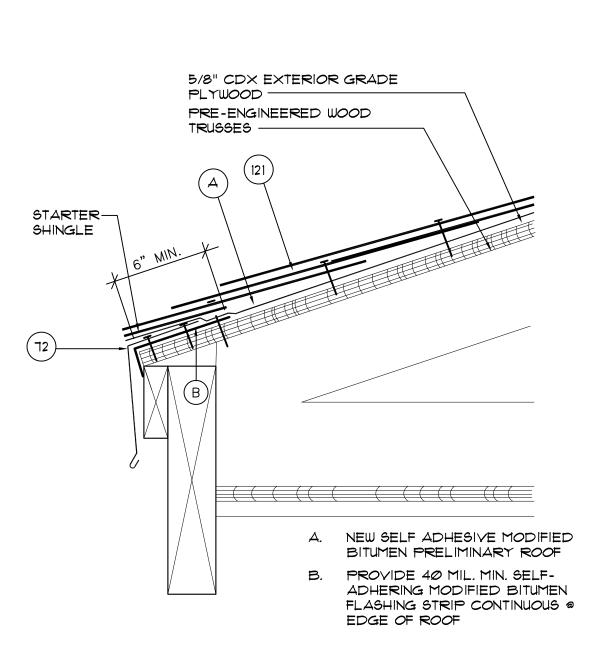

72. EDGE METAL - SEE DETAIL, THIS SHEET. 121. FUNGUS RESISTANT FIBERGLASS SHINGLES NOTE: FASTENERS FOR EDGE METAL TO BE 1-1/4" RING SHANK ST STL ROOFING NAIL AT 4" O.C. (2 ROWS STAGGERED AT 3/4" FROM EDGE OF FLANGE)

DRIP EDGE FLASHING NTS

CITY OF MIAMI LIFE QUEST RENOVATIONS 1301 N.E. 111 ST.

A L L E G U E Z

ARCHITECTURE, INC.

ARCHITECTURE PLANNING

CONSTRUCTION MANAGEMENT

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(305) 461 4001 (FAX) 461 6002 E-MAIL alleguez@bellsouth.net ■AA C 0 0 2 7 4 6 ■

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GARTEK ENGINEERING CORP.

TEL: (305) 266-8997 FAX: (305) 264-9496

7210 SOUTHWEST 39TH TERRACE

MIAMI, FLORIDA 33155

DESIGN


INTERIOR

CONSULTANTS:

Owner's Representative: Lori B. Soto

City of Miami **Department of Community Development** (305) 416-2084 444 SW 2nd Avenue Miami, FL. 33130

ROOF DETAILS

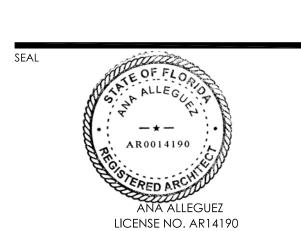


APRIL 15th, 2015

REVISED:

CAD DRAWING NAME:

1301 A-4.1.DWG

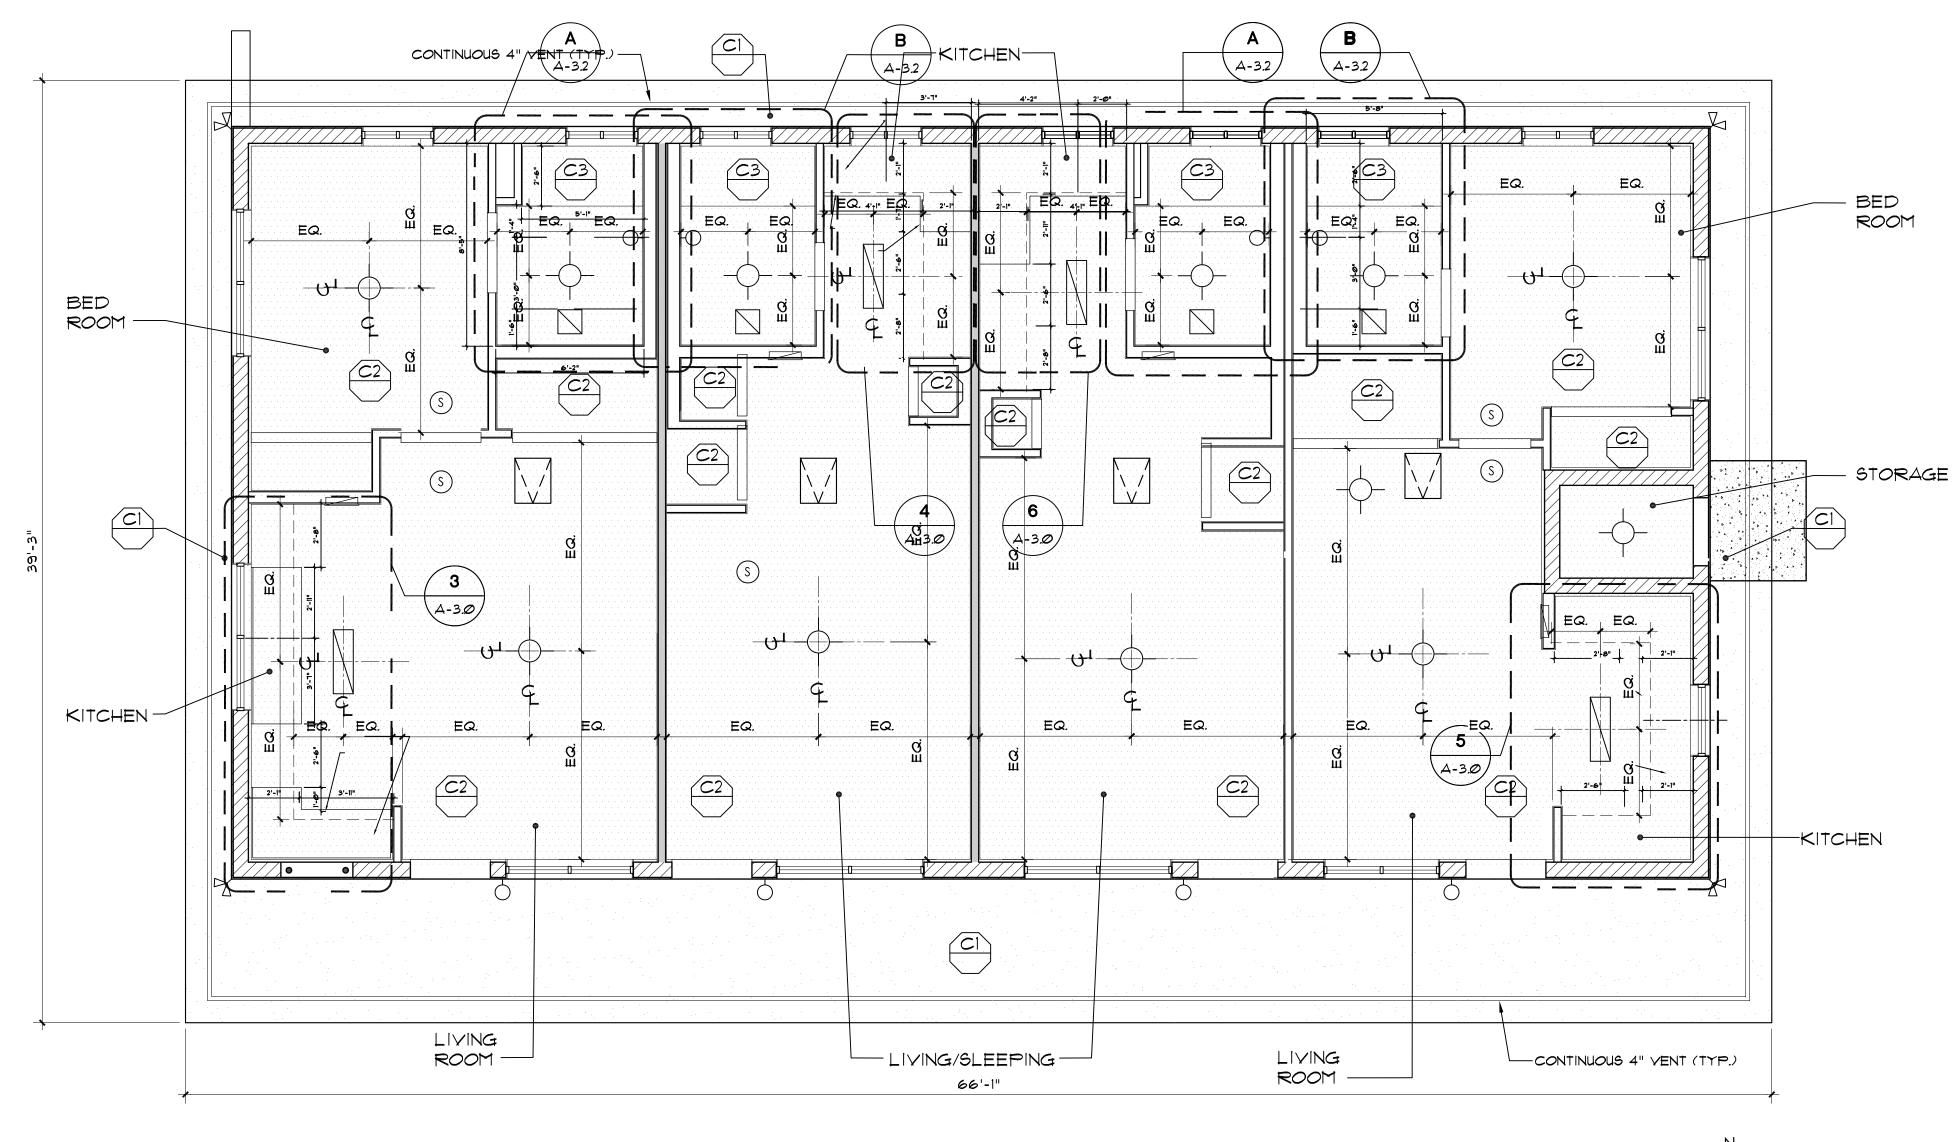

DRYWALL CEILING

PLASTER/STUCCO

BATHROOM EXHAUST

REFLECTED CEILING PLAN


NOTE(6): 1. PROVIDE R-30 BATT INSULATION ABOVE CEILING (ALL ROOMS/AREAS.)

SCALE 1/4'' = 1'

SIZE: 22"×30" (FITS INTO 22 1/2" × 30 1/2" ROUGH OPENING

NOTE: ATTIC ACCESS DOOR SHALL BE PROVIDED WITH

4-POINT LOCKING LATCH \$ HANDLES

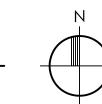

SYMBOL LEGEND CEILING LEGEND STUCCO (PRIME & PAINT) OVER GALVANIZED METAL LATH ON 15-LB ROOFING FELT OVER 1/2" CDX PLYWOOD SHEATHING OVER EXISTING WOOD TRUSSES CEILING MOUNTED LIGHT CEILING MOUNTED LIGHT 5/8" GYPSUM WALL BOARD (PRIME & PAINT) OVER 7/8" METAL FURRING CHANNELS AT 1'-4" O.C. MECHANICALLY FASTENED TO UNDERSIDE OF TRUSSES. EXHAUST FAN WALL MOUNTED LIGHT 5/8" MOISTURE RESISTANT GYPSUM BOARD (PRIME & PAINT) OVER 7/8" METAL FURRING CHANNELS AT 1'-4" O.C. MECHANICALLY FASTENED TO UNDERSIDE OF TRUSSES. WALL MOUNTED LIGHT SMOKE DETECTOR ATTIC ACCESS SPECIFICATION ATTIC DOOR MANUFACTURED: BATTIC DOOR ENERGY CONSERVATION PRODUCTS OR APPROVED EQUIVALENT. MODEL: DELUXE E-2 HATCH ATTIC ACCESS SCUTTLE DOOR

A L L E G U E Z ARCHITECTURE, INC. ARCHITECTURE PLANNING INTERIOR DESIGN CONSTRUCTION MANAGEMENT

901 PONCE DE LEON BLVD., SUITE 202 CORAL GABLES, FLORIDA 33134 (305) 461 4001 (FAX) 461 6002 E-MAIL alleguez@bellsouth.net ■AA C 0 0 2 7 4 6 ■

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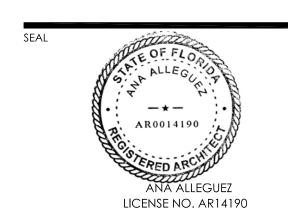
> CITY OF MIAMI LIFE QUEST RENOVATIONS 1301 N.E. 111 ST.

> > Owner's Representative: Lori B. Soto

City of Miami Department of Community Development (305) 416-2084 444 SW 2nd Avenue Miami, FL. 33130

DRAWING TITLE:

REFLECTED CEILING PLAN



APRIL 15th, 2015 REVISED:

CAD DRAWING NAME: 1301 A-5.0.DWG

PLUMBING GENERAL NOTES

- A. UNLESS OTHERWISE SPECIFIED ON THIS DRAWING CONTRACTOR SHALL REFER TO ORIGINAL LANDLORD SPECIFICATIONS FOR ALL APPLICABLE REQUIREMENTS, NOTES, DETAILS, CONSTRUCTION'S STANDARDS, ETC., COORDINATE WITH LANDLORD REQUIREMENTS PRIOR TO ORDERING AND/OR INSTALLATION OF ANY EQUIPMENT AND ACCESSORIES SHOWN.
- 1. THE WORK THAT IS TO BE DONE UNDER THIS HEADING INCLUDES THE FURNISHING OF ALL LABOR, MATERIALS AND EQUIPMENT PERMITS, FEES, INSPECTIONS, TEST, INSURANCE, ETC., REQUIRED FOR THE COMPLETION OF THE PLUMBING SYSTEM SHOWN ON DRAWINGS OR LISTED BELOW.
- . CONTRACTOR SHALL VERIFY THE EXACT LOCATION OF EXISTING PIPES BEFORE COMMENCING TO WORK AND MAKE MODIFICATIONS AS REQUIRED WITHOUT ADDITIONAL COST TO THE OWNER.
- 3. ALL PIPING SHALL BE INSTALLED RECESSED IN CHASES, FURRING
- OR PARTITIONS. 4. EXISTING PIPES SERVING AREAS NOT COVERED BY THIS CONTRACT BUT IN SERVICE AT THIS TIME SHALL NOT BE INTERRUPTED EXCEPT AS A

TEMPORARY INTERRUPTION COORDINATED WITH THE OWNER AND LANDLORD.

- 5. PLUMBING CONTRACTOR SHALL PAY ALL FEES, INSPECTION AND CONNECTION CHARGES REQUIRED.
- 6. PLUMBING CONTRACTOR SHALL VERIFY ALL SPACE CONDITIONS AND DIMENSIONS AT JOB SITE PRIOR TO FABRICATION AND INSTALLATION OF MATERIALS AND EQUIPMENT.
- 7. COORDINATE ALL WORK WITH OTHER TRADES.
- 8. PLUMBING CONTRACTOR SHALL GUARANTEE ALL WORK FREE OF DEFECTS IN MATERIALS AND WORKMANSHIP FOR A PERIOD OF ONE YEAR FROM DATE OF ACCEPTANCE.
- 9. PROVIDE SHOCK ABSORBERS SIZE, QUANTITY AND LOCATION AS PER P.D.I. STANDARDS.
- 10. PROVIDE SHUT-OFF VALVE FOR EACH GROUP OF FIXTURE AND EACH FIXTURE SUPPLY. WATER DISTRIBUTION VALVES 2" AND SMALLER VALVES ARE TO BE TEFLON SEATED, BRONZE BODY, FULL PORT BALL VALVES. 11. WHEREVER DISSIMILAR METALS ARE TO BE JOINED, A DIELECTRIC
- FITTING SHALL BE PROVIDED TO CONNECT BOTH TYPES OF PIPES. 12. CONTRACTOR SHALL BE RESPONSIBLE TO COORDINATE ALL ROUGH-INS WITH THE MANUFACTURER BEFORE MAKING ANY INSTALLATION.
- 13. POTABLE HOT AND COLD WATER SYSTEMS SHALL BE "LEAD FREE" WITH LEAD CONTENT NOT EXCEEDING 0.2 PERCENT FOR SOLDER AND FLUXES AND 8 PERCENT FOR PIPE FITTINGS, FIXTURES AND TRIM. CONTRACTOR SHALL VERIFY MANUFACTURER'S COMPLIANCE.
- 14. ALL POTABLE HOT AND COLD WATER SYSTEMS SHALL BE FLUSHED CLEAR, STERILIZED WITH AN APPROVED SOLUTION AND THROUGHLY FLUSHED OF ALL RESIDUAL SOLUTION AFTER FINAL PRESSURE TESTS AND WITH ALL TRIM AND CONNECTIONS INSTALLED.
- 15. PROVIDE SHUT-OFF AND VACUUM BREAKER TO ALL HOSE BIBBS AND FAUCETS WITH HOSE-END CONNECTIONS. ALL EXTERIOR HOSE BIBS ARE TAMPER
- 16. ALL FLOOR DRAINS SHALL HAVE TRAP PRIMERS TO PROTECT THE SEAL OF
- 17. PVC PIPING IS NOT ALLOWED IN RETURN AIR PLENUMS. IF RETURN AIR PLENUMS ARE USED, CONTRACTOR SHALL REPLACE ALL EXISTING PVC PIPING WITH CAST IRON OR COPPER PIPING.
- 18. DRAINAGE SYSTEM DESIGN IS BASED ON 1/8" PER FOOT MINIMUM FALL FOR PIPES 3" OR LARGER AND 1/4" PÉR FOOT MINIMUM FALL FOR PIPES 2" OR SMALLER, ANY DEVIATIONS SHALL BE APPROVED BY ARCHITECT/ENGINEER.
- 19. ALL VENT THROUGH ROOF OPENINGS SHALL BE OFFSETED TO A MINIMUM DISTANCE OF 3'-0" FROM PARAPET WALL OR ROOF EDGE. SEE ARCHITECTURAL DRAWINGS FOR ROOF FLASHING. LEAD FLASHING WILL NOT BE ACCEPTED. 20. COORDINATE SCHEDULING OF ALL REQUIRED INSPECTIONS WITH APPROPRIATE
- REGULATORY BODIES. 21. ALL FIRE RATED WALL PENETRATIONS SHALL BE PROTECTED WITH A UL APPROVED -FIRE-STORPING ASSEMBLY-SYSTEM:-
- 22. CONDENSATE DRYWELL SHALL BE LOCATED MINIMUM 1 FOOT AWAY FROM THE STRUCTURE SIDEWALL, CONTRACTOR TO COORDINATE EXACT LOCATION IN FIELD.

ALL PLUMBING FIXTURES SHALL COMPLY WITH TABLE 604.4 FBC — PLUMBING FOR " MAXIMUN FLOW RATES AND CONSUMPTION FOR PLUMBING FIXTURES AND FIXTURE FITTINGS"

PLUMBING DEMOLITION NOTES

1. SITE INVESTIGATION:

- EXAMINATION OF CONTRACT DOCUMENTS AND SITE OF WORK; THE CONTRACTOR AND SUBCONTRACTOR IS REQUIRED, BEFORE SUBMITTING HIS/HER PROPOSAL, TO VISIT THE SITE OF THE PROPOSED WORK AND FAMILIARIZE HIMSELF/HERSELF WITH THE NATURE AND EXTENT OF THE WORK AND ANY LOCAL CONDITIONS THAT MAY IN ANY MANNER AFFECT THE WORK TO BE DONE AND EQUIPMENT, MATERIALS AND LABOR REQUIRED THEREFOR, SINCE THE WORK INVOLVES EXISTING BUILDINGS, SYSTEMS AND FACILITIES, SPECIAL CONSIDERATION SHALL BE GIVEN TO EXAMINATION OF WORKING CONDITIONS, EXISTING FACILITIES AND ALL BUILDING STRUCTURES TO FAMILIARIZE HIMSELF/HERSELF WITH ALL EXISTING CONDITIONS. SLIGHT VARIATION OF ROUTING AND OR CONSTRUCTIONS SHOULD BE ANTICIPATED BY THIS CONTRACTOR TO AVOID CONFLICTS WITH OTHER TRADES ARE EXPRESSLY INCLUDED AS PART OF THE WORK WHENEVER REQUIRED AT NO ADDITIONAL COST TO THE OWNER. IGNORANCE ON THE PART OF THE CONTRACTOR WILL IN NO WAY RELIEVE HIM/HER OF THE OBLIGATIONS AND RESPONSIBILITIES ASSUMED UNDER THIS CONTRACT.
- 2. THE NATURE OF THE REMODEL TYPE CONSTRUCTION POSES SPECIAL PROBLEMS FOR THE DESIGNER ENGINEERS AS WELL AS THE PLUMBING CONTRACTOR. EVERY EFFORT HAS BEEN MADE BY THE ENGINEERS TO SHOW AND VERIFY, WHERE POSSIBLE, THE LOCATION OF THE EXISTING PLUMBING SYSTEMS. THE MAJOR PORTION OF THE PLUMBING SYSTEMS ARE AS SHOWN ON THE DRAWINGS: HOWEVER MINOR DEVIATIONS MAY BECOME EVIDENT AS THE JOB PROGRESSES. NO ADVANTAGE IS TO BE TAKEN BY THE PLUMBING CONTRACTOR BECAUSE THESE MINOR DIFFERENCES. PLUMBING CONTRACTOR SHALL PERFORM A FIELD VERIFICATION BEFORE BIDDING THIS PROJECT.
- CONTRACTOR WILL BE RESPONSIBLE FOR COORDINATING HIS/HER DEMOLITION WORK WITH OTHER TRADES, AND TO PROTECT FROM DAMAGE EXISTING PIPES USED FOR FUTURE CONNECTIONS.
- 4. CONTRACTOR SHALL FIELD VERIFY THE EXACT LOCATION, DEPTH AND CONDITION OF ALL EXISTING PIPES, IN EACH UNIT, INCLUDING THROUGH THE USE OF VIDEO INSPECTION. ANY AND ALL DEFICIENCIES ENCOUNTERED THAT MAY NEGATIVELY IMPACT THE PLUMBING DESIGN. RESULTING IN ADDITIONAL CONSTRUCTION COSTS. SHALL BE BROUGHT TO THE IMMEDIATE ATTENTION OF A.E. FOR CONSIDERATION AND APPROVAL PRIOR TO SUCH TASKS BEING PERFORMED.
- 5. EXISTING PIPES SERVING AREAS NOT COVER BY THIS CONTRACT BUT IN SERVICE AT THIS TIME SHALL NOT BE INTERRUPTED UNLESS IT IS A TEMPORARY INTERRUPTION COORDINATED WITH THE OWNER.
- 6. PLUMBING CONTRACTOR SHALL CAP ALL UNUSED DRAINAGE SYSTEMS BELOW FINISHED FLOOR AND REMOVE ALL UNUSED PORTIONS ABOVE GROUND AND ALL ASSOCIATED ACCESSORIES AND TRIMS.
- PLUMBING CONTRACTOR SHALL CAP ALL UNUSED DOMESTIC HOT AND COLD WATER LINES AT BRANCH VALVES FROM MAIN DISTRIBUTION LINES AND REMOVE ALL UNUSED PIPING, HANGERS AND ACCESSORIES.
- 8. ALL CAPPED PLUMBING LINES SHALL BE INSPECTED PRIOR TO COVERING

PLUMBING SPECIFICATION

GENERAL:

MATERIAL SHALL BE NEW, UNUSED, BEST OF THEIR RESPECTIVE KINDS AND FREE FROM DEFECTS IN WORKMANSHIP; IN CONFORMANCE WITH THE LATEST PUBLICATIONS IN FORCE AT TIME OF BIDDING.

- 2. PIPE AND FITTINGS:
- A. SANITARY SOIL AND VENT PIPING: SERVICE WEIGHT CAST IRON BELL AND SPIGOT PIPE AND FITTINGS, ASTM.A74— LATEST EDITION, NO HUB CAST IRON PIPE AND FITTINGS, CISPI. 301—LATEST EDITION, PIPE AND FITTINGS SHALL BE MARKED WITH THE COLLECTIVE TRADEMARK OF THE CAST IRON SOIL PIPE INSTITUTE, OD DWV. COPPER PIPE WITH CAST BRASS OR WROUGHT COPPER SOLDER JOINT FITTINGS, ASTM. B306-79, (ABOVE GROUND). VENTING AS HEREIN BEFORE SPECIFIED OR GALVANIZED THREADED STEEL WITH MALLEABLE IRON FITTINGS.
- B. DOMESTIC WATER SUPPLY PIPING: COPPER PIPE TYPE 'L' WITH BRONZE OR WROUGHT COPPER SOLDER JOINT FITTINGS, ASTM.B88-78. . CONDENSATE PIPING: AS HEREIN BEFORE SPECIFIED FOR SANITARY SOIL, WASTE AND VENT PIPING.
- A. SANITARY SOIL/ STORM DRAINAGE BELOW GROUND: SCHEDULE 40 SOLID PLASTIC PVC PIPE ASTM D1785.
- 3. JOINTS AND METHODS OF CONNECTION:
- A. CAST IRON BELL AND SPIGOT PIPE: COMPRESSION GASKET. INSTALL PER MANUFACTURER'S RECOMMENDATION. GASKET AND PIPE BY SAME MANUFACTURER. B. CAST IRON NO-HUB PIPE: MAKE JOINTS WITH NEOPRENE RUBBER SLEEVE
- AND STAINLESS STEEL RING CLAMP PER MANUFACTURER'S RECOMMENDATIONS. GASKET AND PIPE BY SAME MANUFACTURER.
- . DWV COPPER PIPE: JOINT WITH 95-5 TIN-ANTIMONY SOLDER, INSTALL PER MANUFACTURER'S RECOMMENDATIONS. TYPE 'L' COPPER TUBE: JOIN WITH 95-5 TIN-ANTIMONY SOLDER, INSTALL
- PER MANUFACTURER'S RECOMMENDATIONS. E. STEEL PIPE:
- a. THREADED JOINTS: AFTER CUTTING AND BEFORE THREADING, REAM ALL PIPE AND REMOVE BURRS. MAKE JOINTS WITH JOINT COMPOUND APPLIED TO MALE THREADS ONLY. b. FLANGED JOINTS: STANDARD WEIGHT, 150 P.S.I. STEEL, WITH APPROVED RED RUBBER GASKET OR NEOPRENE RUBBER GASKET, INSTALL AS PER
- . SCHEDULE 40 PVC MOLDED PREFORMED FITTINGS, PVC-DWV, SOCKET SOLVENT CEMENT, ASTM D-2467
- 4. UNIONS AND FLANGES:

MANUFACTURER'S RECOMMENDATIONS.

- A. COPPER PIPE: BRONZE UNIONS FOR 2 INCHES AND SMALLER. FOR 2-1/2INCHES AND LARGER USE BRONZE FLANGED CONNECTIONS 150 POUND CLASS. B. DIELECTRIC UNIONS OR FLANGES: UNIONS SHALL MEET DIMENSIONAL REQUIREMENTS AND TENSILE STRENGTH OF PIPE UNIONS IN ACCORDANCE WITH FED. SPEC. WW-U-531E. UNIONS OR FLANGES SHALL BE SUITABLE FOR REQUIRED OPERATING PRESSURES AND TEMPERATURE CONDITIONS. UNIONS
- SHALL HAVE METAL CONNECTIONS ON BOTH ENDS. ENDS SHALL BE THREADED OR SOLDERED TO MATCH ADJACENT PIPING. METAL PARTS OF UNION OR FLANGED SHALL BE SEPAREATED TO PREVENT CURRENT FLOW BETWEEN DISSIMILAR METALS. EPCO DIELECTRIC PIPE FITTINGS OR EQUIVALENT. ESCUTCHEONS:
- CHROME PLATED OR STAINLESS STEEL WITH SET SCREWS FOR HOLDING SECURELY IN PLACE. USE ESCUTCHEONS ON PIPES PASSING THROUGH WALLS, FLOORS AND CEILINGS OF FINISHED AREAS.
- 6. PIPE INSULATION:
- A. ALL CONDENSATE LINES SHALL BE INSULATED WITH 3/4" FIRE RETARDANT ARMAFLEX INSULATION WITH A MAXIMUM OF 25/50 FLAME SPREAD AND SMOKE DEVELOPED RESPECTIVELY.
- B. ALL HOT WATER LINES SHALL BE INSULATED WITH 1" FIRE RETARDANT ARMAFLEX INSULATION WITH A MAXIMUM OF 25/50 FLAME SPREAD AND SMOKE DEVELOPED RESPECTIVELY.
- C. ALL PLUMBING PIPES AT THE STAGE AND SEATING AREAS SHALL BE INSULATED WITH 1" FIRE RETARDANT ARMAFLEX INSULATION WITH A MAXIMUM OF 25/50 FLAME SPREAD AND SMOKE DEVELOPED RESPECTIVELY.

PLUMBING LEGEND				
— — — — V SANITARY VENT LINE — SD — SD STORM DRAIN — CD — CD CONDENSATE DRAIN LINE — P&T — PTR PRESSURE AND TEMPERATURE RELIEF LINE — G — G GAS LINE — — — CW COLD WATER LINE — ICW — ICW IRRIGATION COLD WATER LINE — — — HW HOT WATER LINE	PLUMB	F	PLUMBING LEGEND	
	— SAN		—— SAN SANITARY DRAIN	
 CD — CD CONDENSATE DRAIN LINE P&T — PRESSURE AND TEMPERATURE RELIEF LINE G G GAS LINE CW COLD WATER LINE ICW IRRIGATION COLD WATER LINE HW HOT WATER LINE 	— v		— V SANITARY VENT LINE	
P&T — PTR PRESSURE AND TEMPERATURE RELIEF LINE G G GAS LINE CW COLD WATER LINE ICW IRRIGATION COLD WATER LINE HW HOT WATER LINE	— SD	—— SD —		
G GAS LINE CW COLD WATER LINE ICW IRRIGATION COLD WATER LINE HW HOT WATER LINE	— CD	CD	CD CONDENSATE DRAIN LINE	
G GAS LINE CW COLD WATER LINE ICW IRRIGATION COLD WATER LINE HW HOT WATER LINE	— PTR	—— P&T —		LINE
— — ICW — ICW IRRIGATION COLD WATER LINE — — — — HW HOT WATER LINE		—— G —		
—— —— HW HOT WATER LINE	CW		CW COLD WATER LINE	
	— ICW	—— ICW— -	— — ICW IRRIGATION COLD WATER LINE	
——————————————————————————————————————	— НW			
THE STATE OF THE S	—— HWR		— — HWR HOT WATER RECIRCULATING LINE	
BV FULL PORT-BONZE/BRASS TEFLON SEATED BALL VALVE	BV			SEATED
CV CHECK VALVE	CV		CV CHECK VALVE	
BALANCING VALVE	<u> </u>	—— 	BALANCING VALVE	
	— VIV		VIV VALVE IN RISER	
HB HOSE BIBB W/ VACUUM BREAKER	НВ	- *	HB HOSE BIBB W/ VACUUM BREAKER	
T AC AIR CHAMBER	AC	T	AC AIR CHAMBER	
SA SHOCK ARRESTOR (P.D.I. SIZE 'A' TYPICAL UNLESS NOTED OTHERWISE.)	SA		SA SHOCK ARRESTOR (P.D.I. SIZE 'A' TYPICAL UNLESS NOTED OTHERWISE.	.)
	CO	 	CO CLEAN-OUT PLUG	
	WCO	 	WCO WALL CLEAN-OUT	
CNTE CONNECT TO EXISTING	CNTE	•	CNTE CONNECT TO EXISTING	
FD FLOOR DRAIN	FD		FD FLOOR DRAIN	
RD ROOF DRAIN	RD	_	RD ROOF DRAIN	
ORD EMERGENCY OVERFLOW ROOF DRAIN	ORD		ORD EMERGENCY OVERFLOW ROOF DRAIN	١
VTR VENT THRU ROOF AP ACCESS PANEL FOS FUEL OIL SUPPLY FOR FUEL OIL SUPPLY FOR FUEL OIL SUPPLY FOR FUEL OIL VENT CO CLEAN OUT WCO WALL CLEAN OUT FCO FLOOR CLEAN OUT CTG CLEAN OUT TO GRADE FDC FIRE DEPT. CONN. (SIAMESE) FH FIRE HYDRANT FHC FIRE HOSE CABINET FVC FIRE VALVE CABINET W/ HFV FEC FIRE EXTINGUISHER CAB. W/ FE FE FIRE EXTINGUISHER FE/CO FIRE EXT./CARBON DIOXIDE WH WATER HEATER UG UNDER GROUND DIP DUCTILE IRON PIPE CMP CORRUGATED METAL PIPE CIP CAST IRON PIPE TP TRAP PRIMER (RESEALER) A/C AIR CONDITIONER TH THERMOMETER FHV FIRE HOSE VALVE AHU AIR HANDLING UNIT CLG CEILING UG UNDERGROUND RWL RAIN WATER LEADER	AP FOS FOV CO WCO FCO CTG FHC FVC FE/CO WH UG DIP CMP CIP TH AHU CLG UG		AP ACCESS PANEL FOS FUEL OIL SUPPLY FOR FUEL OIL RETURN FOV FUEL OIL VENT CO CLEAN OUT WCO WALL CLEAN OUT FCO FLOOR CLEAN OUT CTG CLEAN OUT TO GRADE FDC FIRE DEPT. CONN. (SIAMESE) FH FIRE HYDRANT FHC FIRE HOSE CABINET FVC FIRE VALVE CABINET FVC FIRE EXTINGUISHER CAB. W/ FE FE FIRE EXTINGUISHER FE/CO FIRE EXT./CARBON DIOXIDE WH WATER HEATER UG UNDER GROUND DIP DUCTILE IRON PIPE CMP CORRUGATED METAL PIPE CIP CAST IRON PIPE TP TRAP PRIMER (RESEALER) A/C AIR CONDITIONER TH THERMOMETER FHV FIRE HOSE VALVE AHU AIR HANDLING UNIT CLG CEILING UG UNDERGROUND	

			COLD	НОТ		
SYMBOL	DESCRIPTION	DRAIN	WATER	WATER	MANUFACTURER/MODEL	TRIM
P-1	WATER CLOSET	4"	1/2"		AMERICAN STANDARD "CADET" 3 FLOWISE RIGHT HEIGHT #2835.128.020 VITREOUS CHINA, LOW CONSUMPTION, 1.28 GPF, ELONGATED SIPHON JET FLUSH ACTION 16-1/2" RIM HEIGHT.	CLOSE-COUPLED TANK, CHROME FINISH TRIP LEVER CENTOCO 820STS.001 HEAVY DUTY TOILET SEAT. FOR ELONGATED BOWL OPEN FRONT SEAT. SUPPLY: MCGUIRE BV172 TOILET SUPPLY, CHROME FINISH POLISHED BRASS WITH ESCUTCHEON AND STAINLESS STEEL BRAIDED RISER. FLOOR FLANGE WITH ALL BRASS BOLTS AND WITH RUBBER GASKET.
P-1H	WATER CLOSET (HANDICAP)	4"	1/2"		AMERICAN STANDARD "CADET" 3 FLOWISE RIGHT HEIGHT #2835.128.020 VITREOUS CHINA, LOW CONSUMPTION, 1.28 GPF, ELONGATED SIPHON JET FLUSH ACTION 16-1/2" RIM HEIGHT.	CLOSE—COUPLED TANK, CHROME FINISH TRIP LEVER CENTOCO 820STS.001 HEAVY DUTY TOILET SEAT. FOR ELONGATED BOWL OPEN FRONT SEAT. SUPPLY: MCGUIRE BV172 TOILET SUPPLY, CHROME FINISH POLISHED BRASS WITH ESCUTCHEON AND STAINLESS STEEL BRAIDED RISER. FLOOR FLANGE WITH ALL BRASS BOLTS AND WITH RUBBER GASKET.
P-2	LAVATORY	1 1/4"	1/2"	1/2"	AMERICAN STANDARD "DECLYNE "#0321.075 FOR CONCEALED ARMS SUPPORTS, WALL HUNG, 4" CENTERS, VITREOUS CHINA, REAR OVERFLOW, SOAP DEPRESSION, FAUCET LEDGE. CARRIER: WATTS TCA-411 SINGLE CARRIER	FAUCET: AMERICAN STANDARD MODEL 8115F, 4" CENTER, SINGLE LEVER FAUCET, POLISHED CHROME FINISH, SPEED CONNECT POP-UP DRAIN. DRAIN: AMERICAN STANDARD POP-UP DRAIN AND TAILPIECE DRAIN: McGUIRE #8872C POLISHED CHROME FINISHED BRASS P-TRAP WITH CLEAN OUT PLUG AND ESCUTCHEON. SUPPLY: MCGUIRE # BV170 FAUCET SUPPLY, CHROME FINISH POLISHED BRASS WITH ESCUTCHEON AND FLEXIBLE COPPER RISER.
	LAVATORY—ADA FOR ADA HEIGHT REFERS TO ARCHITECTURAL DRAWINGS	1 1/4"	1/2"	1/2"	AMERICAN STANDARD "DECLYNE "#0321.075 FOR CONCEALED ARMS SUPPORTS, WALL HUNG, 4" CENTERS, VITREOUS CHINA, REAR OVERFLOW, SOAP DEPRESSION, FAUCET LEDGE. CARRIER: WATTS TCA-411 SINGLE CARRIER	FAUCET: AMERICAN STANDARD MODEL 8115F, 4" CENTER, SINGLE LEVER FAUCET, POLISHED CHROME FINISH, SPEED CONNECT POP-UP DRAIN, ADA COMPLIANT. DRAIN: AMERICAN STANDARD POP-UP DRAIN AND TAILPIECE DRAIN: MCGUIRE #155 WCC OFFSET OPEN GRID DRAIN DRAIN:McGUIRE #8872C POLISHED CHROME FINISHED BRASS P-TRAP WITH CLEAN OUT PLUG AND ESCUTCHEON. SUPPLY: MCGUIRE # BV170 FAUCET SUPPLY, CHROME FINISH POLISHED BRASS WITH ESCUTCHEON AND FLEXIBLE COPPER RISER. INSULATION: TPW2000WC PROWRAP VANDAL RESISTANT SANITARY COVERING, FLEXIBLE SEAMLESS MOLDED CLOSED-CELL PVC RESIN, FORMULATED WITH ANTI-MICROBIAL ADDITIVE. (ADA ONLY)
P-3	SHOWER	2"	1/2"	1/2"		FAUCET: AMERICAN STANDARD #T385.501/R120SS, PRESSURE BALANCING MIXING VALVE, BRASS BODY, WASHERLESS CERAMIC DRIP-FREE DISC VALVE CARTRIDGE, INTEGRAL HOT LIMIT STOP, SCREW DRIVERS STOPS, METAL WALL ESCUTCHEON, METAL LEVER HANDLE, 1.5 GPM SHOWER HEAD. DRAIN: WATTS#FD-100-A-2" FLOOR DRAIN OUTLET.
P-3H	SHOWER (HANDICAP)	2"	1/2"	1/2"		FAUCET: AMERICAN STANDARD #T385.500/R120SS, PRESSURE BALANCING MIXING VALVE, BRASS BODY, WASHERLESS CERAMIC DRIP-FREE DISC VALVE CARTRIDGE, INTEGRAL HOT LIMIT STOP, SCREW DRIVERS STOPS, METAL WALL ESCUTCHEON, METAL LEVER HANDLE, AMERICAN STANDARD 1662.604 WATER-SAVING SPRAY HAND SHOWER 1.5 GPM CHROME PLATED HAND SHOWER WITH FLEXIBLE METAL HOSE, 1660.400 IN-LINE VACUUM BREAKER, WALL SUPPLY, AND 36" SLIDE BAR. DRAIN: WATTS#FD-100-A-2" FLOOR DRAIN OUTLET.
P-4	SINK (SINGLE COMP.)	1 1/2"	1/2"	1/2"	ELKAY MODEL PSRQ1918 TOP MOUNT SINK NICKEL BEARING STAINLESS STEEL, GAUGE 20, 3 HOLES FAUCET, 19" X 18" X 7 1/8" OVERALL SIZE, SATIN FINISH, FULLY UNDERCOATED, 3 1/2" DRAIN OPENING	FAUCET: ELKAY LK1000CR, SINGLE LEVER FAUCET, 3 HOLES REQUIRED, CERAMIC DISC CARTRIDGE, OVERALL HEIGHT 7 1/2", SPOUT REACH 8" DRAIN: ELKAY #LK-35 BASKET STRAINER, CHROME PLATED CAST BRASS WITH TAILPIECE. MACGUIRE# #8912 POLISHED CHROME PLATED CAST BRASP-TRAP WITH CLEANOUT PLUG AND ESCUTCHEON. MCGUIRE#BV170 FAUCET SUPPLIES, CHROME FINISH, COMMERCIAL DUTY 1/4 TURN BALL VALVE ANGLE STOP.
P-4H	SINK-ADA (SINGLE COMP.)	1 1/2"	1/2"	1/2"	ELKAY MODEL PSRADQ191955L SELF-RIMMING SINK NICKEL BEARING STAINLESS STEEL, GAUGE 20, 3 HOLES FAUCET, 19 1/2" X 19" X 5 1/2" OVERALL SIZE, SATIN FINISH, FULLY UNDERCOATED, 3 1/2" DRAIN OPENING.	FAUCET: ELKAY LK1000CR, SINGLE LEVER FAUCET, 3 HOLES REQUIRED, CERAMIC DISC CARTRIDGE, OVERALL HEIGHT 7 1/2", SPOUT REACH 8" DRAIN: ELKAY #LK-35 BASKET STRAINER, CHROME PLATED CAST BRASS WITH TAILPIECE. MACGUIRE# #8912 POLISHED CHROME PLATED CAST BRASS P-TRAP WITH CLEANOUT PLUG AND ESCUTCHEON. MCGUIRE#BV170 FAUCET SUPPLIES, CHROME FINISH, COMMERCIAL DUTY 1/4 TURN BALL VALVE ANGLE STOP.INSULATION: TPW2000WC PROWRAP VANDAL RESISTANT SANITARY COVERING, FLEXIBLE SEAMLESS MOLDED CLOSED-CELL PVC RESIN, FORMULATED WITH ANTI-MICROBIAL ADDITIVE.
P-5	CLOTHES WASHER	2"	1/2"	1/2"		ACORN HOSE VALVE#8131-CR STRAIGHT NOSE WITH VACUUM BREAKER OATEY # 38928 CENTER DRAIN WASHING MACHINE BOX.
WH-1	WATER HAMMER ARRESTORS		1/2"	1/2"		WATTS PDI CERTIFIED. PRECHARGED DRAWN COPPER
WCO	WALL CLEANOUT	2"				WATTS LINE CLEANOUT #CO-450-RD
FC0	GRADE CLEANOUT	4"				WATTS ACCESS HOUSING #CO-300-MF



					(
		WATE	IR HE	ATER	SCHE	DL	JLE	
MARK	CAP. GAL.	HEATING SOURCE	ELEMENTS	KW. OR BTUH	VOLTAGE (>	EF	REMARKS
EWH-1 UNITS #1,2,3,4	30	ELECTRICAL	SINGLE	4.5 KW	240 V, 1PH, (60HZ	>	0.95	LOCHINVAR MODEL JRAO30KS

ALLEGUEZ ARCHITECTURE, INC. ARCHITECTURE PLANNING DESIGN INTERIOR CONSTRUCTION MANAGEMENT 901 PONCE DE LEON BLVD., SUITE 202 CORAL GABLES, FLORIDA 33134 (305) 461 4001 (FAX) 461 6002 E-MAIL alleguez@bellsouth.net ■AA C 0 0 2 7 4 6 ■ CONSULTANTS: MECHANICAL, ELECTRICAL, PLUMBING ENGINEER: GARTEK ENGINEERING CORP. 7210 SOUTHWEST 39TH TERRACE MIAMI, FLORIDA 33155 TEL: (305) 266-8997 FAX: (305) 264-9496 Certificate of Authorization #3144 www.gartek-engineering.com ' Gartek Project No. 2867 This document and the information it contains is the exclusive property of Gartek Engineering and may not be reproduced or used for other purpose other than the specific project for which it was prepared without the explicit consent of Castel Engineering.

CITY OF MIAMI LIFE QUEST RENOVATIONS 1301 N.E. 111 ST.


Owner's Representative: Lori B. Soto


City of Miami **Department of Community Development** (305) 416-2084 444 SW 2nd Avenue Miami, FL. 33130

DRAWING TITLE:

PLUMBING NOTES SPECS., LEGEND, & SCHEDULES

ROBERT BETANCOURT P.E. (MECHANICAL) LICENSE NO. 34788 "In my professional judgement and to the best of my knowledge and belief, these plans and specifications comply with applicable Building Codes." September 15, 2014 12-13-13 BLDG. DEPT. COMMENTS CAD DRAWING NAME: SHEET NO.

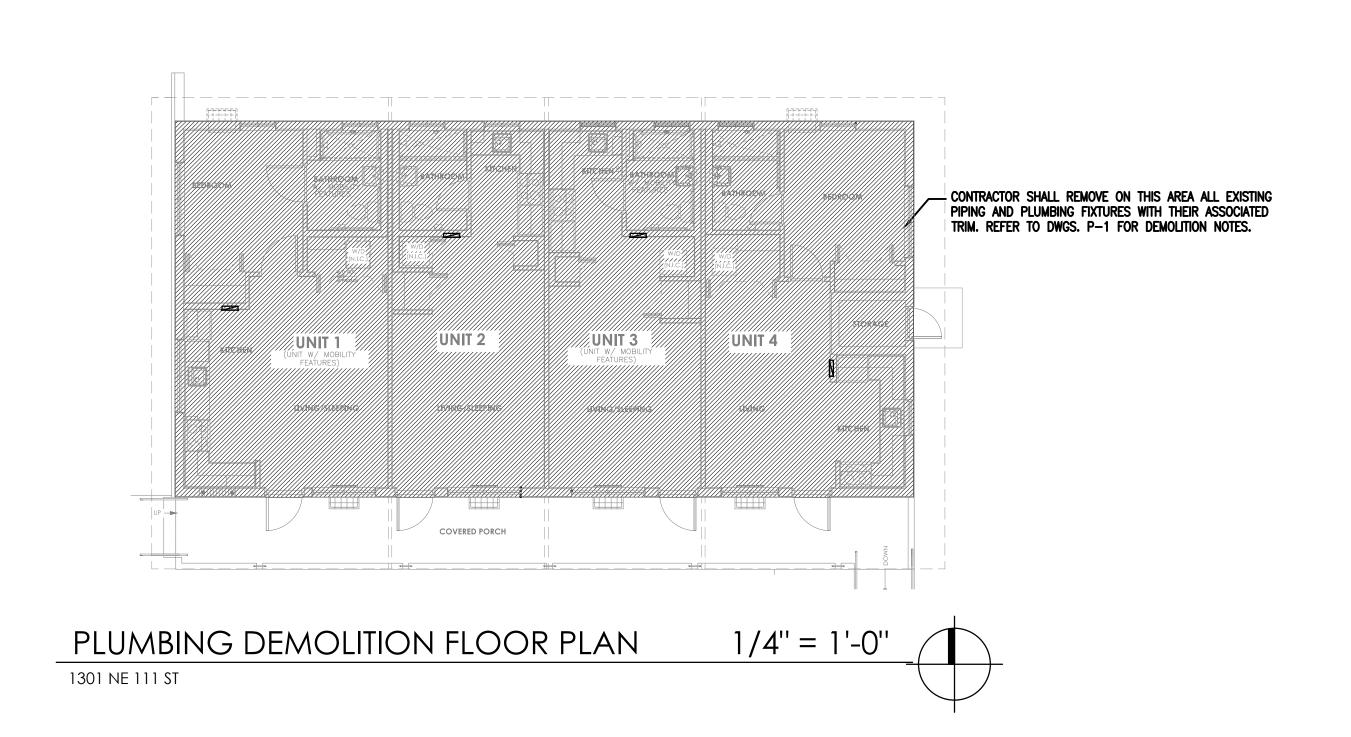

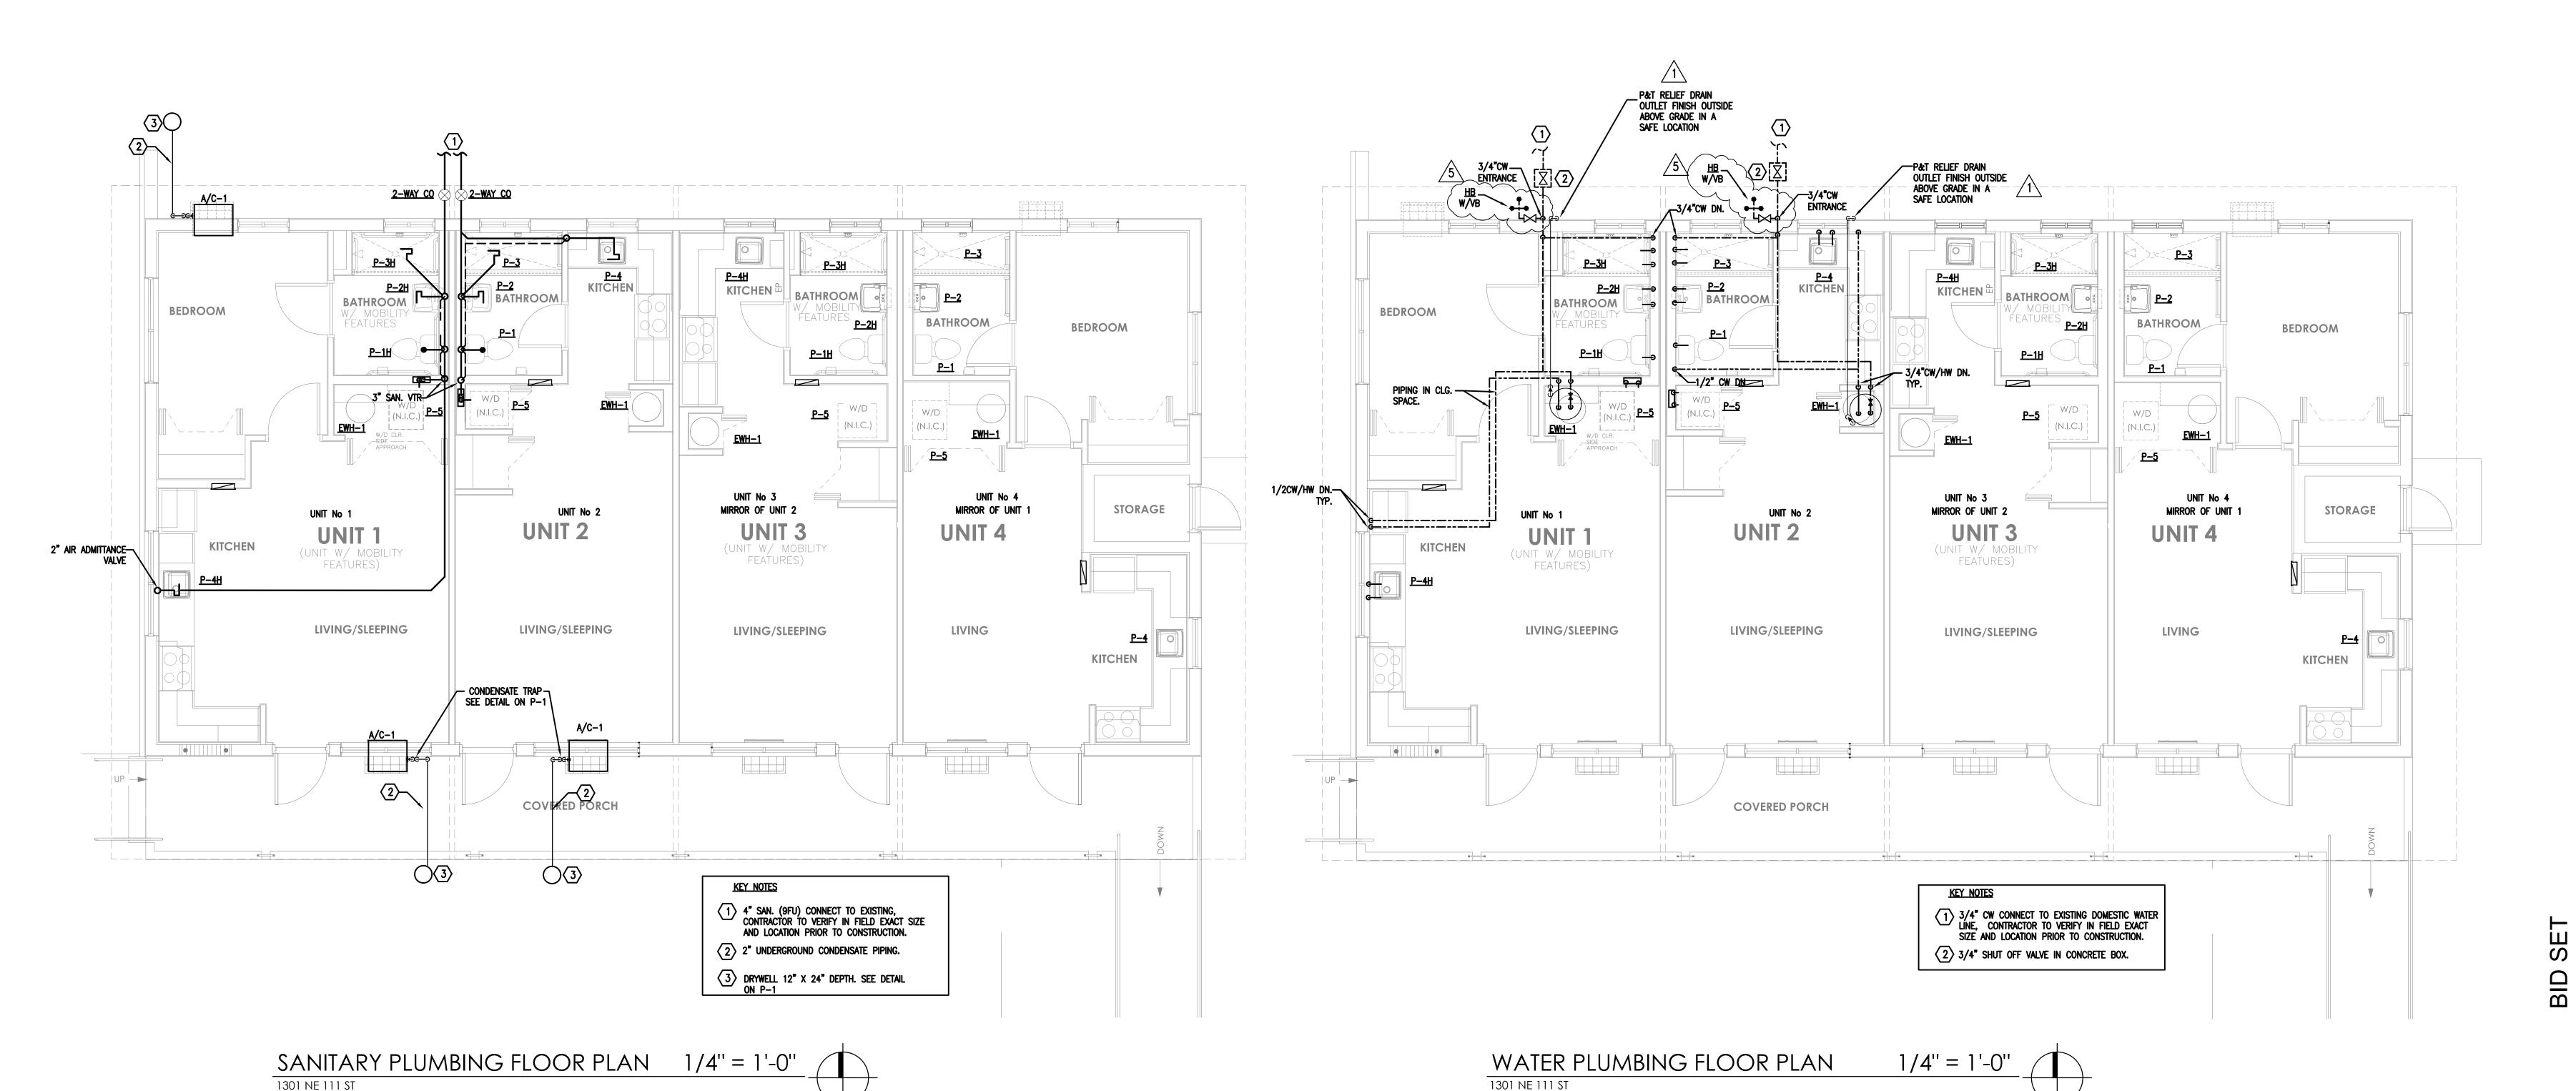

A L L E G U E Z
ARCHITECTURE, INC.

ARCHITECTURE PLANNING
INTERIOR DESIGN
CONSTRUCTION MANAGEMEN

901 PONCE DE LEON BLVD., SUITE 202
CORAL GABLES, FLORIDA 33134
(305) 461 4001 (FAX) 461 6002

MECHANICAL, ELECTRICAL, PLUMBING ENGINEER:

GARTEK ENGINEERING CORP.

7210 SOUTHWEST 39TH TERRACE
MIAMI, FLORIDA 33155
TEL: (305) 266-8997 FAX: (305) 264-9496

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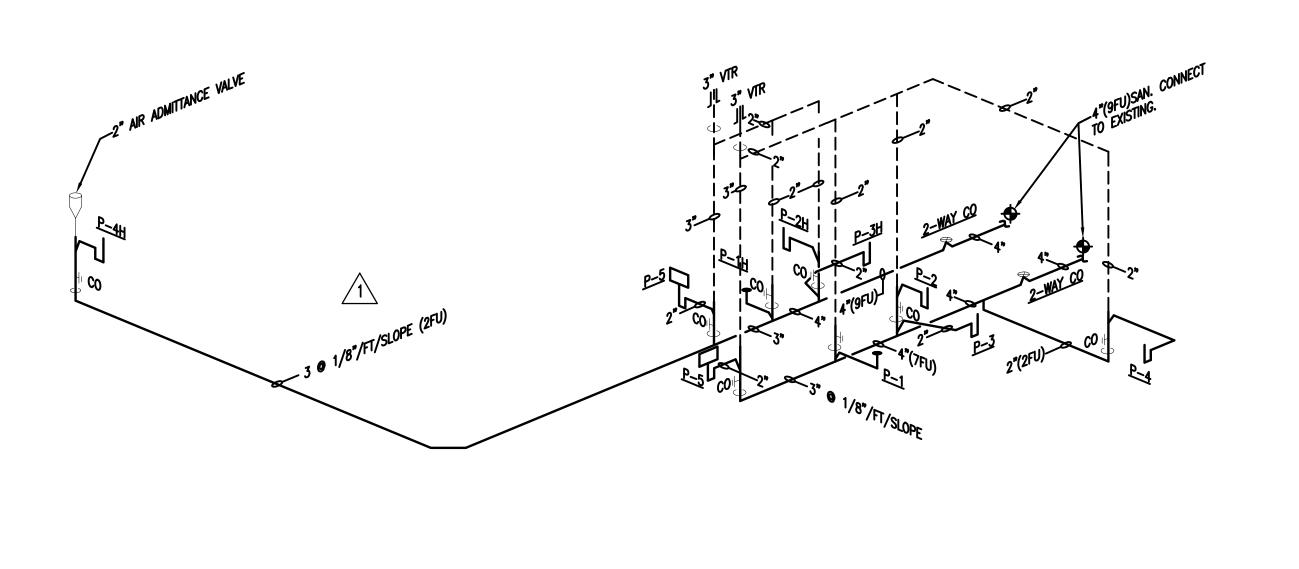
E-MAIL alleguez@bellsouth.net
■AA C 0 0 2 7 4 6 ■

CITY OF MIAMI LIFE QUEST RENOVATIONS 1301 N.E. 111 ST. Owner's Representative: Lori B. Soto City of Miami Department of Community Developmen (305) 416-2084 444 SW 2nd Avenue Miami, FL. 33130 DRAWING TITLE: PLUMBING FLOOR PLAN ROBERT BETANCOURT P.E. (MECHANICAL) LICENSE NO. 34788 "In my professional judgement and to the best of my knowledge and belief, t plans and specifications comply with applicable Building Codes." September 15, 2014


10-20-13 BLDG. DEPT. COMMENTS

△5 01−16−17 PLAN UPDATE

CAD DRAWING NAME:



SANITARY RISER NTS

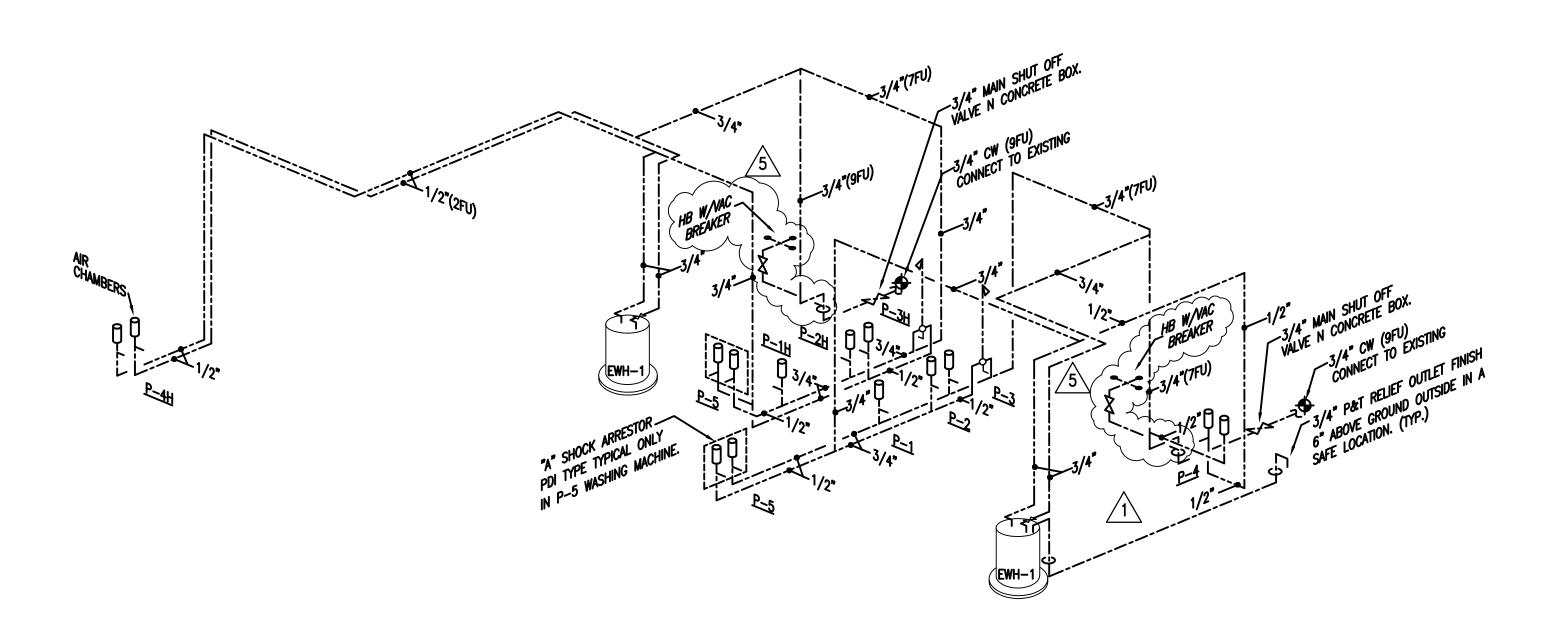

NTS

WATER RISER

CITY OF MIAMI
LIFE QUEST
RENOVATIONS
1301 N.E. 111 ST.

Owner's Representative:
Lori B. Soto

A L L E G U E Z ARCHITECTURE, INC.

ARCHITECTURE PLANNING

CONSTRUCTION MANAGEMEN

901 PONCE DE LEON BLVD., SUITE 202 CORAL GABLES, FLORIDA 33134 (305) 461 4001 (FAX) 461 6002 E-MAIL alleguez@bellsouth.net

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Certificate of Authorization #3144 www.gartek-engineering.com

Gartek Project No. 2867

7210 SOUTHWEST 39TH TERRACE

DESIGN

INTERIOR

CONSULTANTS:

Lori B. Soto

City of Miami

Department of Community Development
(305) 416-2084
444 SW 2nd Avenue
Miami, FL. 33130

DRAWING TITLE:

PLUMBING RISERS

ROBERT BETANCOURT P.E. (MECHANICAL)

LICENSE NO. 34788
"In my professional judgement and to the best of my knowledge and belief, these plans and specifications comply with applicable Building Codes."

September 15, 2014


10-20-13 BLDG. DEPT. COMMENTS

5 01-16-17 PLAN UPDATE


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SHEET NO.


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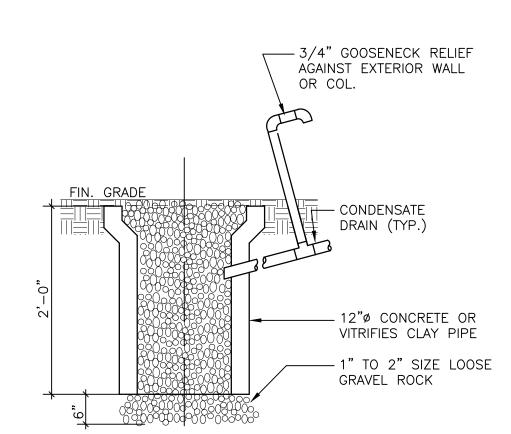
1 CONDENSATE TRAP DETAIL P4 SCALE: N.T.S.

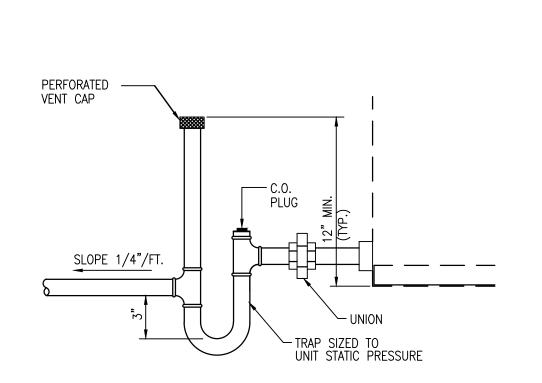

2 TYPICAL LAVATORY MOUNTING DETAIL P4 SCALE: N.T.S.

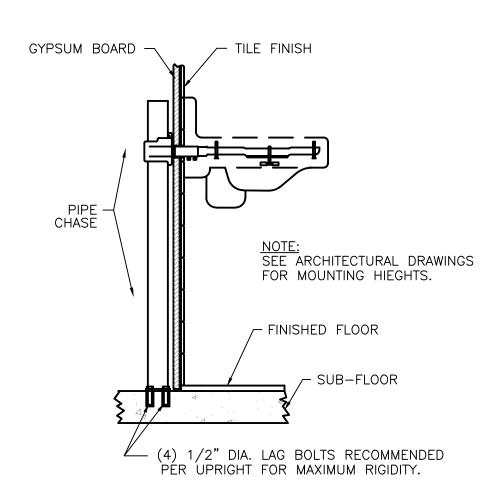

3 ELECTRIC WATER HEATER DETAIL P4 SCALE: N.T.S.

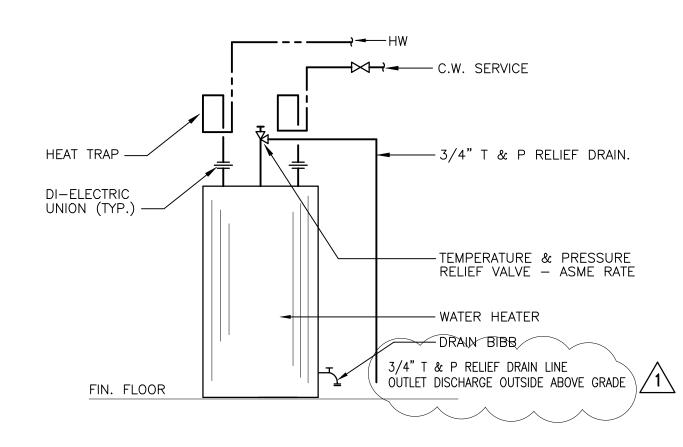

4 DRYWELL DETAIL
P4 SCALE: N.T.S.

ROOFING CONSTRUCTION



NOTE:

ANY VENT PIPE WITHIN 10' OF ANY DOOR , WINDOW , OR EXHAUST OPENING OR OUTSIDE AIR INTAKE SHALL EXTEND NOT LESS THAN 3' ABOVE SAME .


VENT STACK


— TURN LEAD FLASHING DOWN INTO STACK 2" MIN.

- SLEEVE ROOF CONSTRUCTION AS REQ'D.


- FILL IN W/ ROOF MATERIAL



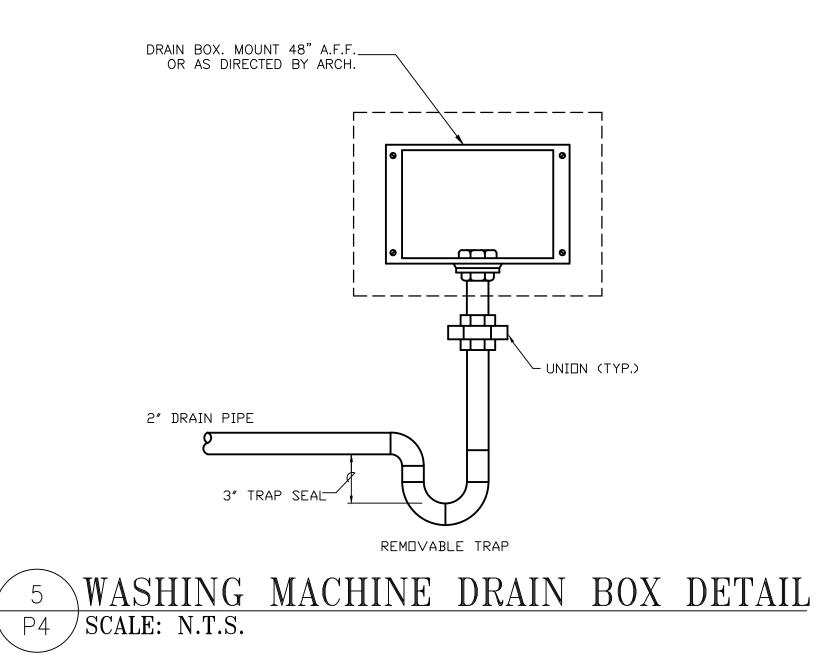

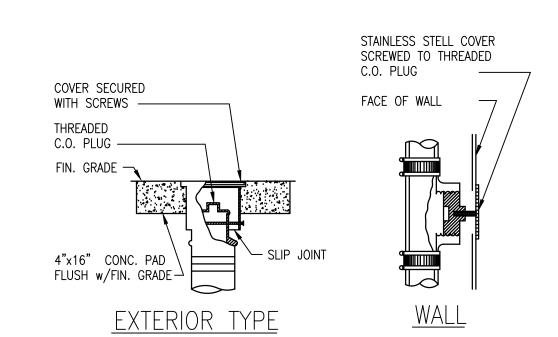



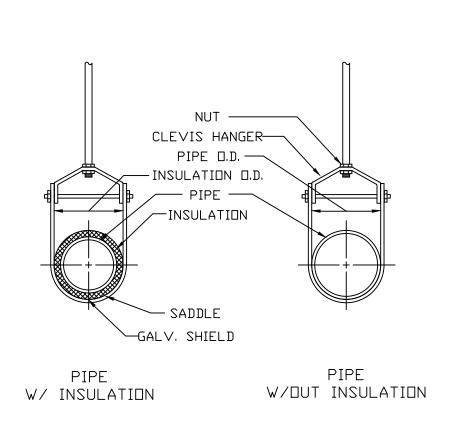

6 CLEVIS PIPE HANGER DETAIL P4 SCALE: N.T.S.



A L L E G U E Z

ARCHITECTURE, INC.

ARCHITECTURE PLANNING

CONSTRUCTION MANAGEMENT

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Certificate of Authorization #3144
www.gartek—engineering.com

Gartek Project No. 2867

7210 SOUTHWEST 39TH TERRACE MIAMI, FLORIDA 33155 DESIGN

INTERIOR

CONSULTANTS:

PLUMBING DETAILS

SEAL
ROBERT BETANCOURT P.E. (MECHANICAL) LICENSE NO. 34788 "In my professional judgement and to the best of my knowledge and belief, these plans and specifications comply with applicable Building Codes."
September 15, 2014
REVISED:
10-20-13 BLDG. DEPT. COMMENTS
CAD DRAWING NAME:
SHEET NO.

ECOLOGICAL TANKS, INC

INDIVIDUAL HOME WASTEWATER TREATMENT PLANT

MODELS AS500, AS600, AS750, AS1000, & AS1500

Discharge Piping Assembly, Compressor Housing

A (I.D.)

5'6"

6**'**0"

6'9"

6'9"

8'2"

AEROBIC SYSTEMS (770) 646-7990

Treatment Capacity (GPD)

Volumetric Capacity (GAL)

Aeration Capacity (GAL)

BOD5 Loading (LB/DAY)

Clarifier Capacity (GAL)

WEIGHTS (POUNDS)

PARTS LIST

DIMENSIONS

MODEL

AS500

AS600

AS750

AS1000

AS1500

AEROBIC TREATMENT UNIT

(1) WHENEVER THE USE OF AN ONSITE SEWAGE TREATMENT AND DISPOSAL

SYSTEM IS DISCONTINUED FOLLOWING CONNECTION TO A SANITARY SEWER,

FOLLOWING CONDEMNATION OR DEMOLITION OR REMOVAL OR DESTRUCTION, OF A

BUILDING OR PROPERTY, OR DISCONTINUING THE USE OF A SEPTIC TANK AND

REPLACEMENT WITH ANOTHER SEPTIC TANK, THE SYSTEM SHALL BE ABANDONED

WITHIN 90 DAYS AND ANY FURTHER USE OF THE SYSTEM FOR ANY PURPOSE

SHALL BE PROHIBITED. HOWEVER, IF THE DEPARTMENT OF ENVIRONMENTAL

PROTECTION OR ITS DESIGNEE APPROVES THE USE OF THE RETENTION TANK

WHERE THE TANK IS TO BECOME AN INTEGRAL PART OF A SANITARY SEWER

SYSTEM OR STORMWATER MANAGEMENT SYSTEM, THE SEPTIC TANK NEED NOT BE

(2) THE FOLLOWING ACTIONS SHALL BE TAKEN, IN THE ORDER LISTED, TO

(A) PROPERTY OWNER OR AGENT SHALL APPLY FOR A PERMIT FROM THE

(C) THE BOTTOM OF THE TANK SHALL BE OPENED OR RUPTURED. OR THE ENTIRE TANK COLLAPSED SO AS TO PREVENT THE TANK FROM RETAINING WATER,

(D) THE TANK SHALL BE FILLED WITH CLEAN SAND OR OTHER SUITABLE

(E) AN INSPECTION OF THE SYSTEM ABANDONMENT SHALL BE CONDUCTED BY

THE DEPARTMENT OR BY THE LOCAL UTILITY OR PLUMBING AUTHORITY

(3) THE PERMITTING PROVISIONS OF PARAGRAPH 64E-6.011(2)(A), F.A.C., ARE

NOT REQUIRED IF A LOCAL UTILITY OR LOCAL PLUMBING AUTHORITY PERFORMS A

SYSTEM ABANDONMENT PROGRAM WHICH REQUIRES THE COMPLETION OF THOSE

STEPS LISTED IN PARAGRAPHS 64E-6.011(2)(B), (C), (D), AND (E), F.A.C. IF

THE SYSTEM ABANDONMENT IS PERFORMED BY A LOCAL UTILITY OR LOCAL PLUMBING AUTHORITY, THE LOCAL UTILITY OR LOCAL PLUMBING AUTHORITY

PERFORMING THE ABANDONMENT PROGRAM SHALL MAINTAIN A LOG OF ALL

INSPECTIONS PERFORMED AND SHALL FORWARD THE LOG TO THE COUNTY HEALTH

(4) A SEPTIC TANK SERVING A SINGLE FAMILY RESIDENCE MAY, AT THE

OWNER'S DISCRETION, BE CONVERTED INTO A CISTERN PURSUANT TO THE

(A) THE APPLICANT SHALL OBTAIN A SYSTEM ABANDONMENT PERMIT FROM THE

(B) THE PERMIT APPLICATION SHALL SPECIFY THE INTENDED USE OF THE

(C) THE ACTIVITIES RELATED TO ABANDONING THE ONSITE SEWAGE TREATMENT

(D) THE SEPTIC TANK SHALL BE DISCONNECTED FROM THE DRAINFIELD AND

(E) ALL WORK TO DISCONNECT, CLEAN AND SANITIZE THE SEPTIC TANK SHALL

BE CONDUCTED BY A REGISTERED SEPTIC TANK CONTRACTOR OR A

STATE-LICENSED PLUMBER OR BY THE OWNER OF THE OWNER-OCCUPIED SINGLE

AND DISPOSAL SYSTEM SHALL NOT CREATE A SANITARY NUISANCE.

DEPARTMENT TO ABANDON THE EXISTING ONSITE SEWAGE SYSTEM AND SUBMIT

ABANDON AN ONSITE SEWAGE TREATMENT AND DISPOSAL SYSTEM:

THE REQUIRED FEE. UPON RECEIVING A PERMIT:

MATERIAL, AND COMPLETELY COVERED WITH SOIL.

PERFORMING THE SYSTEM ABANDONMENT.

DEPARTMENT ON A MONTHLY BASIS.

FOLLOWING PROCEDURES:

COUNTY HEALTH DEPARTMENT.

ABANDONED SEPTIC TANK.

FROM THE BUILDING SEWER PIPE.

(B) THE TANK SHALL BE PUMPED OUT.

FLORIDA ADMINISTRATIVE CODE 64E-6.011 ABANDONMENT OF SYSTEMS

HAVE BEEN MET:

BUILDING SEWER.

THE BOTTOM OF THE TANK.

TO THE ABANDONMENT ACTIVITIES.

STAFF DURING THE FINAL INSPECTION.

BY SECTION 386.041, F.S.

FAMILY RESIDENCE BEING SERVED BY THE SEPTIC TANK

AT A DEP-REGULATED WASTEWATER TREATMENT FACILITY

(F) ALL SEPTAGE, WASH WATER, AND OTHER LIQUIDS REMOVED FROM THE

TANK SHALL BE REMOVED AND HANDLED AS SEPTAGE (RULE 64E-6.010,

F.A.C.) BY A DOH-LICENSED SEPTAGE DISPOSAL SERVICE AND DISPOSED OF

(G) THE HEALTH DEPARTMENT SHALL INSPECT THE TANK ONCE IT

DISCONNECTED, EMPTIED, CLEANED, DISINFECTED AND FILLED WITH WATER. THE

INSPECTION SHALL DETERMINE WHETHER ALL OF THE FOLLOWING CONDITIONS

1. THE TANK HAS BEEN DISCONNECTED FROM THE DRAINFIELD AND TH

2. THE TANK IS FULL OF WATER WITHIN 12 INCHES OF THE TOP OF THE

3. THE CLARITY OF THE WATER IS SUCH THAT A SECCHI DISK IS VISIBLE AT

5. THE FREE CHLORINE RESIDUAL OF THE WATER IN THE TANK IS \leq 1.0

8. NO SANITARY NUISANCE CONDITION EXISTS ON THE PROPERTY RELATED

(H) ONE INSPECTION IS INCLUDED IN THE ABANDONMENT PERMIT FEE. THE

APPLICANT SHALL PAY A REINSPECTION FEE FOR ANY ADDITIONAL INSPECTION

VISITS NECESSARY UNTIL ALL OF THE CRITERIA IN SUBPARAGRAPHS

64E-6.011(4)(G)1. THROUGH 8. F.A.C., ARE MET AND FINAL APPROVAL OF

(I) THE APPLICANT SHALL BE RESPONSIBLE FOR ALL REQUIRED LABORATORY

(J) THE SEPTIC TANK SHALL BE CONVERTED AND INSPECTED WITHIN 90

(K) THE TANK SHALL NOT BE CONNECTED TO ANY IRRIGATION COMPONENTS

NOR SHALL THE WATER USED FOR IRRIGATION PURPOSES UNTIL FINAL

APPROVAL OF THE ABANDONMENT HAS BEEN GRANTED BY THE COUNTY HEALTH

(L) UPON FINAL APPROVAL OF THE ABANDONMENT, USE OF THE TANK OR

THE DRAINFIELD FOR SEWAGE STORAGE, TREATMENT OR DISPOSAL IS

PROHIBITED AND CONSTITUTES A NUISANCE INJURIOUS TO HEALTH AS DEFINED

(M) UPON FINAL APPROVAL OF THE ABANDONMENT, THE WATER COLLECTED

IN THE TANK SHALL BE UTILIZED FOR NON-POTABLE, IRRIGATION PURPOSES

RULEMAKING AUTHORITY 381.0065, 489.553, 489.557 FS. LAW IMPLEMENTED

381.0065, 381.00655, 381.0066, PART I 386 FS. HISTORY-NEW 12-22-82,

AMENDED 2-5-85, FORMERLY 10D-6.53, AMENDED 3-17-92, 1-3-95,

FORMERLY 10D-6.053, AMENDED 6-18-03, 6-25-09.

DAYS AFTER CONNECTION OF THE BUILDING PLUMBING TO THE SANITARY

FEES. ALL SAMPLING SHALL BE CONDUCTED BY COUNTY HEALTH DEPARTMENT

THE ABANDONMENT IS GRANTED BY THE COUNTY HEALTH DEPARTMENT.

4. THE PH OF THE WATER IN THE TANK IS BETWEEN 6.0 AND 8.0.

6. THE TOTAL COLIFORM COUNT IS \leq 1000 PER 100 ML.

7. THE FECAL COLIFORM COUNT IS \leq 200 PER 100 ML.

AQUA SAFE PRODUCT SPECIFICATIONS

\AS600 /

1/.50

660

B (HEIGHT)

6'4"

6'4"

6'4"

8'2"

8'2"

Aeration Tank, Clarifier, Air Distribution System, Access Cover 20" Polyethylene,

\AS750/ | AS1000 |

1000

1706

302

2.50

1000

C(RAD)

41"

2008

\ 750[/]

/1.85\

/ 800 \

NOTE: SUB-SURFACE CONDITIONS WAS BASED ON THE "REPORT OF SURFACE SOIL EXPLORATION GEOTHECHNICAL EVALUATION AND RECOMMENDATIONS" TO CITY OF MIAMI LIFE QUEST 149502 NE11 AVENUE MIAMI, FLORIDA, DATED NOVEMBER 2013 BY NELCO TESTING AND ENGINEERING SERVICES, INC.

Aqua Safe AS 500 - 1500

With EZ Top

PLUMBING LEGEND									
	SAN	SANITARY DRAIN							
SD	SD	STORM DRAIN							
CD	CD	CONDENSATE DRAIN LINE							
	CW	COLD WATER LINE							
III	BV	FULL PORT-BONZE/BRASS TEFLON SEAT BALL VALVE							
	VIV	VALVE IN RISER							
*	НВ	HOSE BIBB W/ VACUUM BREAKER							
\otimes	CO	TWO WAY CO							
	FCO C1G	FLOOR CLEAN OUT CLEAN OUT TO GRADE							

UNDER GROUND

CNTE CONNECT TO EXISTING

. UNLESS OTHERWISE SPECIFIED ON THIS DRAWING CONTRACTOR SHALL REFER TO ORIGINAL LANDLORD SPECIFICATIONS FOR ALL APPLICABLE REQUIREMENTS, NOTES, DETAILS, CONSTRUCTION'S STANDARDS, ETC., COORDINATE WITH LANDLORD REQUIREMENTS PRIOR TO ORDERING AND/OR INSTALLATION OF ANY EQUIPMENT AND ACCESSORIES SHOWN.

PLUMBING GENERAL NOTES

2. THE CONTRACTOR SHALL FURNISH ALL LABOR, MATERIAL AND EQUIPMENT NECESSARY FOR THE INSTALLATION OF A COMPLETE SEPTIC TANK AND DRAIN FIELD SYSTEM IN ACCORDANCE WITH THIS DRAWING, THE APPLICABLE EDITION OF CHAPTER 64E-6, FLORIDA ADMINISTRATIVE CODE, STANDARDS FOR ON SITE SEWAGE TREATMENT AND DISPOSAL SYSTEMS.

3. THE CONTRACTOR SHALL PAY ALL COST OF PERMIT, INSPECTIONS AND OTHER COSTS INCIDENTAL TO THE COMPLETION AND TESTING OF THIS WORK. UPON FINAL INSPECTION. A CERTIFICATE FROM THE LOCAL STATE INSPECTION AUTHORITY SHALL BE FURNISHED TO THE OWNER.

4. EXISTING PIPES SERVING AREAS NOT COVERED BY THIS CONTRACT BUT IN SERVICE AT THIS TIME SHALL NOT BE INTERRUPTED EXCEPT AS A TEMPORARY INTERRUPTION COORDINATED WITH THE OWNER AND LANDLORD.

5. CONTRACTOR SHALL VERIFY ALL SPACE CONDITIONS AND DIMENSIONS AT JOB SITE PRIOR TO FABRICATION AND INSTALLATION OF MATERIALS. PIPING AND EQUIPMENT. 6. ALL MATERIALS AND EQUIPMENT SHALL BE NEW AND MUST BE FURNISHED SO AS TO

PREVENT ANY DELAY IN THE PROGRESS OF THE WORK.

7. CONTRACTOR SHALL SUBMIT EQUIPMENT & PLUMBING FIXTURES SHOP DRAWINGS. SHOP DRAWINGS SHALL BE COORDINATED BY CONTRACTOR WITH ALL TRADES INCLUDING STRUCTURAL, LIGHTING. ARCHITECTURAL LATEST LAYOUTS, ETC. CONTRACTOR SHALL NOT PROCEED TO ORDER AND/OR INSTALL EQUIPMENT AND ACCESSORIES UNLESS SHOP DRAWING REVIEW PROCESS HAS BEEN COMPLETED AND REVIEWED BY THE ENGINEER OF RECORD (EOR) AND APPROVED BY THE OWNER REPRESENTATIVES. THE DRAWINGS ARE NOT TO BE SCALED. UNLESS SPECIFIC DIMENSIONS ARE SHOWN, THE ARCHITECTURAL AND/OR STRUCTURAL DRAWINGS, AND SITE CONDITIONS SHALL GOVERN EXACT LOCATION OF PLUMBING EQUIPMENT AND APPURTENANCES. MANUFACTURERS USED AS THE BASIS OF DESIGN ARE LISTED ON THE DRAWING'S SCHEDULES, ANY OTHERS MUST MEET OR EXCEED ALL SPECIFIED REQUIREMENTS. ANY SUBSTITUTIONS (WHERE ALLOWED BY "OR EQUAL" ON THESE DOCUMENTS) MUST BE ACCOMPANY BY A DETAIL COST AND EQUALITY COMPARISON OF ALL ITEMS INCLUDING ANY COST DIFFERENCES AND MUST BE SUBMITTED FOR EOR REVIEW TEN (10) WORKING DAYS PRIOR TO BIDS. IF "OR EQUAL" IS NOT LISTED AFTER THE MANUFACTURER'S NAME ON THESE DOCUMENTS, THE LISTED MANUFACTURER SHALL BE SUBMITTED, NO EXCEPTIONS ARE ALLOWED. NAMING ACCEPTABLE MANUFACTURERS DOES NOT RELIEVES THE CONTRACTOR FROM COMPLIANCE WITH ALL DESIGN REQUIREMENTS SHOWN ON THESE DRAWINGS OR LISTED HEREIN. EOR IS SOLEMNLY RESPONSIBLE TO MAKE FINAL EQUALITY RECOMMENDATION TO THE


3. PLUMBING CONTRACTOR SHALL GUARANTEE ALL WORK FREE OF DEFECTS IN MATERIALS AND WORKMANSHIP FOR A PERIOD OF ONE YEAR FROM DATE OF ACCEPTANCE.

9. COORDINATE SCHEDULING OF ALL REQUIRED INSPECTIONS WITH APPROPRIATE REGULATORY BODIES.

10. DRAINAGE SYSTEM DESIGN TO THE SPECTIC TANK INLET IS BASED ON 1/8" PER FOOT MINIMUM FALL FOR PIPES 3" OR LARGER AND 1/4" PER FOOT MINIMUM FALL FOR PIPES 2" OR SMALLER, ANY DEVIATIONS SHALL BE APPROVED BY ARCHITECT/ENGINEER.

CHAMBERS NGVD 7.0 COVER -NGVD 6.0 TOP OF DRAINFIELD -NGVD 5.0 BOTTOM OF DRAINFIELD

2 DRAINFIELD SECTION DETAIL

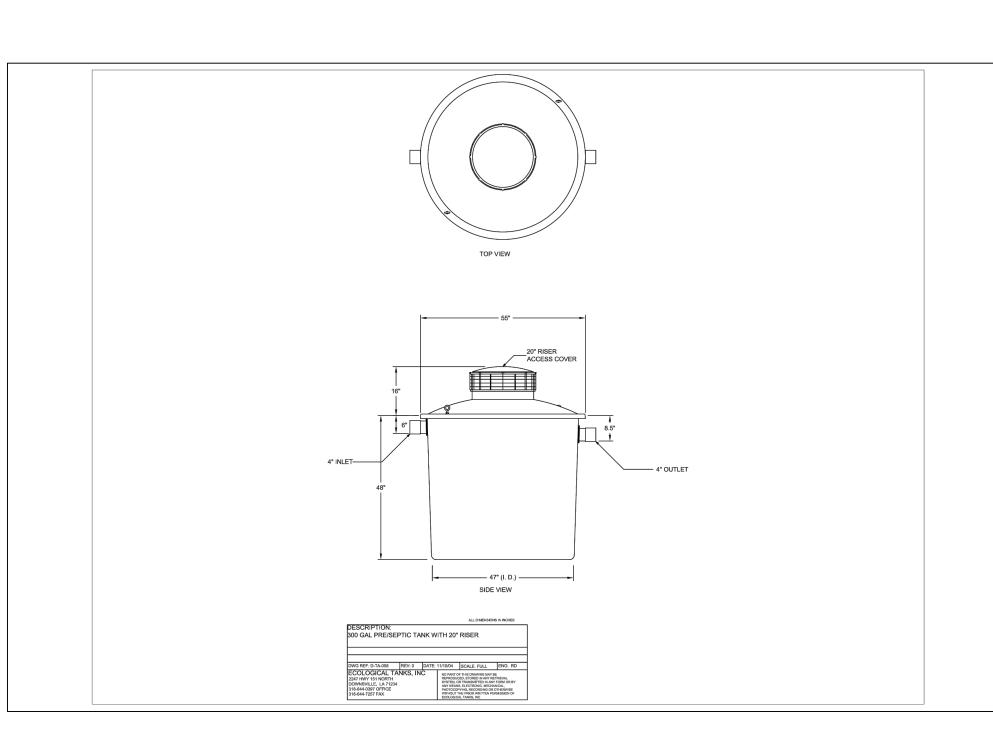

(3) PRE/SEPTIC TANK

PLUMBING SPECIFICATION MATERIAL SHALL BE NEW, UNUSED, BEST OF THEIR RESPECTIVE KINDS AND FREE FROM DEFECTS IN WORKMANSHIP; IN CONFORMANCE WITH THE LATEST PUBLICATIONS IN FORCE AT TIME OF BIDDING. PIPE AND FITTINGS: (TO SEPTIC TANK INLET) A. SANITARY SOIL/DRAINAGE BELOW GROUND: SCHEDULE 40 SOLID PLASTIC PVC PIPE ASTM D1785. B. DISPOSAL SYSTEM PIPING AS FOLLOWS: DRAINFIELD: PE PLASTIC PERFORATED FIELD TUBING 4" DIAMETER. SANITARY PIPING & CONNECTIONS: SEE PLUMB. SPECS

SCHEDULE 40 PVC MOLDED PREFORMED FITTINGS, PVC-DWV, SOCKET

3. JOINTS AND METHODS OF CONNECTION:

SOLVENT CEMENT, ASTM D-2467

C/L PEDESTRIAN GATE EXISTING SEPTIC TANK TO BE DEMOLISHED. REFER TO THE FLORIDA ADMINISTRATIVE — CODE 64E-6.011 UNIT 1 UNIT 2 UNIT 3 1 BEDROOM (482 SQ.FT.) 7.87' NGVD 1 BEDROOM (374 SQ.FT.) 7.87' NGVD (380 SQ.FT.) 7.87' NGVD

PLUMBING DEMOLITION PLAN NEMA 4X OUTDOOR CONTROL_ PANEL W/ALTERNATOR SEE ELECTRICAL DWG FOR DETAIL -GRASS GREEN SOLID FIBERGLASS COVER GROUND LEVEL NVGD 6.7 FT FINISHED FLOOR -__36" DIAMETER SOLID FIBERGLASS BASIN, 84" TALL FOR CONTINUATION AND SIZE SEE — FLOOR PLAN DUPLEX SUBMERSIBLE SEWAGE INLET LEVEL 5.0 FT-FOR CONTINUATION | CHECK VALVE AND SIZE, SEE ||(FULL WAY) MAX WATER TABLE FLOOR PLAN NGVD 4.0 SUBMERSIBLE SEWAGE PUMPS -(TYPICAL FOR 2) FLOAT SWITCH (TYPICAL) — - QUICK DISCONNET -BASIN LEVE NVGD -0.3 FT FIBERGLASS ANTI-FLOAT SEE SCHEDULE FOR BASIN SIZE, DEPTH AND MATERIAL ROUND FLANGE

DUPLEX SEWAGE PUMPS - PACKAGE DETAIL

DELEGATE STRUCTURAL ENGINEER TO PROVIDE BASIN BUOYANCY CALCULATIONS AS

YARDS OF CONCRETE AS REQUIRED TO OFFSET THAT UPLIFT AND TO KEEP BASIN

PER BUILDING CODE REQUIREMENTS AND PROVIDE BALLAST AMOUNT IN CUBIC

ANCHORED IN THE GROUND.

	SEWAGE PUMP SYSTEM SCHEDULE									
PLAN MARK	MFG. NAME	MODEL	PUMP HEAD (FT)	PUMP CAPACITY (G.P.M.)	H.P.	VOLT PHASE				
SP-1	BELL & GOSSET	DUPLEX GRINDER PUMP PACKAGE DPGSN4 WITH A BASIN KIT. 2)PUMPS MODEL 12GS2012 (1) DUPLEX OUTDOOR CONTROL PANEL D10020 (3) MECHANICAL LEVEL SWITCH A2D23W. 4K639 CAST IRON PUMP LEG. (1) BASIN D4UGR84, 36" DIAMETER 84" TALL FIBERGLASS	20	30 GPM/PUMP ALTERNATE OPERATION NOT SIMULTANEOUS OPERATION	2	208/1/60				

A L L E G U E Z ARCHITECTURE, INC.

ARCHITECTURE PLANNING DESIGN INTERIOR CONSTRUCTION MANAGEMENT

901 PONCE DE LEON BLVD., SUITE 202 CORAL GABLES, FLORIDA 33134 (305) 461 4001 (FAX) 461 6002 E-MAIL alleguez@bellsouth.net ■AA C 0 0 2 7 4 6 ■

CONSULTANTS:

MECHANICAL, ELECTRICAL, PLUMBING ENGINEER: GARTEK ENGINEERING CORP. 7210 SOUTHWEST 39TH TERRACE MIAMI, FLORIDA 33155 TEL: (305) 266-8997 FAX: (305) 264-9496 Certificate of Authorization #3144 www.gartek-engineering.com

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CITY OF MIAMI LIFE QUEST **RENOVATIONS** 1301 NE 111 ST.

MIAMI, FL

SEPTIC TANK DEMO PLAN, NOTES AND **DETAILS**


ROBERT BETANCOURT P.E. (MECHANICAL) LICENSE NO. 34788 "In my professional judgement and to the best of my knowledge and belief, the plans and specifications comply with applicable Building Codes.


February 05, 2015

1 06-15-15 DOH. COMMENTS /2\ 07-24-15 DOH. COMMENTS

CAD DRAWING NAME:

ABANDONED.

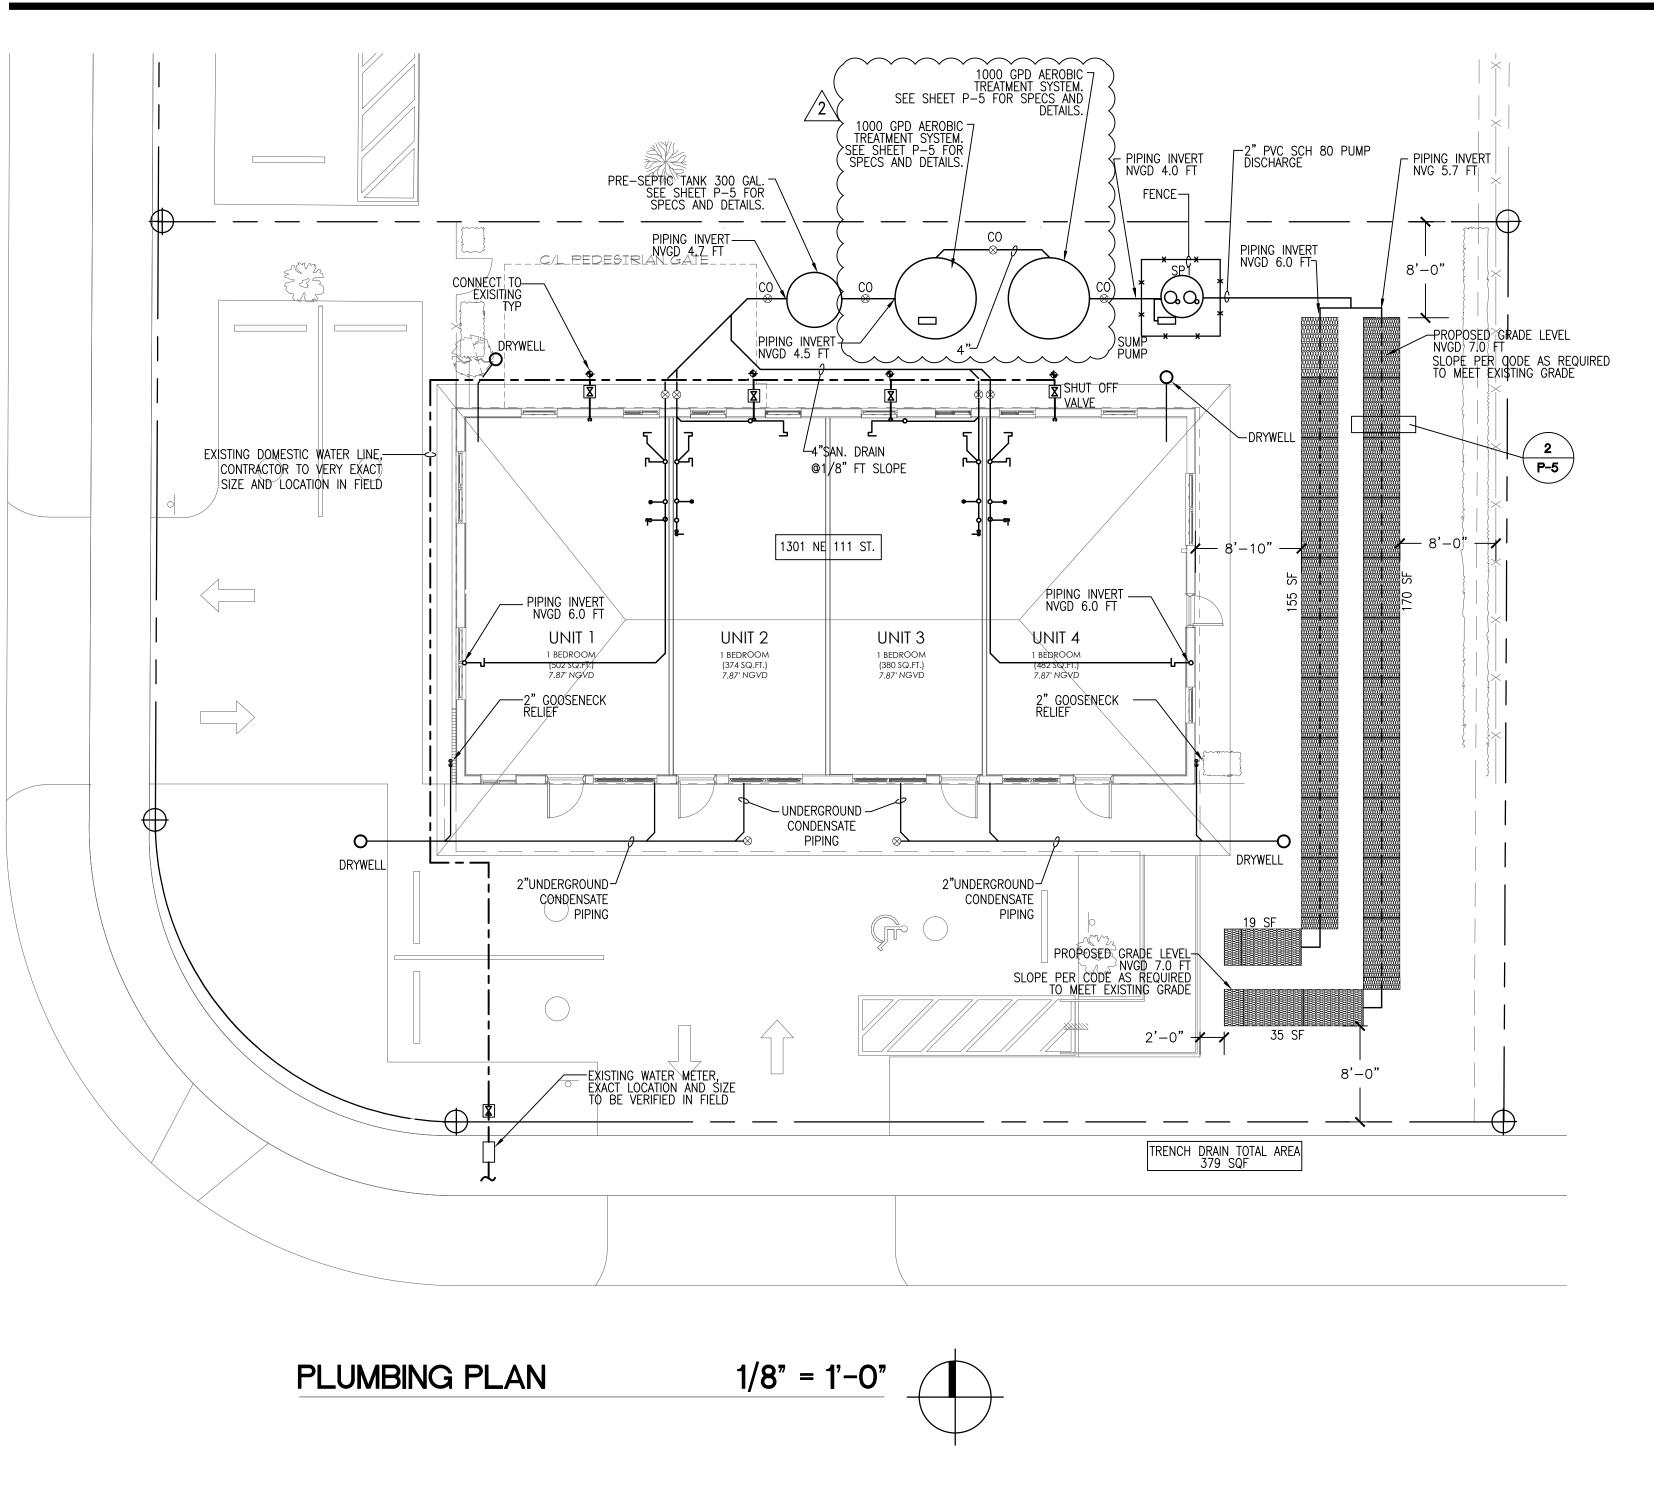

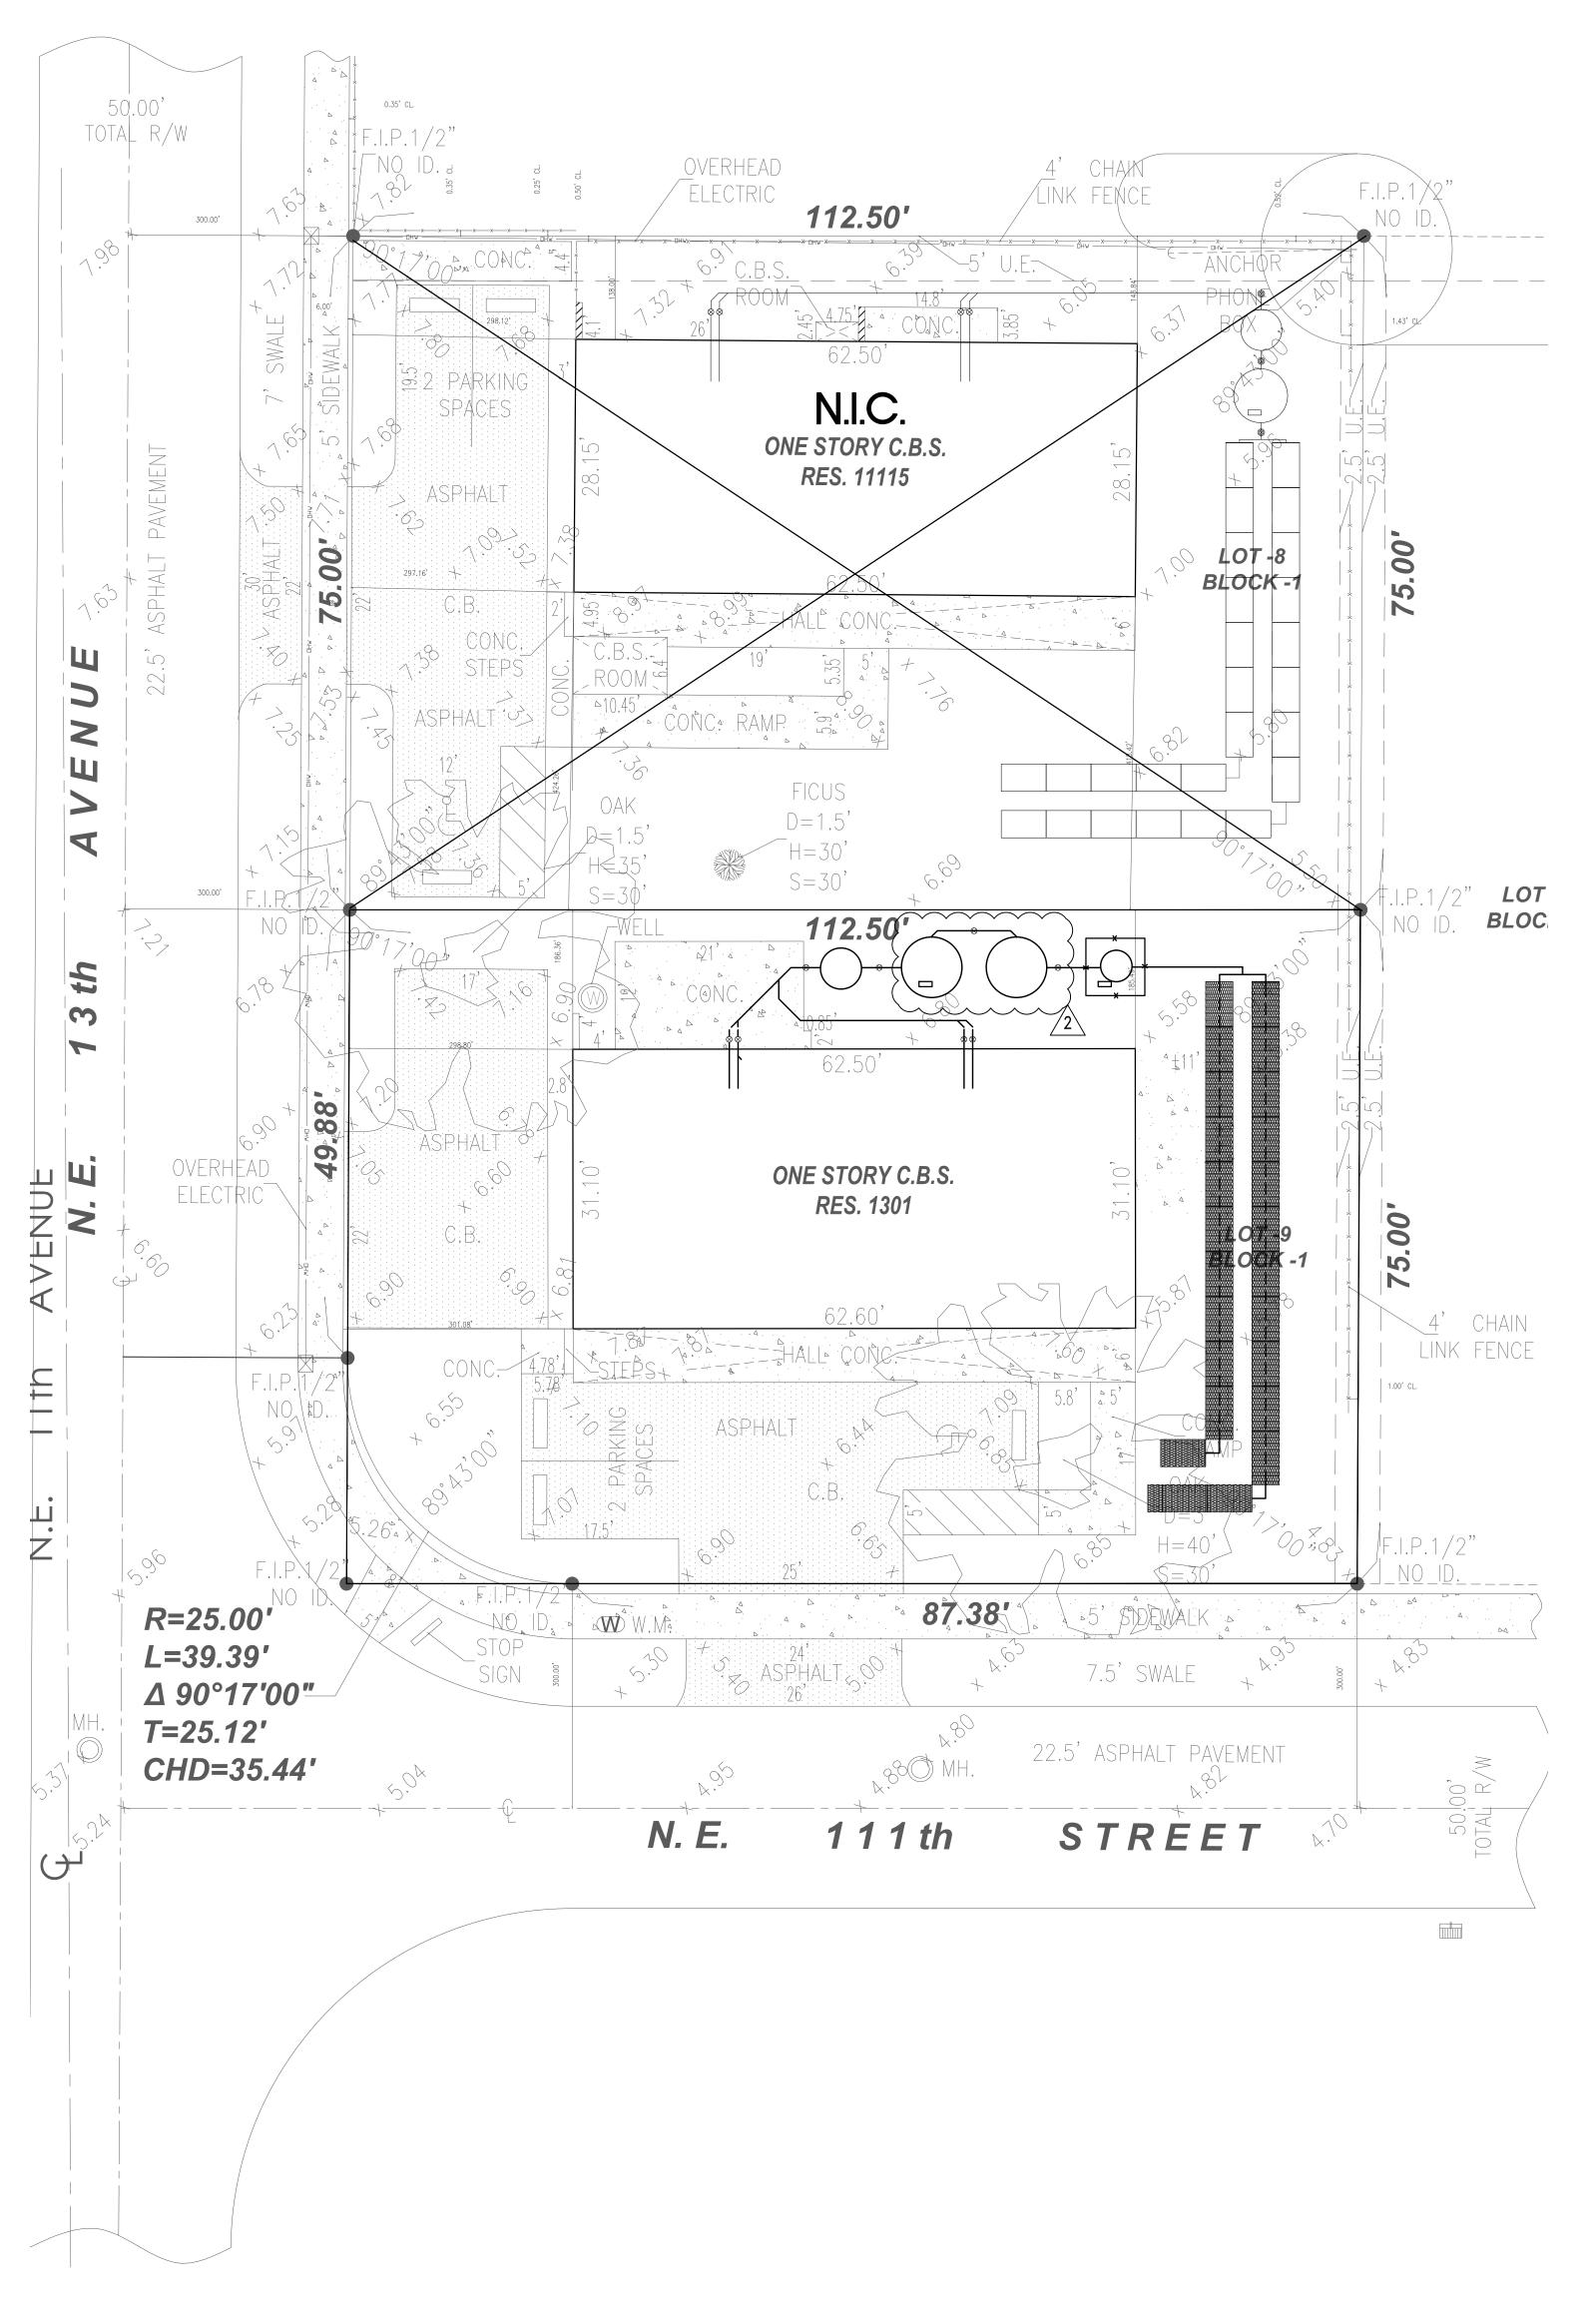

PLUMBING SITE PLAN 3/32" = 1'-0"

A L L E G U E Z ARCHITECTURE, INC.

ARCHITECTURE PLANNING
INTERIOR DESIGN
CONSTRUCTION MANAGEMEN

901 PONCE DE LEON BLVD., SUITE 202 CORAL GABLES, FLORIDA 33134 (305) 461 4001 (FAX) 461 6002 E-MAIL alleguez@bellsouth.net

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PROJECT

CITY OF MIAMI LIFE QUEST RENOVATIONS 1301 NE 111 ST.

MIAMI, FL

SEPTIC TANK SITE AND NEW WORK PLAN

ROBERT BETANCOURT P.E. (MECHANICAL)
LICENSE NO. 34788

my professional judgement and to the best of my knowledge and belief

February 05, 2015

1 06-15-15 DOH. COMMENTS 2 07-24-15 DOH. COMMENTS

SHEET NO

P-6

HVAC GENERAL NOTES

- 1. THE WORK THAT IS TO BE DONE UNDER THIS HEADING INCLUDES THE FURNISHING OF ALL LABOR, MATERIALS AND EQUIPMENT PERMITS, FEES, INSPECTIONS, TEST, INSURANCE, ETC., REQUIRED FOR THE COMPLETION OF THE AIR CONDITIONING HEATING AND VENTILATION SYSTEMS SHOWN ON DRAWINGS OR LISTED BELOW.
- 2. THE DRAWINGS ARE GENERALLY DIAGRAMMATIC. THEY DO NOT SHOW EVERY BEND, OFF—SET, ELBOW OR OTHER FITTINGS WHICH MAY BE REQUIRED FOR THE INSTALLATION IN THE SPACE ALLOCATED, OR FOR COORDINATION WITH OTHER TRADES.
- 3. DRAWINGS ARE NOT TO BE SCALED. UNLESS SPECIFIC DIMENSIONS ARE SHOWN, THE ARCHITECTURAL AND/OR STRUCTURAL DRAWINGS, AND SITE CONDITIONS SHALL GOVERN EXACT LOCATION OF MECHANICAL EQUIPMENT AND APPURTENANCES.
- 4. INTENT:
- IT IS THE INTENT OF THE PLANS AND GENERAL NOTES TO PROVIDE A COMPLETE AND OPERATING INSTALLATION INCLUDING ALL NECESSARY ITEMS REQUIRED, EVEN THOUGHT ITEMS ARE NOT INDICATED ON THE DRAWINGS OR IN THE NOTES. WORK CONSIDER NECESSARY FOR THE COMPLETION OF THE WORK IN PROPER MANNER NOT SHOWN ON THE PLANS OR NOTES SHALL BE BROUGHT TO THE ATTENTION OF THE ARCHITECT/ENGINEER IN WRITING PRIOR TO BIDS OTHERWISE WORK SHALL NOT BE ADDITIONALLY CHARGED AFTER BID IS AWARDED.
- 5. DEFINITIONS:
- A. PROVIDE MEANS TO FURNISH AND INSTALL.
 B.UNDER THIS SECTION MEANS IT IS THE RESPONSIBILITY OF THE CONTRACTOR AND IS TO BE DONE BY AND PAID FOR BY THE CONTRACTOR.
 C. BY THIS SECTION MEANS IT IS THE RESPONSIBILITY OF THE CONTRACTOR AND IS TO BE DONE
- 6. INDOOR AIR QUALITY PRECAUTIONS:

BY AND PAID FOR BY THE CONTRACTOR.

- A. THE CONTRACTOR SHALL ALLOW FOR NECESSARY VENTILATION DURING CONSTRUCTION TO AVOID INDOOR AIR POLLUTION.
- B. THE CONTRACTOR SHALL PREPARE WRITTEN DIRECTION BY WHICH THE BUILDING OWNER OR ITS REPRESENTATIVE WILL BE ABLE TO OPERATE THE VENTILATION SYSTEMS AT ITS OPTIMAL LEVEL.
- 7. OUTDOOR AIR QUALITY PRECAUTIONS:
 THE CONTRACTOR SHALL ALLOW FOR NECESSARY PRECAUTIONS DURING CONSTRUCTION AND
 THEREAFTER FOR THE INSTALLATION AND HANDLING OF REFRIGERANTS. THE CONTRACTOR SHALL
 PREPARE WRITTEN DIRECTIONS BY WHICH THE BUILDING OWNER OR ITS REPRESENTATIVE WILL BE
 ABLE TO HANDLE REFRIGERANT IN A SAFE AND APPROVED MANNER.
- 8. SUBMIT A COMPLETE "AS-BUILT" RECORD SET IN ELECTRONIC AUTOCAD DWG FILE'S FORM TO ARCHITECT/ ENGINEER FOR REVIEW PRIOR TO FINAL PAYMENT REQUISITION.
- 9. A. HVAC EQUIPMENT, AIR DISTRIBUTION, FANS MATERIALS, ETC., SHALL BE AS LISTED HEREIN AND/OR SHALL BE AS SCHEDULED ON THE DRAWINGS.

 B. MANUFACTURERS USE FOR THE BASIS OF DESIGN ARE LISTED ON THE DRAWING SCHEDULE, ANY OTHER MUST MEET OR EXCEED ALL SPECIFIED REQUIREMENTS. NAMING ACCEPTABLE MANUFACTURERS DOES NOT RELIEVE CONTRACTOR FROM COMPLIANCE WITH ALL DESIGN REQUIREMENTS SHOWN ON DRAWINGS OR LISTED HEREIN.
- 10. CUT ALL OPENINGS, CHASES, TRENCHES, ETC. REQUIRED TO ACCOMMODATE THE WORK UNDER THIS DIVISION AND REPAIR ALL WALLS, ROOF, ETC. DAMAGED BY SUCH CUTTINGS. ALL WORK DONE UNDER THIS HEADING MUST CONFORM IN EVERY RESPECT TO FINISH AND QUALITY OF MATERIALS AND WORKMANSHIP SPECIFIED UNDER APPROPRIATE SECTIONS FOR THIS BUILDING.
- 11. VERIFY ALL VOLTAGES WITH ELECTRICAL CONTRACTOR BEFORE ORDERING ANY EQUIPMENT.
- 12. SUBMIT SHOP DRAWINGS OF ALL MATERIALS, DUCTWORK AND EQUIPMENT FOR REVIEW BY ARCHITECT/ENGINEER PRIOR TO FABRICATION AND/OR INSTALLATION.
- 13. CONTRACTOR SHALL VERIFY SPACE CONDITIONS AND DIMENSIONS AND SHALL COORDINATE WORK WITH ALL OTHER TRADES AT JOB SITE PRIOR TO FABRICATION AND INSTALLATION OF DUCTWORK. THE CONTRACTOR SHALL BE RESPONSIBLE FOR THE FULL COORDINATION OF THIS WORK WITH THAT OF ALL OTHER TRADES.
- 14. OBTAIN FULL INFORMATION REGARDING PECULIARITIES AND LIMITATIONS OF SPACE AVAILABLE FOR INSTALLATION OF THE EQUIPMENT AND MATERIALS UNDER THIS CONTRACT, AND PROVIDE READY ACCESSIBILITY TO DAMPERS, VALVES AND OTHER APPARATUS, INCLUDING ANY PART OF SYSTEM REQUIRED TO BE REACHED FOR MAINTENANCE AND OPERATIONS.

15.DUCTWORK:

- A. TOILET AND DRYER EXHAUST DUCTWORK SHALL BE CONSTRUCTED OF SOLID ZINC COATED GALVANIZED SHEET METAL CONSTRUCTED IN ACCORDANCE WITH THE LATEST A.S.H.R.A.E. GUIDE AND S.M.A.C.N.A. RECOMMENDATIONS.
- D. ALL DUCT SIZES SHOWN ARE CLEAR INSIDE (AIRSIDE) DIMENSIONS.
- E. ALL DUCT ELBOWS SHALL BE FITTED WITH TURNING VANES (EXCEPT DRYER EXHAUST WHICH SHALL BE LONG SMOOTH ROUND ELBOW).

16. INSULATION:

- A. PIPING CONDENSATE PIPING PIPING SHALL BE INSULATED WITH 3/4" FIRE RATED FLEXIBLE FOAM INSULATION. FINISH WHERE EXPOSED WITH 2 COATS OF WHITE LATEX PAINT AS PER THE MANUFACTURER'S INSTRUCTION.
- 17. FLAME AND SMOKE RATING: ALL INSULATION PRODUCTS USED INSIDE THE BUILDING SHALL HAVE A MAXIMUM FLAME SPREAD RATING OF 25 AND A MAXIMUM SMOKE GENERATION OF 50 IN ACCORDANCE WITH TESTS OUTLINED IN N.F.P.A. #255.

18. FILTERS:

- A. PROVIDE TWO SETS OF TEMPORARY FIBERGLASS THROWAWAY FILTERS OF THE SAME THICKNESS AS FINAL FILTERS FOR USE DURING CONSTRUCTION.
- B. PROVIDE TWO COMPLETE SETS OF FINAL FILTERS.
- 19. VIBRATION ISOLATORS:
- A.CONDENSING UNITS SHALL BE MOUNTED ON 1" THICK NEOPRENE PADS, THRU-BOLTED TO HOT DIPPED GALVANIZED WELDED STEEL ANGLE.

20.CONTROLS:

- A. ALL ELECTRIC WIRING AND CONDUIT SHALL BE PROVIDED BY THE ELECTRICAL CONTRACTOR. B. WIRELESS THERMOSTAT SHALL BE HEAT—COOL PROGRAMMABLE WITH FAN AND SELECTOR SWITCHES.
- 21. ALL EQUIPMENT AND MATERIALS SHALL BE GUARANTEED FOR THE PERIOD OF ONE YEAR. COMPRESSORS SHALL CARRY 5 YEAR FACTORY GUARANTEE. FURNISH 90 DAYS FREE SERVICE.
- 22. ALL FAN DRIVES SHALL BE ADJUSTED TO DELIVER THE SPECIFIED CFM AGAINST THE ACTUAL STATIC PRESSURE OF THE INSTALLATION.
- 23. ALL WORK SHALL BE COORDINATED WITH THE WORK OF OTHER TRADES TO AVOID INTERFERENCE WITH PROGRESS OF CONSTRUCTION AND IN STRICT COMPLIANCE WITH ALL APPLICABLE CODES AND STANDARDS
- 24. ALL OUTSIDE EQUIPMENT SHALL BE SECURED TO WITHSTAND 170 MPH HURRICANE FORCE WINDS.
- 26. TESTING:

 A. BALANCE AIR SYSTEM TO DELIVER SPECIFIED QUANTITIES AT EACH OUTLET WITHIN 10% USING A.A.B.C. PROCEDURES AND TESTS. SUBMIT AIR BALANCE TEST RESULTS FOR REVIEW PRIOR TO FINAL INSPECTION AND ACCEPTANCE.

 B. SUBMIT SHOP DRAWINGS OF ALL MATERIALS, DUCTWORK AND EQUIPMENT FOR REVIEW PRIOR
- INSPECTION AND ACCEPTANCE.

 B. SUBMIT SHOP DRAWINGS OF ALL MATERIALS, DUCTWORK AND EQUIPMENT FOR REVIEW PRIOR INSTALLATION AND/OR FABRICATION.

 C. ALL WORK SHALL BE DONE IN ACCORDANCE WITH THE LATEST EDITION OF THE STANDARD BUILDING CODE NFPA 90A, 90B AND ALL APPLICABLE LOCAL CODES AND ORDINANCES.

 E. CONTRACTOR SHALL BE RESPONSIBLE TO TEST AND BALANCE THE SYSTEM TO ACHIEVE RATES AS SHOWN ON PLANS AND SCHEDULES. TEST/BALANCE RESULTS SHALL BE SUBMITTED TO ARCHITECT/ENGINEER FOR REVIEW PRIOR TO FINAL PAYMENT REQUISITION.
- 26. FANS (COOK IS THE BASIS OF DESIGN)
- A. PROVIDE FANS AS SCHEDULED ON DRAWINGS
- B. INSTALLATION
- INSTALL FANS IN ACCORDANCE WITH MANUFACTURER'S RECOMMENDATIONS.
- 2. LOCATE EXHAUST FANS A MINIMUM OF 10'-0" (HORIZONTAL DISTANCE) AWAY FROM ANY OUTSIDE AIR INTAKE, OPERABLE WINDOW AND/OR DOOR.
- 3. PROVIDE CONTROL LOW VOLTAGE TRANSFORMERS, TEN MINUTE TIME—OFF DELAY RELAYS AND BACK
- 30. THRU THE WALL AIR CONDITIONERS (FRIEDRICH IS THE BASIS OF DESIGN)

DRAFT DAMPERS, SEAL ALL STRUCTURAL ROOF AND WALL OPENINGS AIR AND WATER TIGHT.

- UNITS SHALL BE PROVIDED WITH:
- A. SEA COAST PROTECTION. (10,000 HOURS MINIMUM)
 B. WIRELESS REMOTE CONTROL, 3 SPEED FAN CONTROL AND PROGRAMMABLE TIMER,
- WIRELESS REMOTE CONTROL, 3 SPEED FAN CONTROL AND PROG
 OUTSIDE AIR DUCT WITH DAMPER SET @ 30 CFM.
 INSECT BARRIER, WASHABLE ANTIMICROBIAL AIR FILTER.
- E. STEEL INNER WALL AND EXTRA DENSE INSULATION AND VIBRATION ISOLATION.
 F. INSTALL WALL SLEEVE SLOPED PER MFGR RECOMMENDATIONS.
- G. ENTRY—GARD ANTI—INTRUSTION PROTECTION.
 H. PROVIDE 5 YEARS WARRANTY ON COMPRESSORS BY MANUFACTURER AND ONE YEAR WARRANTY ON
- H. PROVIDE 5 YEARS WARRANTY ON COMPRESSORS BY MANUFACTURER AND ONE YEAR WARRANTY ON PARTS AND LABOR.

 I. SECURE A/C UNITS ON CONCRETE WALL TO WITHSTAND 170 MPH HURRICANE FORCE WINDS

AIR CONDITIONING LEGEND SYMBOL DESCRIPTION THRU THE WALL AIR CONDITION UNIT BTM. воттом COND. CONDENSATE CONC. CONCRETE CFM CUBIC FEET PER MINUTE EXHAUST FAN F.L.A. FULL LOAD AMPS F.P.M. FEET PER MINUTE H.P. HORSEPOWER H.R. HOUR INCH K.W. KILOWATT LBS. POUNDS MAX. MAXIMUM MVDMANUAL VOLUME DAMPER (OPPOSED BLADE) NUMBER O/A OUTSIDE AIR RPM. REVOLUTIONS PER MINUTE RETURN AIR REF. REFRIGERANT S/A SUPPLY AIR TEMP. **TEMPERATURE** AIR DISTRIBUTION DESIGNATION PROGRAMMABLE THERMOSTAT EXHAUST OR RETURN AIR DUCT SECTION OPPOSED BLADE MANUAL VOLUME DAMPER ---1" UNDER CUT DOOR (ALL BEDROOMS AND BATHROOMS)

HVAC DESIGN REQUIRES:	YES	NO
DUCT SMOKE DETECTOR		\times
FIRE DAMPER(S)		$>\!\!<$
SMOKE DAMPER(S)		><
FIRE RATED ENCLOSURE		$>\!\!<$
FIRE RATED ROOF/FLOOR CEILING ASSEMBLY		><
FIRE STOPPING		$>\!\!<$
SMOKE CONTROL SUPPLY		><


BUILDING DATA (SEE ARCH DV	VGS)
WALL R VALUE	R-5
GLASS (ARGON/LOW E) U VALUE	U-0.97
GLASS (ARGON/LOW E) SHGC.	SHGC-0.36
ROOF R VALUE	R-30
NOTE	

NOTE:


1. ALL R AND U VALUES ARE AS PROVIDED TO THIS ENGINEER

٧	ENTILATION FAN SCHEDU	LE	
UN	IIT DESIGNATION	EF-1	
AR	EA SERVED	SEE PLAN	
OPERATING WEIGHT, LBS.		18	
LO	CATION	CEILING	
FA	n type	CEILING MNTD.	
	TOTAL AIR, CFM DRIVE TYPE	50 DIRECT	
	FAN WHEEL TYPE	CENTRIFUGAL	
	FAN TIP SPEED, FPM MAX.	1125	
	FAN SPEED, RPM	_	
FAN	TOTAL STATIC PRESSURE, IN OF H20	0.125	
LE.	FAN MOTOR WATTS	29 W	
	FAN MOTOR STARTER TYPE	_	
	STARTER FURNISHED BY	CONTRACTOR	
	ELECTRICAL SERVICE AVAILABLE	120/1ø/60	
	SONES	2.4	
	ESIGN MANUFACTURER	COOK — GEMINI	
DE	SIGN MFGR. MODEL NUMBER	LITTLE GEM—I	
	SERVICE SWITCH	YES	
	SMOKE DETECTORS	NO	
ORIES	FIRE DAMPER	NO	
SOF	CONSTRUCTION	GALVANIZED STEEL	
ACCESS (MULTIBLADE BACKDRAFT DAMPER	YES	
ğ	BIRDSCREEN	YES	
	SOLID STATE SPEED CONTROL	NO	
	THERMOSTAT CONTROL	NO	
	FACTORY FABRICATED CURB MODEL No.	NO	
	10 MIN. TIME OFF DELAY RELAY	YES	

NOTES: 1— PROVIDE ALUMINUM EXHAUST GRILLE (TYP.)
2— ACCEPTABLE MANUFACTURERS COOK, GREENHECK OR PENN
3— EXHAUST FANS SHALL BE INTERLOCKED WITH CORRESPONDING LIGHT SWITCH (TYP.)

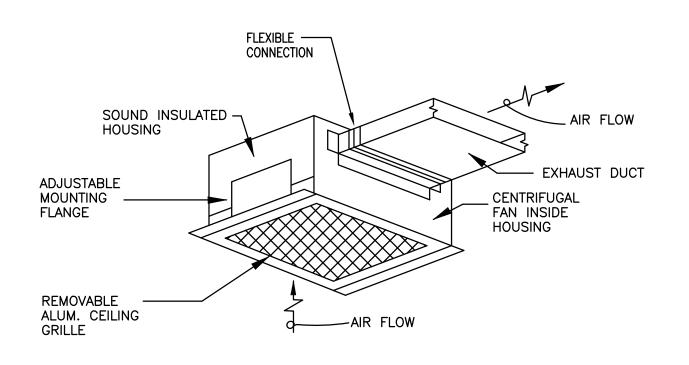

TYPICAL CEILING TYPE EXHAUST FAN DETAIL N.T.S.

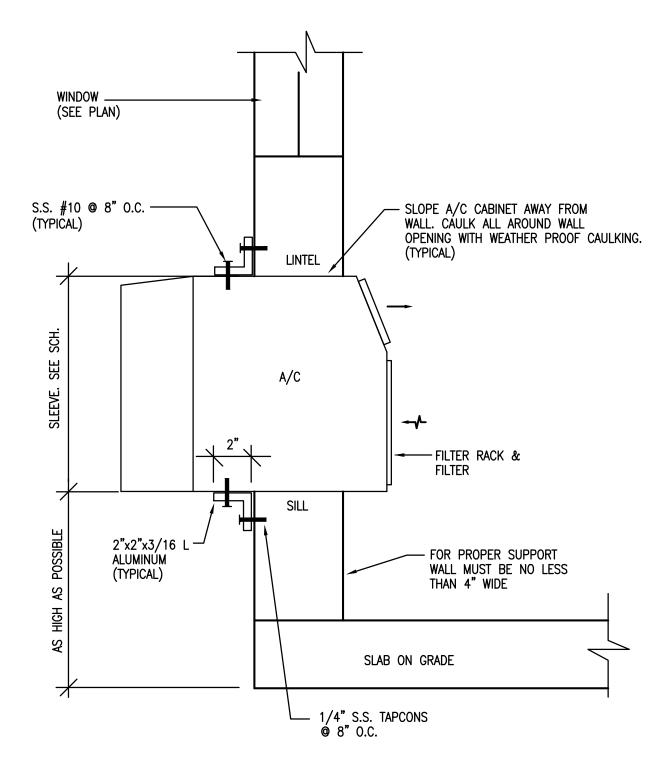

WINDOW TYPE UNIT MOUNTING DETAIL


NOTE:

1. INSTALL PER MANUFACTURER RECOMMENDATION
2. CAULK / SEAL ALL AROUND THE SLEEVE (PENETRATION).
3. PROVIDE ENTRY—GARD ANTI INSTRUCTION PROTECTION.

ROOM TYPE A/C U	NIT SCHED	ULE
UNIT DESIGNATION	A/C-1301-1B A/C-1301-4B	A/C-1301-1A A/C-1301-4A A/C-1301-2 A/C-1301-3
MOUNTING TYPE	THRU THE WALL	THRU THE WALL
AREA SERVED	SEE PLAN	SEE PLAN
DESIGN MANUFACTURER	FRIEDRICH	FRIEDRICH
UNIT TYPE	ELECTRIC HEATER	HEAT PUMP
DESIGN MFG. MODEL NO.	EQ08N11	YS12N33
AIR FLOW (CFM)	175	265
OUTSIDE AIR FLOW (CFM)	30	30
COOLONG CAPACITY BTU/HR.	7,600	11,500/11,300
AIR ENTERING EVAPORATOR OF DB/WB	80/67	80/67
AIR LIVING EVAPORATOR OF DB/WB	56/-	56/-
ELECTRIC HEATING CAPACITY BTU/HR	4,000	-
HEAT PUMP CAPACITY BTU/HR	-	9,400/9,000
COP / HSPF	-	2.4/8.2
ELECTRICAL SERVICE AVAILABLE	115-1-60	230-1-60
UNIT TOTAL AMPS, F.L. COOL/HEAT	6.9 / 11.2	5.4/5.8
ENERGY EFFICIENCE RATIO (E.E.R.) MIN.	10.5	10.5
WEIGHT LBS.	84 LBS	136 LBS
SLEEVE	YES	YES
REFRIGERANT	R-410A	R-410A
DIMENSIONS (HxWxD)	-	16x26x29

NOTES:

- ALL A/C UNITS SHALL BE PROVIDED WITH OUTSIDE AIR DAMPER, INSECT BARRIER, WASHABLE ANTIMICROBIAL AIR FILET, STEEL INNER WALL AND EXTRA DENSE INSULATION AND VIBRATION ISOLATION FILTEN.
- 2. UNITS SHALL BE PROVIDED WITH 3 SPEED FAN CONTROL, PROGRAMMABLE TIMER AND WIRELESS REMOTE CONTROL.
- 3. ALL A/C UNIT SHALL BE PROVIDED WITH ENTRYGARD ANTI-INTRUSTION PROTECTION.

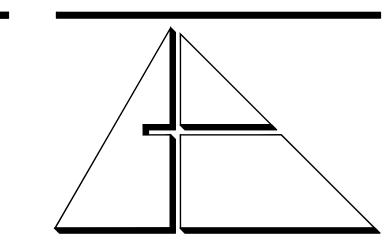

A L L E G U E Z ARCHITECTURE, INC.

ARCHITECTURE PLANNING INTERIOR DESIGN CONSTRUCTION MANAGEMENT

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Certificate of Authorization #3144

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Gartek Project No. 2867

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PROJECT:

CITY OF MIAMI LIFE QUEST RENOVATIONS 1301 N.E. 111 ST.

Owner's Representative:

Lori B. Soto

City of Miami

Department of Community Development
(305) 416-2084
444 SW 2nd Avenue

Miami, FL. 33130

DRAWING TITLE:

MECHANICAL NOTES, SCHEDULES AND DETAILS


P∩P	ERT BETANCOURT P.E. (MECHANICA
KOD	•
_	LICENSE NO. 34788
"In my professi plans and spec	onal judgement and to the best of my knowledge and be ifications comply with applicable Building Codes."
DATE:	September 15,

2014
REVISED:

CAD DRAWING NAME:

SHEET NO.

A A T

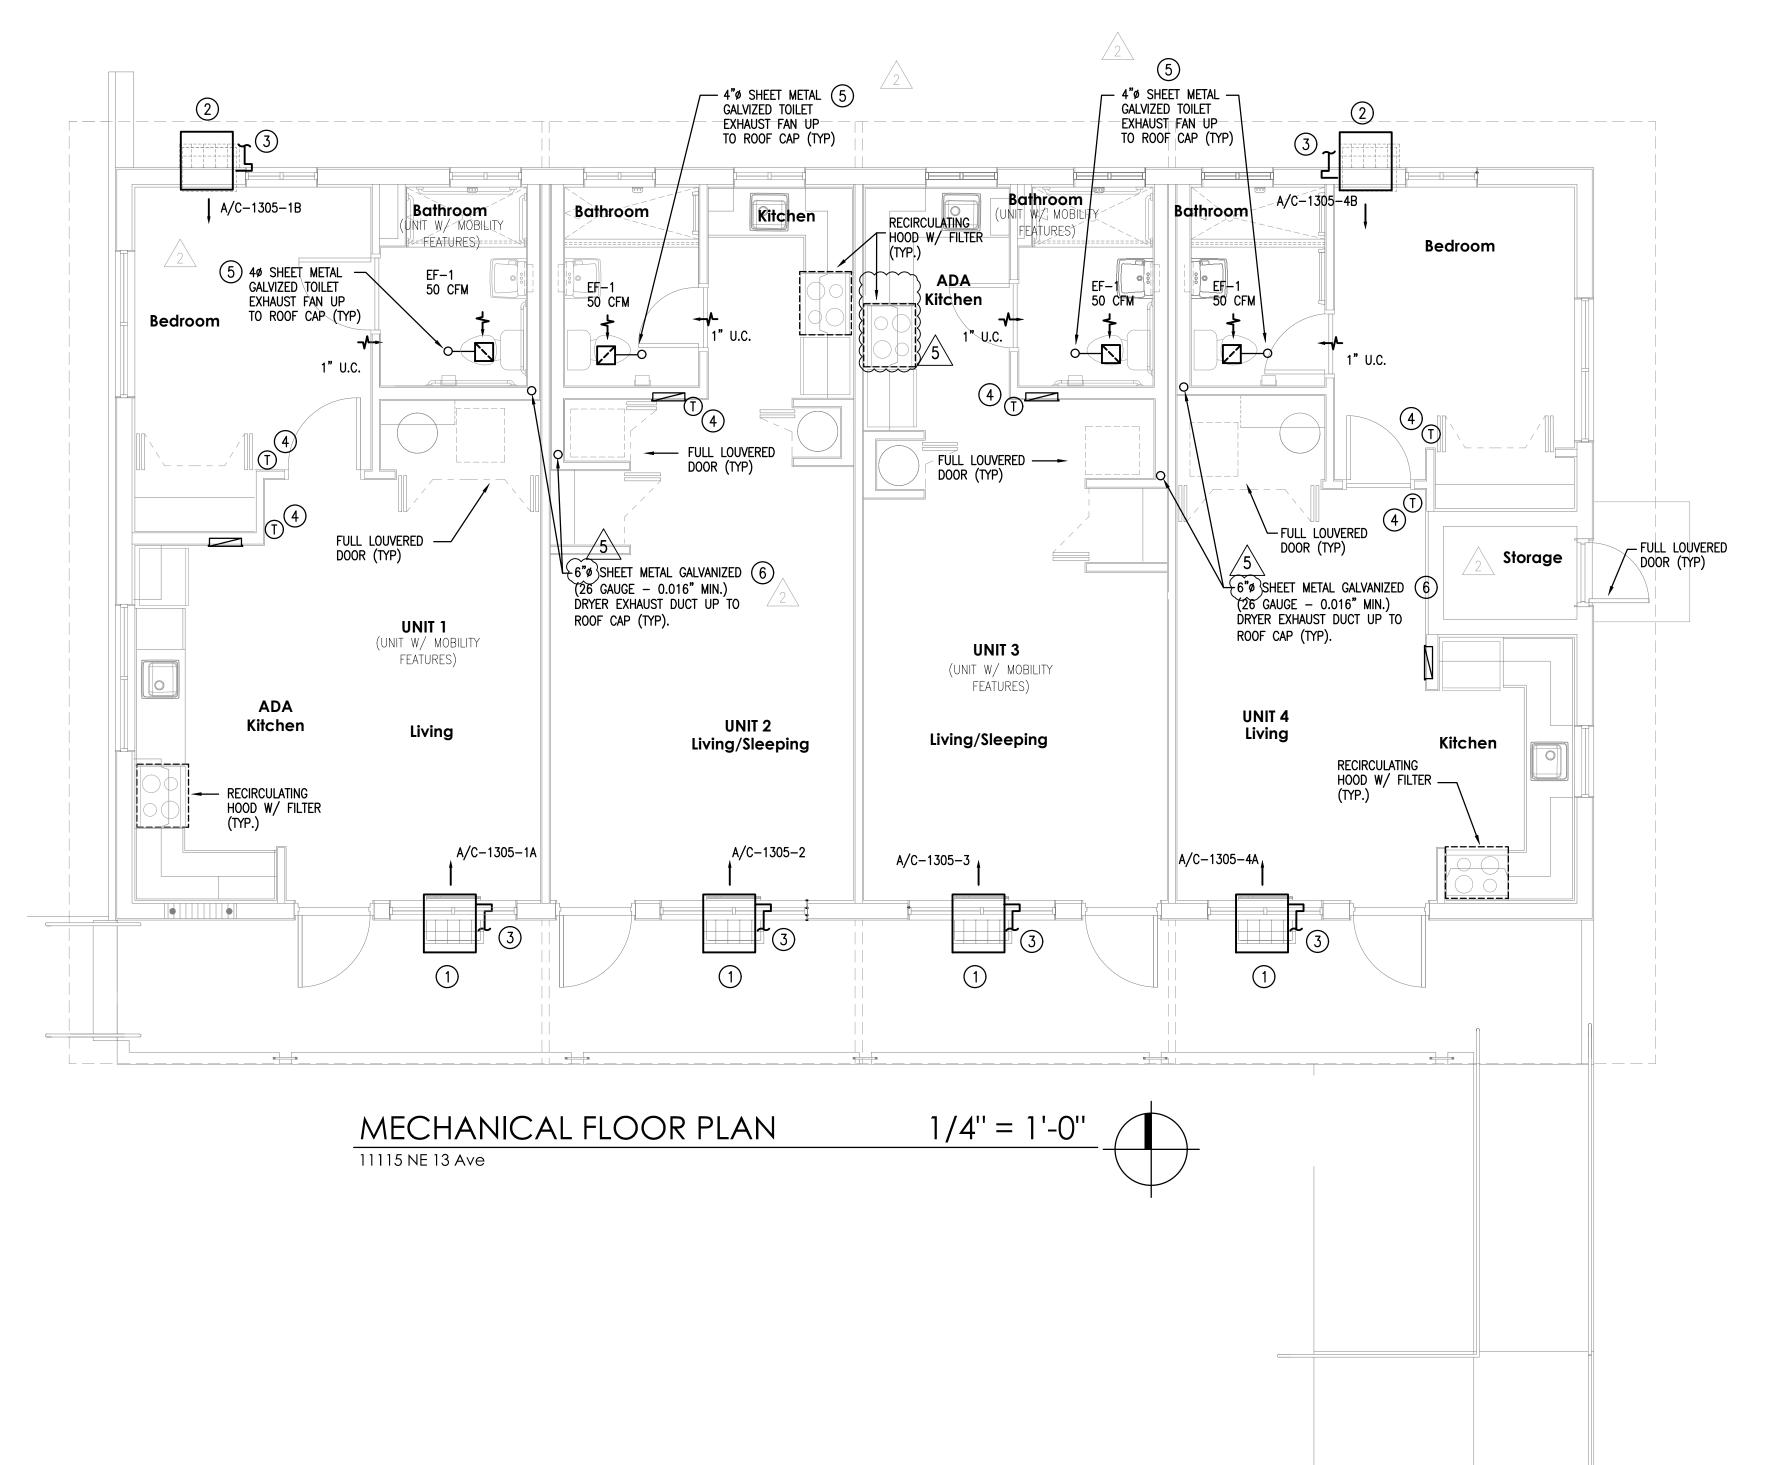

CODED NOTES:

- 1) NEW THRU THE WALL A/C UNIT BELOW EXIST. WINDOW, SEE MOUNTING DETAIL ON DWG M-1 (TYPICAL)
- 2 NEW THRU THE WALL A/C UNIT HIGH MOUNTING. SEE ARCH DWGS. FOR EXACT LOCATION AND DWG M-1 FOR MOUNTING DETAIL. (TYPICAL)
- 3) 2"ø INSULATED CD LINE W/ TRAP. FOR CONT. SEE PLUMBING DWGS. (TYPICAL)
- WIRELESS REMOTE THERMOSTAT, VERIFY EXACT LOCATION IN FIELD. (TYPICAL)
- BATHROOM EXHAUST SYSTEM ROOF CAP SHALL BE PROVIDED WITH A CORROSION RESISTANT SCREEN. (TYPICAL)
- 6 ALL DRYER EXHAUST DUCT SHALL BE PROVIDED WITH SHEET METAL GALVANIZED BACKDRAFT DAMPER. (TYPICAL) NOTE:
- 1. THERMOSTA SHALL BE INSTALLED AT MAX. 48" A.F.F. ON ALL ADA UNITS.

A L L E G U E Z ARCHITECTURE, INC.

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CITY OF MIAMI LIFE QUEST RENOVATIONS 1301 N.E. 111 ST.

> Owner's Representative: Lori B. Soto

City of Miami Department of Community Development (305) 416-2084 444 SW 2nd Avenue Miami, FL. 33130

DRAWING TITLE:

MECHANICAL FLOOR PLAN


ROBERT BETANCOURT P.E. (MECHANICAL) LICENSE NO. 34788 "In my professional judgement and to the best of my knowledge and belief, these plans and specifications comply with applicable Building Codes."

September 15, 2014

REVISED: 10-20-13 BACKGROUND CHANGE
2 12-13-13 BLDG. DEPT. COMMENTS
5 01-16-17 PLAN UPDATE

LUMINAIRE SCHEDULE Lumens LLF Symbol Label Catalog Number Description ONE 175-WATT CLEAR **LITHONIA** Area Luminaire, 175W 14400 0.75 LIGHTING KAD BT-28 METAL HALIDE, MH, High Performance HORIZONTAL POSITION. 175M SR3 POLE SR3 Reflector, Full Cutoff MTD. 15' A.G. MEETS THE 'NIGHTTIME FRIENDLY' CRITERIA

STATISTICS						
Description	Symbol	Avg	Max	Min	Max/Min	Avg/Min
PARKING AREA 2	+	3.9 fc	8.2 fc	1.1 fc	7.5:1	3.5:1

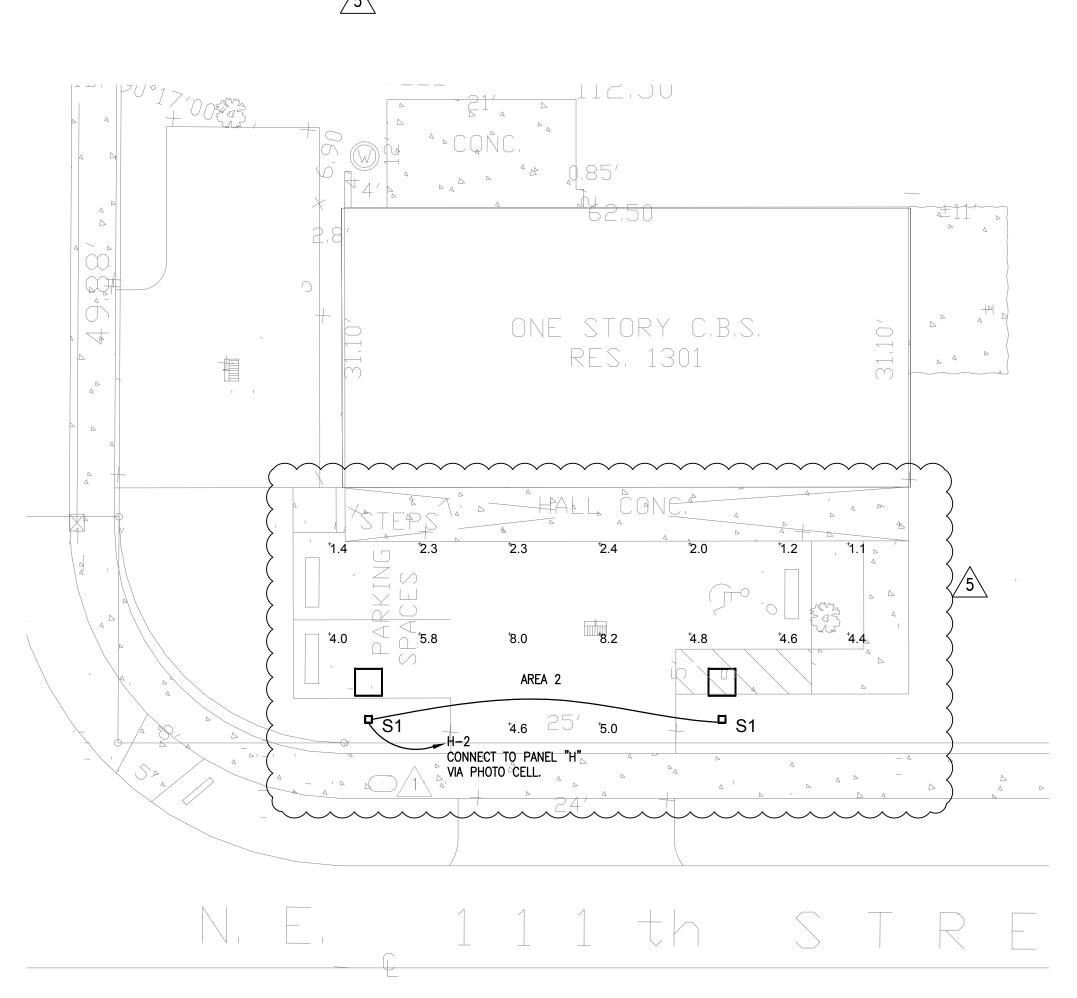

I. GENERAL REQUIREMENTS

MANUFACTURER

LITHONIA

LITHONIA

LITHONIA

LITHONIA

WAVE

LITHONIA

LIGHT FIXTURE TYPE

AS PER SCHEDULE.

- INTEGRAL RACEWAY.

INTEGRAL HANDHOLE

- CADWELLD #6 CU (C)
CONDUCTOR TO 8'-0" CC

GROUND ROD. BOND ALL

GROUNDING CONDUCTORS.

-AUGURED HOLE AND COMPACTED BACKFILL.

WITH COVER

LIGHT POLE DETAIL

SHOWN, THE STRUCTURAL, ARCHITECTURAL, AND SITE CONDITIONS SHALL GOVERN THE EXACT LOCATIONS. CONTRACTOR SHALL FOLLOW DRAWINGS IN LAYING OUT WORK, CHECK DRAWINGS F ALL TRADES TO VERIFY SPACES IN WHICH WORK WILL BE INSTALLED. WHERE HEADROOM OR SPACE CONDITIONS APPEAR INADEQUATE, CONTRACTOR SHALL, WITHOUT EXTRA
CHARGE, MAKE FIELD MODIFICATION IN LAYOUT AS NEEDED TO PREVENT CONFLICT WITH WORK
OF VARIOUS TRADES OR FOR PROPER EXECUTION OF THE WORK. SITE CONDITIONS SHALL
GOVERN THE EXACT LOCATION OF ALL ELECTRICAL EQUIPMENT, DEVICES, WIRING, CONDUIT,

ONE COMPLETE SET OF DRAWINGS AND SPECIFICATIONS SHALL BE KEPT ON FILE AT THE SITE FOR THE SOLE USE OF MARKING AS-BUILT DATA. ALL CHANGES SHALL BE MARKED IN RED ON PRIOR TO EACH REQUISITION FOR PAYMENT, AS—BUILT PRINTS SHALL BE BROUGHT UP TO DATE FOR ACCEPTANCE BY OWNER'S REPRESENTATIVE. THE COMPLETED SET OF AS-BUILT PRINTS SHALL BE DELIVERED TO THE ARCHITECT/ENGINEER PRIOR TO FINAL PAYMENT FOR INCORPORATION ONTO ORIGINALS. RISERS ARE DIAGRAMMATIC AND DON'T INTEND TO SHOW EVERY BEND REQUIRED FOR THE

B. COORDINATION. CONTRACTOR WILL BE REQUIRED TO FURNISH, INSTALL AND/OR CONNECT WITH APPROPRIATE SERVICES ALL ELECTRICAL ITEMS SHOWN ON ANY OF THE ARCHITECTURAL, PLUMBING, AIR CONDITIONING SPRINKLER, INTERIOR DESIGN AND ELECTRICAL DRAWINGS WITHOUT ADDITIONAL EXPENSE TO THE OWNER. IF DISCREPANCIES, CONFLICTS, INTERFERENCES OR OMISSIONS OCCUR BETWEEN DRAWINGS, NOTIFY IN WRITING THE ARCHITECT/ENGINEER IN AMPLE TIME TO PERMIT REVISIONS BEFORE THE BIDS ARE

ELECTRICAL CONTRACTOR SHALL COORDINATE THE REQUIREMENTS OF PLUG AND CHORD TYPE EQUIPMENT WITH MANUFACTURER AND IS REQUIRED TO PROVIDE ELECTRICAL OUTLETS THAT WILL ACCEPT MANUFACTURER'S SUPPLIED PLUGS. SEE MECHANICAL DRAWINGS FOR ELECTRICAL REQUIREMENTS AND LOCATION OF A/C UNITS AND ALL OTHER MECHANICAL EQUIPMENT (SOLENOIDS, VAV'S, THERMOSTATS, PUMPS, FANS, SMOKE DETECTORS, DUCT HEATERS, ETC.) THE CONTRACTOR SHALL PROVIDE ALL BRANCH CIRCUIT AND CONTROL WIRING AS INDICATED OR REQUIRED AND IN CONFORMANCE WITH N.E.C. ARTICLE 440 AND MANUFACTURER'S RECOMMENDATIONS. ALL PENETRATIONS SHALL BE MADE WEATHERPROOF DURING CONSTRUCTION AND AFTER FINAL INSTALLATION. A/C EQUIPMENT WIRING, BREAKERS, AND FUSES ARE BASED ON A/C EQUIPMENT SPECIFIED ON CONTRACT DRAWINGS. CONTRACTOR IS RESPONSIBLE FOR PROVIDING ALL WIRING, AND OVERCURRENT PROTECTION REQUIREMENTS IF EQUIPMENT USED IS DIFFERENT FROM THAT SPECIFIED. CONTRACTOR SHALL MAKE THESE CHANGES AT NO ADDITIONAL COST TO THE OWNER.

C. PERMITS. THE CONTRACTOR SHALL SECURE AND PAY FOR ALL PERMITS, STATE SALES TAX, FEDERAL EXCISE TAX, ROYALTIES AND OTHER TAXES OR FEES AS REQUIRED FOR NSTALLATION OF A COMPLETE SYSTEM AS OUTLINED HEREIN AND AS SHOWN ON THE PLANS. THE CONTRACTOR SHALL SECURE ALL NECESSARY LICENSES AND INSURANCE. D. BASIS FOR BIDS. EQUIPMENT SPECIFIED SHALL BE ADHERED TO. HOWEVER, OWNER HAS FINAL DECISION ON THE TYPE AND QUALITY OF EQUIPMENT TO BE SUPPLIED. WITHIN 30-DAYS AFTER THE CONTRACT HAS BEEN EXECUTED. A FORMAL REQUEST FOR THE SUBSTITUTION OF PRODUCTS IN PLACE OF THOSE SPECIFIED WILL BE CONSIDERED, UNDER THE

THE REQUEST IS ACCOMPANIED BY COMPLETE DATA ON THE PROPOSED SUBSTITUTION SUBSTANTIATING COMPLIANCE WITH THE CONTRACT DOCUMENTS INCLUDING PRODUCT IDENTIFICATION AND DESCRIPTION, PERFORMANCE AND TEST DATA, REFERENCES AND SAMPLES WHERE APPLICABLE, AND AN ITEMIZED COMPARISON OF THE PROPOSED SUBSTITUTION WITH THE PRODUCTS SPECIFIED, WITH DATA RELATING TO CONTRACT TIME SCHEDULE, DESIGN AND AESTHETIC EFFECT WHERE APPLICABLE. THE REQUEST IS ACCOMPANIED BY ACCURATE COST DATA ON THE PROPOSED SUBSTITUTION IN COMPARISON WITH THE PRODUCT SPECIFIED, WHETHER OR NOT MODIFICATION OF THE CONTRACT SUM IS TO BE A CONSIDERATION. IF REDESIGN BY THE ARCHITECT OR HIS CONSULTANTS IS REQUIRED TO ACCOMMODATE AN ALTERNATE PRODUCT OR SYSTEM, ALL COSTS OF THIS REDESIGN SHALL BE BORNE BY THE CONTRACTOR REQUESTING THE CHANGE. IF ADDITIONAL WORK IS REQUIRED BY OTHER CONTRACTORS TO ACCOMMODATE AN ALTERNATE PRODUCT OR SYSTEM, ALL ADDITIONAL COSTS OF THIS WORK SHALL BE BORNE BY THE CONTRACTOR

THE REQUEST SHALL BE ACCEPTED OR REJECTED SOLELY AT THE DISCRETION OF THE OWNER WITH ARCHITECT'S OR ENGINEER'S WRITTEN APPROVAL. E. CODES & STANDARDS. THE WORK PERFORMED UNDER DIVISION 16 SHALL COMPLY WITH THE LATEST EDITION AND REQUIREMENTS OF THE FOLLOWING: APPLICABLE LOCAL CODES AND ORDINANCES, NATIONAL ELECTRICAL CODE, AS AMENDED BY LOCAL CODE, ALL APPLICABLE FEDERAL AND STATE CODES, REGULATIONS AND STATUTES, APPLICABLE ENERGY CODE, OCCUPATIONAL SAFETY AND HEALTH ACT (OSHA), NATIONAL FIRE PROTECTION ASSOCIATION (NFPA), NATIONAL ELECTRICAL MANUFACTURERS ASSOCIATION (NEMA), UNDERWRITERS LABORATORIES, INC. (UL), AMERICAN NATIONAL STANDARDS INSTITUTE (ANSI), AMERICANS WITH

F. MATERIALS & EQUIPMENT. MATERIAL AND EQUIPMENT SHALL BE NEW, STANDARD, CURRENT PRODUCTS OF MANUFACTURERS REGULARLY ENGAGED IN THE PRODUCTION OF SUCH EQUIPMENT, AND SHALL BE THE MANUFACTURER'S LATEST DESIGN. ALL MATERIALS SHALL BEAR THE LABEL OF THE UNDERWRITERS LABORATORY FOR THE INTENDED USE OR SHALL BE MATERIALS APPROVED BY THE CODE ENFORCING AUTHORITIES AND THE ARCHITECT.

DESCRIPTION

HALLWAY FIXTURES

RESTROOM FIXTURE

KITCHEN FIXTURE

VANITY FIXTURE

EXTERIOR ENTRY FIXTURE

EXTERIOR SPOT LIGHTS

THE LUMINAIRE(S) AND POLE INSTALLATION SHALL MEET THE

CONTRACTOR SHALL SUBMIT A SIGNED AND SEALED LETTER BY A REGISTERED ENGINEER IN THE STATE OF FLORIDA,

INDICATING COMPLIANCE WITH CODE REQUIREMENTS FOR THE INSTALLATION. PROVIDE EMBEDMENT DEPTH AS REQUIRED BY

WIND LOAD CALCULATIONS. SUBMIT CALCULATIONS WITH SHOP

APPLICABLE FBC LOAD WITHSTAND REQUIREMENTS. THE

DRAWINGS SIGNED AND SEALED BY FLORIDA REGISTER

SLIP FITTER POLE GROUND BROUGHT OUT THRU TENON.

BOND TO LUMINAIRE

ENGINEER.

INTERNALLY. -

MANUFACTURER. -

DIRECT BURIAL TAPERED. TYPE II PRECAST CONCRETE POLE 15 FT ABOVE GRADE. STORE AND INSTALL AS RECOMMENDED BY POLE

8 CU. CAST IN POLE

CIRCUIT GROUNDING

CONDUCTOR.—

BRANCH CONDUIT

DEPTH AS REQUIRED

GROUND WIRE. LOOP THRU HANDHOLE. CONNECT TO

FOLLOW THE INSTALLATION DIRECTIONS AND RECOMMENDATIONS OF MATERIAL AND EQUIPMENT MANUFACTURERS.

GENERAL ELECTRICAL NOTES

ALL WORK SHALL BE PERFORMED BY WORKERS SKILLED IN THEIR RESPECTIVE TRADES AND ALL MATERIALS AND EQUIPMENT SHALL BE INSTALLED IN ACCORDANCE WITH MANUFACTURER'S SUCH THAT REMOVAL OR REPLACEMENT MAY BE READILY ACCOMPLISHED WITHOUT DAMAGE

IDENTIFY ALL EQUIPMENT, INCLUDING SAFETY SWITCHES, STARTERS, TRANSFORMERS, PANELS, TERMINAL BOXES, MOTORS, SPECIAL OUTLETS, RELAYS. IDENTIFICATION SHALL CORRESPOND TO THE TERMINOLOGY ON THE CONTRACT DOCUMENTS.

G. SUPPORTING DEVICES, DEVICES, INCLUDING ANCHORS, FASTENERS, HANGERS AND SUPPORTS, SHALL BE OF A TYPE DESIGNED OR FABRICATED FOR THE PURPOSE, AND SHALL ADEQUATELY AND SAFELY SECURE THE MATERIAL AND EQUIPMENT AND PRESENT A NEAT APPEARANCE. USE DEVICES WITH CORROSION RESISTANT CHARACTERISTICS FOR THE

H. RACEWAYS & BOXES. ROUTING OF RACEWAYS, INTERCONNECTING OUTLETS AND HOME—RUNS IS UP TO THE ELECTRICAL CONTRACTOR, BUT AFTER COMPLETION OF THE INSTALLATION, HE SHALL SUBMIT TO THE ENGINEER AS—BUILT DRAWINGS OF HIS WORK FOR FUTURE RECORD. DEVICE BOXES SHALL BE INSTALLED FLUSH, CONDUIT SHALL BE CONCEALED UNLESS OTHERWISE INDICATED. ALL CONDUCTORS SHALL BE IN CONDUIT. FOR UNDERGROUND/IN—SLAB LOCATIONS USE GALVANIZED RIGID STEEL (GRS) CONDUIT OR SCHEDULE 40 PVC CONDUIT WITH GROUND WIRE SIZED AS INDICATED OR REQUIRED BY N.E.C., STUB—UPS FROM UNDERGROUND/IN—SLAB PVC CONDUIT SHALL BE GRS. UNDERGROUND GRS SHALL BE COATED WITH TWO COATS OF BITUMASTIC #50 APPLIED WITHOUT THINNING. ALL SECTIONS OF METALLIC CONDUIT SYSTEM SHALL BE GROUNDED AND ELECTRICALLY CONTINUOUS. USE ELECTRICAL METALLIC TUBING (EMT) FOR INTERIOR CONCEALED WIRING AND ELSEWHERE AS PERMITTED BY THE N.E.C. USE SEALITIE FLEXIBLE METAL CONDUIT FOR FLEXIBLE CONNECTIONS IN ALL WET LOCATIONS. INSTALL A NYLON PULL—CORD IN ALL EMPTY RACEWAYS FOR FUTURE USE. SIZE ALL GUTTERS AND PULL—BOXES PER NEC 370 AND 374. ALL PULL AND JUNCTION BOXES SHALL REMAIN ACCESSIBLE AT ALL TIMES.

JUNCTION BOXES SHALL REMAIN ACCESSIBLE AT ALL TIMES. ALUMINUM CONDUIT WILL NOT BE PERMITTED.

MINIMUM SIZE OUTLET BOX SHALL BE 4" SQUARE BY 1-1/2" DEEP UNLESS APPROVED OR USE CAST METAL OUTLET BOXES WITH GASKETED COVERS FOR ALL EXTERIOR AND FOR ALL

PROVIDE APPROVED FIRE STOPPING MATERIALS AT ALL CHASES TO PREVENT DRAFTS, AT PENETRATIONS INTO RATED SPACES, AND OTHER LOCATIONS AS REQUIRED BY CODES. PROVIDE CABLE SUPPORTS IN ACCORDANCE WITH NEC ARTICLE 300. PROVIDE EXPANSION FITTINGS IN CONDUIT RUNS CROSSING EXPANSION JOINTS IN THE

I. CONDUCTORS. UNLESS OTHERWISE INDICATED, ALL CONDUCTORS ARE #12 IN 1/2" CONDUIT. ALL CONDUCTORS SHALL BE COPPER. ACCEPTABLE INSULATION TYPES ARE TW, THW, THHN, THWN, AND XHHW, WITH USES AS RESTRICTED BY THE NEC. AMPACITIES OF CONDUCTORS IS TO BE BASED ON ARTICLE 310 OF THE NEC WITH UL LIMITATIONS: 60 DEG. RATING FOR SIZES #14 THROUGH #1; 75 DEG. FOR #1/0 AND LARGER. CABLES 3/0 AND LARGER SHALL BE TERMINATED WITH PRESSURE CRIMP CONNECTORS. FOR 20 AMP BRANCH CIRCUITS GREATER THAN 100 FT. IN LENGTH, ONE WAY, UP TO 200 FT. USE #10 WIRE; OVER 200 FT., USE #8 WIRE. INCREASE CONDUIT SIZE AS REQUIRED FOR THE LARGER CONDUCTORS. THIS SUPERSEDES WIRE SIZES CALLED FOR ON THE DRAWINGS.

CONDUCTORS SIZE #10 AND SMALLER SHALL HAVE INSULATION COLORED FOR PHASES A, B, C, AND N RESPECTIVELY AS FOLLOWS FOR 3 PHASE SYSTEM: 120/240 VOLTS: BLACK, RED, BLUE AND WHITE

ALL CONDUCTORS OF THE SAME PHASE IN PARALLELED FEEDERS OR SERVICES SHALL BE SOLIDLY CONNECTED TOGETHER AT THEIR TERMINATION IN A WIREWAY OR SPLICE BOX. MAKE CONDUCTOR LENGTH FOR PARALLEL FEEDERS IDENTICAL. THE PHASE DESIGNATION OF ALL SECONDARY CONDUCTORS SHALL BE THE SAME AND SHALL BE INDICATED IN OR ON ALL 3 PHASE OUTLETS, TRANSFORMERS, PANELBOARDS, AND DISCONNECT SWITCHES, AND THEY SHALL BE CONNECTED WITH UNIFORM PHASE SEQUENCE. MAINTAIN A, B, C PHASE RELATION LEFT TO RIGHT WHEN VIEWED FROM THE FRONT. TAG ALL FEEDER CONDUCTORS AND IDENTIFY MAJOR CONDUITS IN OR AT WIREWAYS, PANELS, PULL BOXES, SWITCHBOARDS, MOTOR CONTROLLERS, CABINETS AND SIMILAR ITEMS TO ASSIST IN FUTURE CIRCUIT TRACING. CONDUCTOR TAGS SHALL BE NONCONDUCTIVE. IDENTIFICATION SHALL CORRESPOND TO THE CONTRACT DOCUMENTS.

COMMUNICATIONS, DATA, AND/OR WIRING WHICH IS NOT INSTALLED IN CONDUIT, AND WHICH IS ROUTED THROUGH ENVIRONMENTAL AIR SPACES, SHALL COMPLY WITH THE REQUIREMENTS OF NEC 300-22. PROVIDE TRAPEZE HANGER ASSEMBLY FOR PLENUM CABLES USING 3/8" DIAMETER HANGER ROD AND CHANNEL ASSEMBLY TO SUPPORT CABLE BUNDLES EVERY 4 FEET. ALL BUNDLES SHALL BE PROPERLY STRAPPED WITH SELF-LOCKING CABLE TIES. EXPOSED CABLES SHALL NOT LIE ON TOP OF CEILING TILES OR LUMINARIES.

LIGHTING FIXTURE SCHEDULE

CATALOG NUMBER

FM22 ACLR LP

3348 2L32

/5\(\ \text{FMLL7 8 30WL}

/5∖ MWVB2 BZ DCNE1001

5 217-WT

OFTR 200Q 120 LP

QTY

LAMP

LED

F32T8

LED

100WQTZ

J. GROUNDING.

SHALL BE RATED FOR SWITCHING DUTY.

COLOR VOLTS MOUNTING

120

120

120

120

120

A MINIMUM OF 50% OF THE LAMPS IN PERMANENTLY INSTALLED

LIGHTING FIXTURES SHALL BE HIGH-EFFICACY LAMPS AS PER

SURFACE

SURFACE

SURFACE

SURFACE

SURFACE

SURFACE

3500

3000

3500

3000

2700

2700

ENERGY CODE (FBC) SECTION 404.1

END-TO-END LIGHTING FIXTURES SHALL BE CONTINUOUSLY BONDED. GROUNDING CONTACTS OF RECEPTACLES SHALL BE CONNECTED TO A SOLIDLY GROUNDED CONDUIT SYSTEM OR TO A SYSTEM GROUNDING CONDUCTOR (NOT THE SYSTEM NEUTRAL) BY A STRANDED COPPER WIRE NOT SMALLER THAN #12 AWG OR SHALL BE GROUNDED IN SOME OTHER APPROVED MANNER; THE RESISTANCE BETWEEN THE CONTACTS AND SERVICE GROUND SHALL NOT EXCEED 3 OHMS.

ALL CIRCUITS SHALL HAVE AN EQUIPMENT GROUNDING CONDUCTOR.

K. SAFETY SWITCHES/CIRCUIT BREAKER DISCONNECTS.
SHALL BE HEAVY DUTY TYPE KD, FUSIBLE, OR NON-FUSIBLE, WITH POLES, AMPERE, VOLTAGE AND HORSEPOWER RATINGS INDICATED AND SHALL HAVE SOLID NEUTRALS. LUGS SHALL BE

ENCLOSURES FOR SAFETY SWITCHES SHALL BE NEMA-1, GENERAL PURPOSE, EXCEPT THAT SWITCHES INDICATED (WP) WEATHERPROOF, SHALL BE NEMA-3R ENCLOSURES WITH SUITABLE GASKETS AND BONDING MEANS. SWITCHES AND DISCONNECT SHALL BE AS MANUFACTURED BY SQUARE "D", OR APPROVED

CIRCUIT BREAKER DISCONNECTS MAY BE USED IN LIEU OF SAFETY SWITCHES PROVIDING THEY COMPLY WITH THE SAFETY SWITCH REQUIREMENTS AND ARE SUPPLIED WITHIN THEIR RATINGS AND A SCHEDULE IS SUBMITTED FOR APPROVAL.

L. MOLDED CASE CIRCUIT BREAKERS. CIRCUIT BREAKERS SHALL CONFORM TO APPLICABLE FEDERAL SPECIFICATIONS AND NEMA STANDARDS. CIRCUIT BREAKERS SHALL BE OF THE AMPERE RATING, VOLTAGE RATING, NUMBER OF POLES AND CLASS OR INTERRUPTING CAPACITY (I.C.) AS INDICATED. INTERRUPTING RATINGS ARE GIVEN IN ROOT MEAN SQUARE (RMS), SYMMETRICAL AMPERES BASED ON NEMA TEST PROCEDURES. LUGS AND TERMINALS SHALL BE U.L. APPROVED FOR COPPER—ALUMINUM. ACCESSORIES SHALL BE 120 VOLT. A.I.C. OF BREAKER TO BE INSTALLED ON EXIST. PANELS SHALL MATCH EXIST. EACH CIRCUIT BREAKER SHALL HAVE A TRIP UNIT FOR EACH POLE WITH ELEMENTS PROVIDING INVERSE TIME DELAY UNDER OVERLOAD CONDITIONS AND INSTANTANEOUS MAGNETIC TRIP FOR SHORT CIRCUIT PROTECTION UNLESS INDICATED AS NON-AUTOMATIC. TRIP ELEMENTS SHALL OPERATE A COMMON TRIP BAR TO OPEN ALL ELEMENTS. BREAKERS USED FOR SWITCHING

 $\boldsymbol{\mathsf{M}}.$ Fuses shall conform to Nema and U.L. and shall be of the voltage, class and ampere rating indicated. FUSES FOR MAIN DISCONNECT DEVICES SHALL BE HIGH INTERRUPTING CAPACITY, TIME DELA OR TYPE SUITABLE FOR DEVICE. PROVIDE ONE SPARE SET MOUNTED INSIDE THE CUBICLE, FOR

FUSES FOR MOTORS AND ENCLOSED SWITCHES, NEMA CLASS K-5, UNLESS INDICATED OTHERWISE, DUAL ELEMENT, TIME DELAY. BUSSMAN - FUSETRON, FRN AND FRS, OR EQUAL. OTHER FUSES SHALL BE AS INDICATED.

N. WIRING DEVICES. DEVICES SHALL BE AS SPECIFIED IN CONTRACT DOCUMENTS. INSTALL PLATES AND COVERS ON ALL OUTLETS. INSTALL ALL DEVICES UNIFORMLY IN EACH

PLATES SHALL BE ALIGNED VERTICALLY AND HORIZONTALLY AND ALL EDGES SHALL BE IN FIRM CONTACT WITH SURROUNDING WALL FINISH. MOUNTING HEIGHTS (TO CENTER LINE OF BOX):

TEST EACH SOCKET OF EACH OUTLET WITH A DEVICE INTENDED FOR THE PURPOSE.

GENERALLY MOUNT RECEPTACLES 18" AFF (ABOVE FINISHED FLOOR) UNLESS NOTED OTHERWISE. OTHERWISE.
MOUNT SWITCHES AND DIMMERS AT 48" AFF.
MOUNT OUTLETS OVER MIRRORS 8" HIGHER THAN MIRROR.
MOUNT OUTLETS OVER COUNTERS AND CENTERED IN THE BACK SPLASH WHERE IT ADJUST OUTLET HEIGHTS IN CERAMIC TILE WALLS TO BE ENTIRELY IN OR ENTIRELY OUT OF THE TILE. OUTLETS MAY BE HORIZONTAL TO MEET SPACE CONDITIONS.

REMARKS

ENERGY STAR

ENERGY STAR

ENERGY STAR

ENERGY STAR

WET LOCATION

WET LOCATION

<u>RESIDENCE NOTES:</u>

- 1. COOLING AND HEATING LOADS ARE NOT CONCURRENT.
- 2. PROVIDE ALL FINAL CONNECTIONS TO ALL EQUIPMENT AND APPLIANCES. PROVIDE ALL A/C CONTROL IN SEPARATE 1/2"C AS REQUIRED BY A/C DRAWINGS OR
- MANUFACTURER DIAGRAMS.
- 4. ALL LAVATORIES AND KITCHEN RECEPTACLES SHALL BE GFI TYPE.
- 5. EXTERIOR RECEPTACLES TO BE GFI AND WEATHER PROOF.
- 6. COORDINATE LOCATION OF ALL DISCONNECT SWITCHES WITH OTHER TRADES TO ALLOW N.E.C. REQUIREMENT CLEARANCE.
- CIRCUITS WIRING REQUIRED TO BE AS FOLLOWS: 120V-2 WIRE (L-N); 120/240V 3 WIRE (LL-N); 240V - 2 WIRE (LL). WHEN EQUIPMENT GROUND IS REQUIRED INCREASE CONDUIT ŠIZE ÁS REQUIRED.
- 8. ALL WIRING TO BE COPPER. THHN/THWN TYPE RUN IN CONDUIT.
- 9. ALL COUNTER RECEPTACLES AND SWITCHES TO BE MOUNTED + 48" MAXIMUM FINISHED FLOOR (TO BOTTOM OF PLATE). UNLESS OTHERWISE NOTED COORDINATE HEIGHT WITH ARCHITECT.
- 10. REFRIGERATOR RECEPTACLE TO BE MOUNTED + 48" A.F.F.
- 11. COORDINATE LOCATION OF AIR CONDITIONER (INDOOR UNIT) DISCONNECT SWITCH WITH A/C CONTRACTOR TO KEEP N.E.C. REQUIRED CLEARANCE.
- 12. MINIMUM WIRE SIZE SHALL BE #12 THHN/THWN .
- 13. CONDUCTORS #6 AWG AND LARGER SHALL BE THW.
- 14. ALL CONDUCTORS SHALL BE COPPER. 15. CONDUIT IN FINISHED AREAS SHALL BE CONCEALED.
- 16. CONDUIT IN UNFINISHED AREAS SHALL BE EXPOSED. 17. FUSES SHALL BE DUAL ELEMENT, TIME DELAY TYPE.
- 18. INSTALL NYLON PULL STRING IN ALL EMPTY CONDUITS FOR FUTURE USE.
- 19. ALL MATERIALS SHALL BE U.L. APPROVED.
- 20. WORKMANSHIP SHALL BE TO BEST COMMERCIAL PRACTICE.
- 21. INSTALLATION SHALL BE IN ACCORDANCE WITH LOCAL, STATE AND NATIONAL CODES.
- 22. RECESSED LIGHT FIXTURES OVER BATHTUB OR SHOWER SHALL BE COMPLETELY ENCLOSED AND VAPOR PROOF SUITABLE FOR WET LOCATIONS.
- 23. ALL LUMINARIES SHALL BE PROPERLY SUPPORTED IN ACCORDANCE WITH THE CEILING SYSTEM MANUFACTURER RECOMMENDATIONS AND LOCAL CODE REQUIREMENTS.
- 24. RISER AND DIAGRAMMATIC ONLY. THEY DO NOT SHOW EVERY BEND REQUIRED FOR THE INSTALLATION.
- 25. THIS DRAWING IS A GUIDE FOR THE INSTALLATION OF ELECTRICAL SERVICE. THE ELECTRICAL CONTRACTOR IS RESPONSIBLE TO PROVIDE A FUNCTIONING SYSTEM.
- 26. A/C EQUIPMENT WIRING, BREAKER AND FUSE SIZES ARE BASED ON A/C EQUIPMENT SPECIFIED ON CONTRACT DRAWINGS. CONTRACTOR IS RESPONSIBLE FOR PROVIDING ALL WIRING. BREAKER AND FUSES SIZES IN ACCORDANCE WITH A/C EQUIPMENT NAMEPLATE REQUIREMENTS IF DIFFERENT FROM THAT SPECIFIED ON DRAWINGS, AS WELL AS ANY FEEDER CHANGES BEING AFFECTED BY THIS CHANGE. CONTRACTOR SHALL MAKE ABOVE MENTIONED CHANGES AT NO EXTRA COST.
- 27. CONTRACTOR SHALL COORDINATE ALL HIS WORK WITH OTHER TRADES IN ORDER TO FURNISH AND INSTALL ALL CONTROL WIRING AND RACEWAYS ALL POWER CONTROL CIRCUITS WIRING AND RACEWAYS AS SHOWN ON THE AIR CONDITIONING DRAWINGS OR SPECIFICATIONS. IF AIR CONDITIONING DRAWINGS REFER TO MANUFACTURER'S WIRING DIAGRAMS, THE CONTRACTOR SHALL VERIFY WITH SAID MANUFACTURER ALL REQUIREMENTS AND INCLUDE ALL RELATED WORK IN HIS
- 28. SEE PANEL SCHEDULES FOR AFCI CIRCUIT REQUIREMENTS.
- 29. ALL RECEPTACLES SHALL BE TAMPER PROOF.

SYMBOL LEGEND:

- MOUNTED TAMPER RESISTANT.
- WALL MOUNTED LIGHT FIXTURE
- O CEILING MOUNTED LIGHT FIXTURE (RECESSED)
- FLUORESCENT LIGHT FIXTURE

- THREE-WAY SWITCH, 120V, 20A.
- FUSED OR NON FUSED DISCONNECT SWITCH. FUSES AS PER EQUIPMENT MANUFACTURER.
- SMOKE DETECTOR (120V) TANDEM WIRED WITH SOUNDING BASE
- JUNCTION BOX
- GFI GROUND FAULT INTERRUPTER

- DUPLEX RECEPTACLE OUTLET 15A, 125V, 3 WIRE MOUNTED @ 18" AFF SMALL APPLIANCE AND BATHROOM DUPLEX RECEPTACLES TO BE RATED FOR 20A, 125V, 3 WIRE, GROUND TYPE WALL
- SINGLE RECEPTACLE OUTLET, 20A, 125V, 3 WIRE, GROUNDING TYPE WALL MOUNTED
- -O- PENDANT LIGHT FIXTURE

- TV OUTLET
- TELEPHONE OUTLET MOUNTED AT 18" AFF
- SINGLE POLE SWITCH, 120V, 20A
- SPECIAL PURPOSE OUTLET TO MATCH EQUIPMENT PLUG, 120/240V, 1ø, GROUNDING TYPE
- WP WEATHER PROOF

48 HOURS BEFORE DIGGING UNDERGROUND UTILITIES NOTIFICATION CENTER

ALLEGUEZ ARCHITECTURE, INC. ARCHITECTURE PLANNING

DESIGN INTERIOR CONSTRUCTION MANAGEMEN 901 PONCE DE LEON BLVD., SUITE 202 CORAL GABLES, FLORIDA 33134 (305) 461 4001 (FAX) 461 6002

E-MAIL alleguez@bellsouth.net

■AA C 0 0 2 7 4 6

CONSULTANTS:

MECHANICAL, ELECTRICAL, PLUMBING ENGINEER: GARTEK ENGINEERING CORP.

7210 SOUTHWEST 39TH TERRACE MIAMI, FLORIDA 33155 TEL: (305) 266-8997 FAX: (305) 264-9496 Certificate of Authorization #3144 www.gartek-engineering.com

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CITY OF MIAMI LIFE QUEST RENOVATIONS 1301 N.E. 111 ST

Owner's Representative:

Lori B. Soto City of Miami **Department of Community Development** (305) 416-2084 444 SW 2nd Avenue

Miami, FL. 33130 DRAWING TITLE:


ELECTRICAL GENERAL NOTES, LEGEND, SITE PLAN & DETAIL

ROEM, F. GARCIA P.E. (ELECTRICAL) LICENSE NO. 24221 "In my professional judgement and to the best of my knowledge and belief, thes plans and specifications comply with applicable Building Codes.

September 15,

2014 1 10-30-13 BLDG. DPT. COMMENTS

CAD DRAWING NAME:

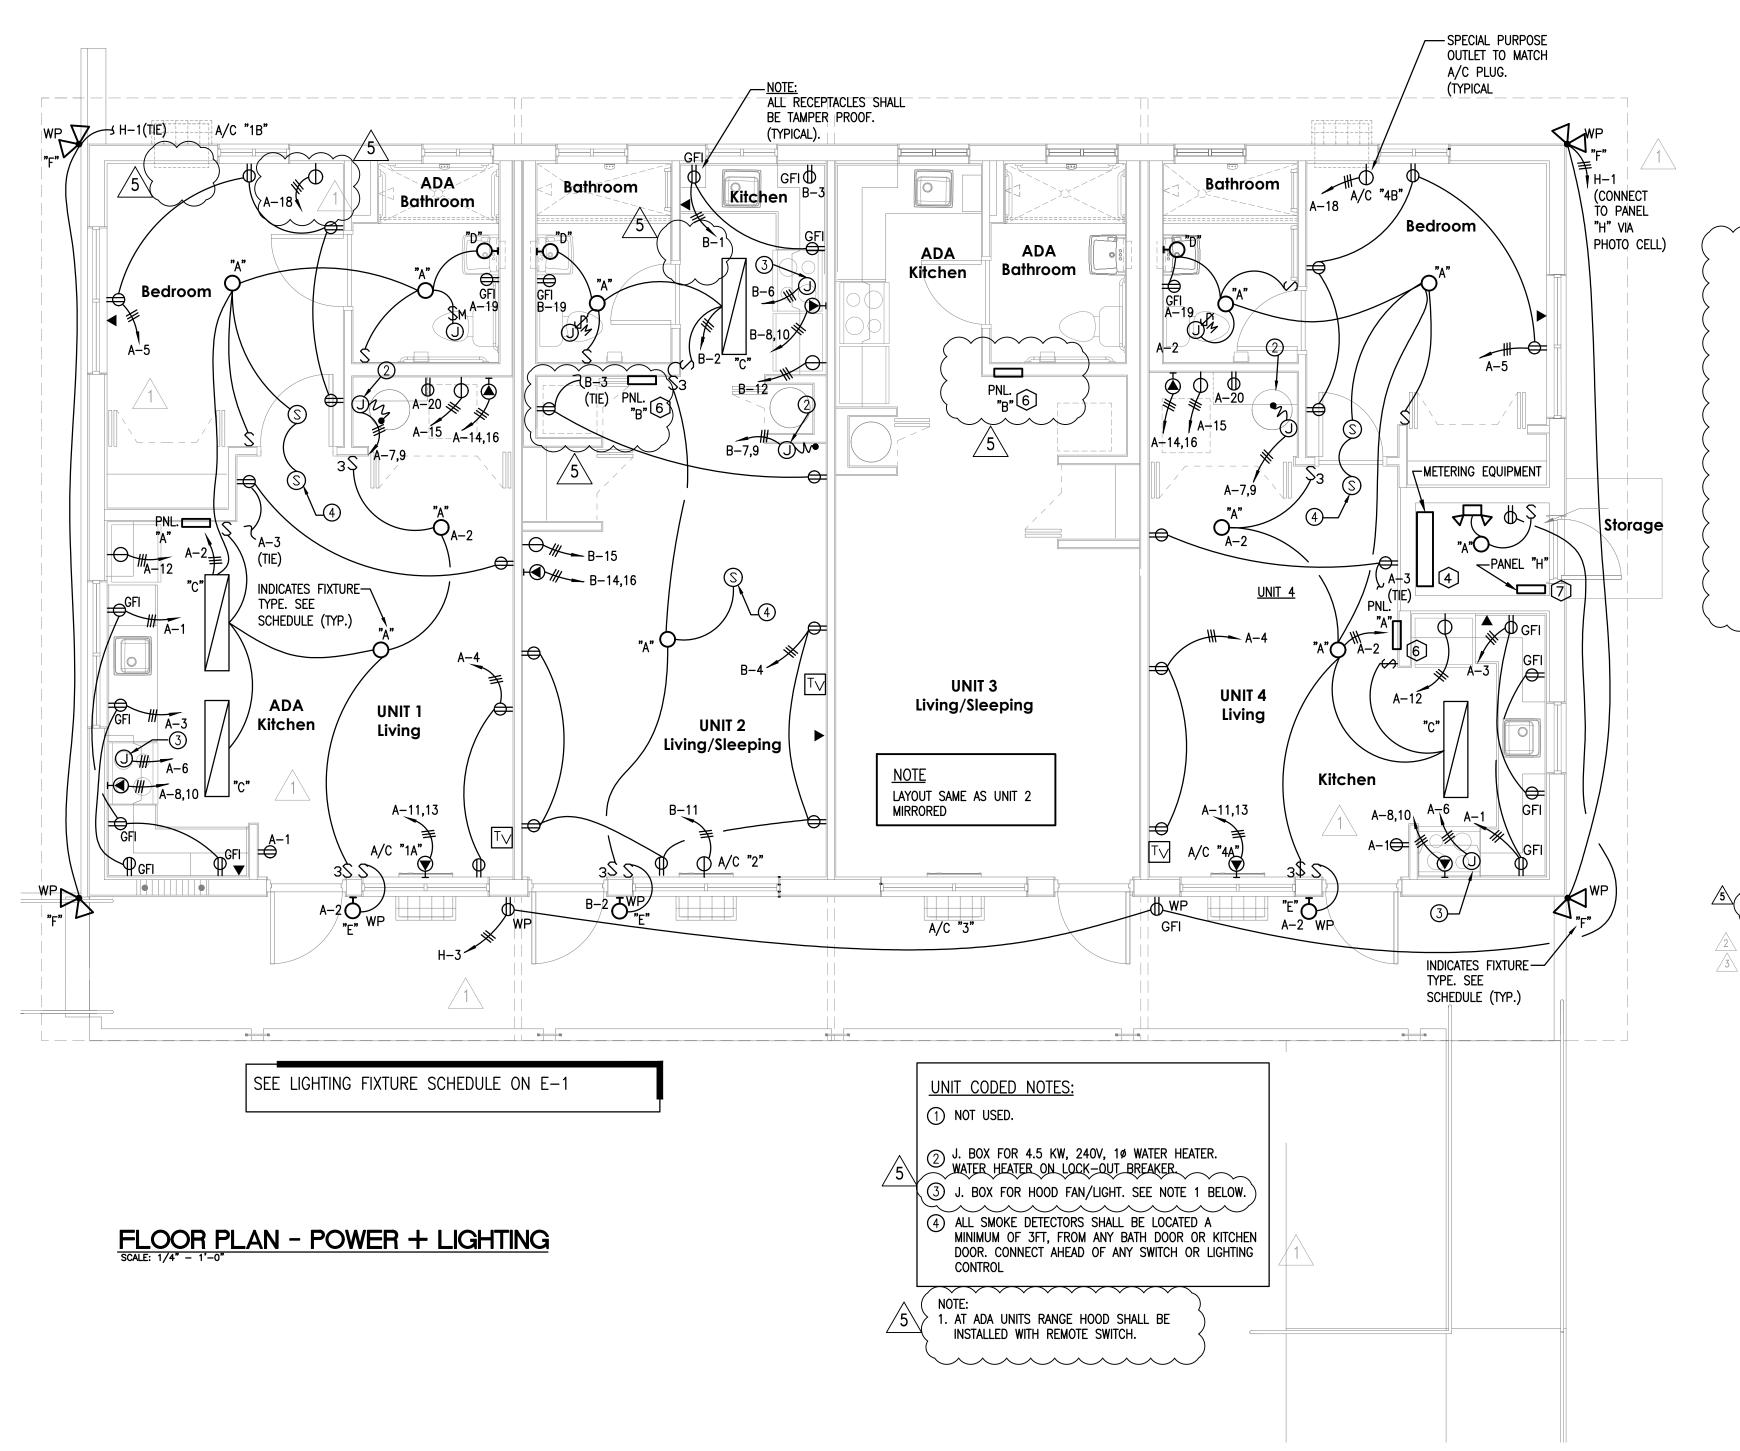

VOLTAGE: 120/240V, 1P, 3W

4.38 RANGE

2.60 DRYER

TOTAL kVA

TOTAL AMPS

<u>UNIT LOAD ANALYSIS</u>

BASED ON 120/240 V, 1ø, 3W

534 SQ. FT X 3 W/SQ FT 1,601 VA

OTHER LOADS EXCEPT A/C 26,860 VA

1ST 10 KVA @ 100% ————10,000 VA

18,461VA @ 40% — 7,384 VA

AC @ 100% ————2,740 VA

20,124 VA/240V = 83.9 A

(SEE UNIT LOAD ANALYSIS)

28,461 VA

20,124 VA

1.34 AC (1B, 4B)

1.40 REFRIGERATOR

GENERAL LIGHTS

GENERAL LIGHTS

HOOD FAN /LIGHT

1.50 LAUNDRY RECEPTACLE

0.0

MAINS AMPS: 125A

TYPE MAINS: M.L.O

10,000 AIC

(SIMILAR TO UNIT 4)

CONN LOAD ADJ FACTOR DMD FCTR TOTAL

0.00 1.25 1.00 0.00

 LIGHTING
 0.00
 1.25
 1.00
 0.00

 RECEPT
 0.00
 --- NEC
 0.00

 LRGST MTR
 0.00
 1.25
 1.00
 0.00

 OTHER MTRS
 0.00
 1.00
 1.00
 0.00

 OTHER LOAD
 0.00
 1.25
 1.00
 0.00

 OTHER LOAD
 0.00
 1.00
 1.00
 0.00

PANEL "A" 1301 - **UNIT 1**

A EQUALTO:

LOAD DESCRIPTION

RECEPT - SM APPL

RECEPT - SM APPL

WATER HEATER

19 BATH RECEPTACLE

AC (1A, 4A)

WASHER

7 SPACE

1 SPACE

23 SPACE

GENERAL RECEPTACLES

1. (*) PART OF THE 3W/ SQ FT. LOAD.

4. APARTMENT UNITS 2 AND 3 : USE 1P-20A CB

2. PROVIDE AFCI TYPE BREAKER.

3. PROVIDE HACR TYPE BREAKER.

5. PROVIDE LOCK-OUT BREAKER.


TYPE: PANELBOARD - BOLT-ON CIRCUIT BREAKERS

MOONTING! FLUSH / /

(*)

RISER KEY NOTES


- CONTRACTOR SHALL PROVIDE AND INSTALL FPL SERVICE AND METERING EQUIPMENT SQUARE "D" EZ METER CENTER WITH A 400 A TAP BOX & (5) 125 A METERS WITH MAINS. RING OR RINGLESS TYPE DEVICE AS REQUIRED BY FPL. COORDINATE FPL SERVICE LOCATION WITH FPL PRIOR TO INSTALLATION.
- CONTRACTOR SHALL PROVIDE AND INSTALL (4) 2P-110 A SERVICE RATED 22K AIC MAINS FOR UNITS & (1) 2P-60 A SERVICE RATED 22K AIC MAIN FOR HOUSE PANEL.
- CONTRACTOR SHALL PROVIDE AND INSTALL (4) 120/240V, 1 PH, 125 AMPS, NEMA 1 FLUSH ENCLOSURE PANELBOARDS FOR UNITS 1,2,3,4 & (1) 120/240V, 1 PH, 125 AMPS, NEMA 3R SURFACE ENCLOSURE PANELBOARD "H" FOR HOUSE LOAD, BRANCH BREAKERS AS INDICATED. SEE PANEL SCHEDULE AND RISER DIAGRAM FOR DETAILS. MAKE ALL CONNECTIONS FOR A COMPLETE WORKING SYSTEM IN PLACE.
- CONTRACTOR SHALL PROVIDE AND INSTALL 3# 400kcmil IN 3 1/2" C, COMPLETE IN PLACE FROM METER EQUIPMENT TO FPL POINT OF CONNECTION. COORDINATE WITH FPL REPRESENTATIVE FOR EXACT LOCATION OF ELECTRICAL SERVICE, POINT OF CONNECTION AND METERING EQUIPMENT. ASSUME 250LF SERVICE FEEDER FOR PRICING. CONDUITS ROUTE AND TRENCH SHALL BE COORDINATED IN FIELD AND IN COMPLIANCE WITH FPL AND N.E.C. REQUIREMENTS. MAKE ALL NECESSARY CONNECTIONS, PROVIDE PULL BOXES, TRENCHING, RISERS, ETC. FOR A COMPLETE WORKING SYSTEM IN PLACE.
- PROVIDE GROUNDING OF ALL METAL SUPPORTS AND EQUIPMENT ATTACHED BY A MECHANICAL LUG AND BOLTED TO EQUIPMENT AND CONNECTED TO GROUNDING SYSTEM AS PER RISER DIAGRAM. PROVIDE AN INTERSYSTEM GROUNDING PER NEC 250.94
- CONTRACTOR SHALL PROVIDE AND INSTALL 3#1 & 1#6 (G) IN 1 1/2" C, COMPLETE IN PLACE. FEEDER CONDUCTORS SHALL BE ROUTED ALONG THRU THE INTERIOR OF THE BUILDING IN EMT CONDUITS.
- 7 CONTRACTOR SHALL PROVIDE AND INSTALL 3#6 & 1#8 (G) IN 1 1/4" C, COMPLETE IN PLACE

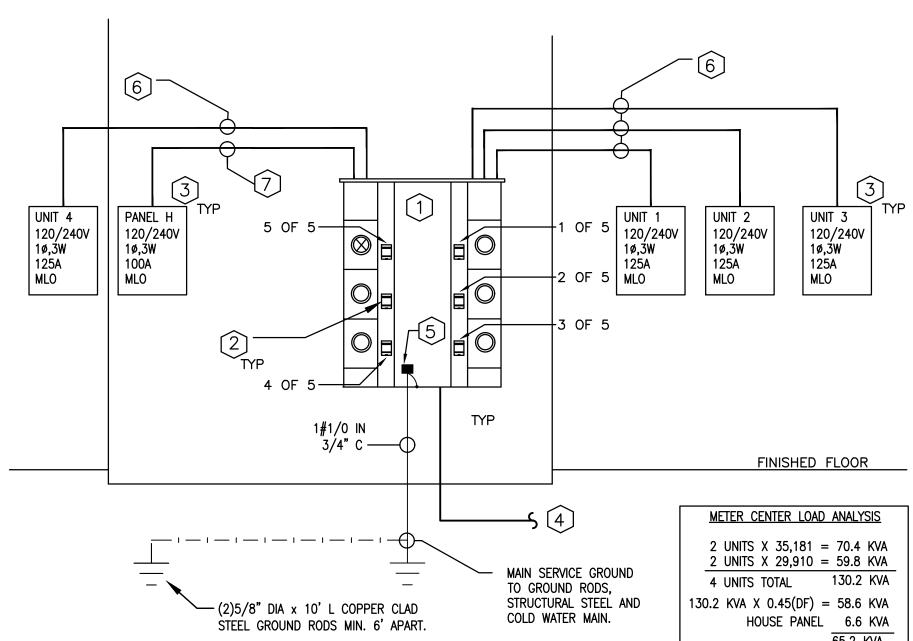

ELECTRICAL RISER DIAGRAM

A L L E G U E Z ARCHITECTURE, INC. ARCHITECTURE PLANNING **DESIGN** INTERIOR CONSTRUCTION MANAGEMENT 901 PONCE DE LEON BLVD., SUITE 202 CORAL GABLES, FLORIDA 33134 (305) 461 4001 (FAX) 461 6002 E-MAIL alleguez@bellsouth.net ■AA C 0 0 2 7 4 6 CONSULTANTS: MECHANICAL, ELECTRICAL, PLUMBING ENGINEER: GARTEK ENGINEERING CORP. 7210 SOUTHWEST 39TH TERRACE MIAMI, FLORIDA 33155 TEL: (305) 266-8997 FAX: (305) 264-9496 Certificate of Authorization #3144 www.gartek-engineering.com Gartek Project No. 2867 This document and the information it contains is the exclusive property of Gartek Engineering and may not be reproduced or used for other purpose other than the specific project for which it was prepared without the explicit consent of

65.2 KVA/240V = 271.7 A

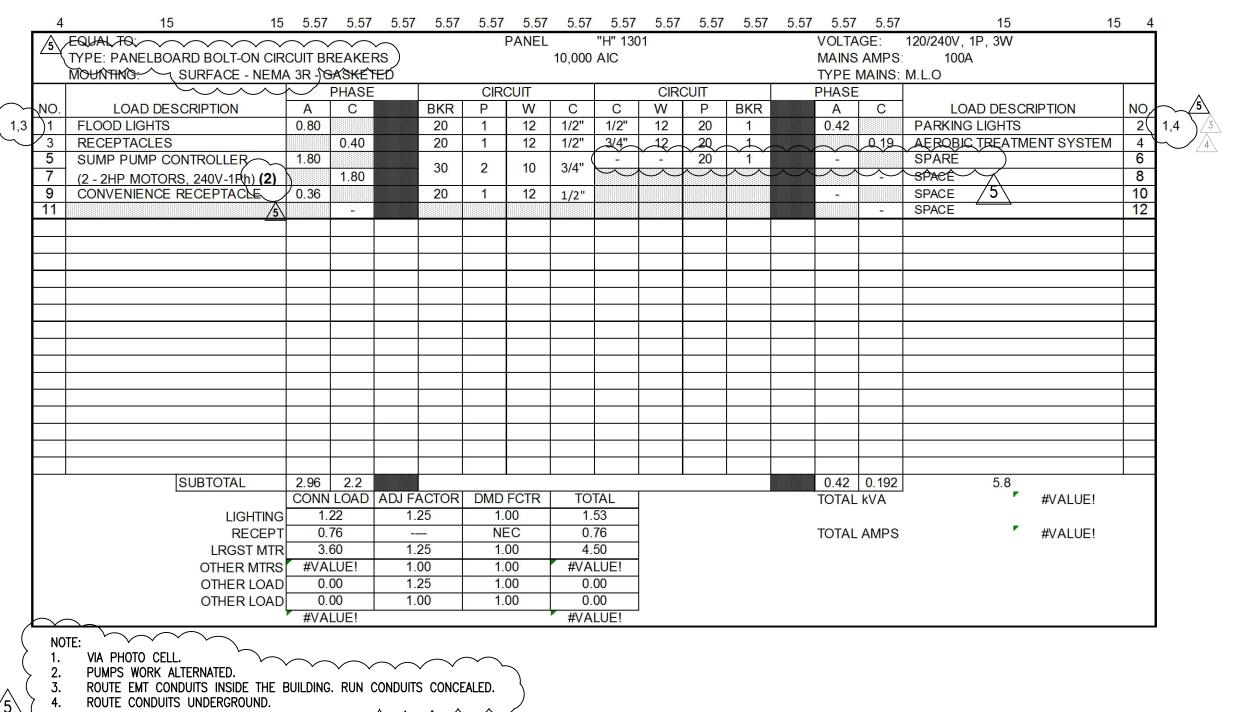


CITY OF MIAMI
LIFE QUEST
RENOVATIONS
1301 N.E. 111 ST.


Owner's Representative:
Lori B. Soto
City of Miami
Department of Community Development
(305) 416-2084
444 SW 2nd Avenue

ELECTRICAL POWER, LIGHTING FLOOR PLAN PANELS, & RISER

Miami, FL. 33130


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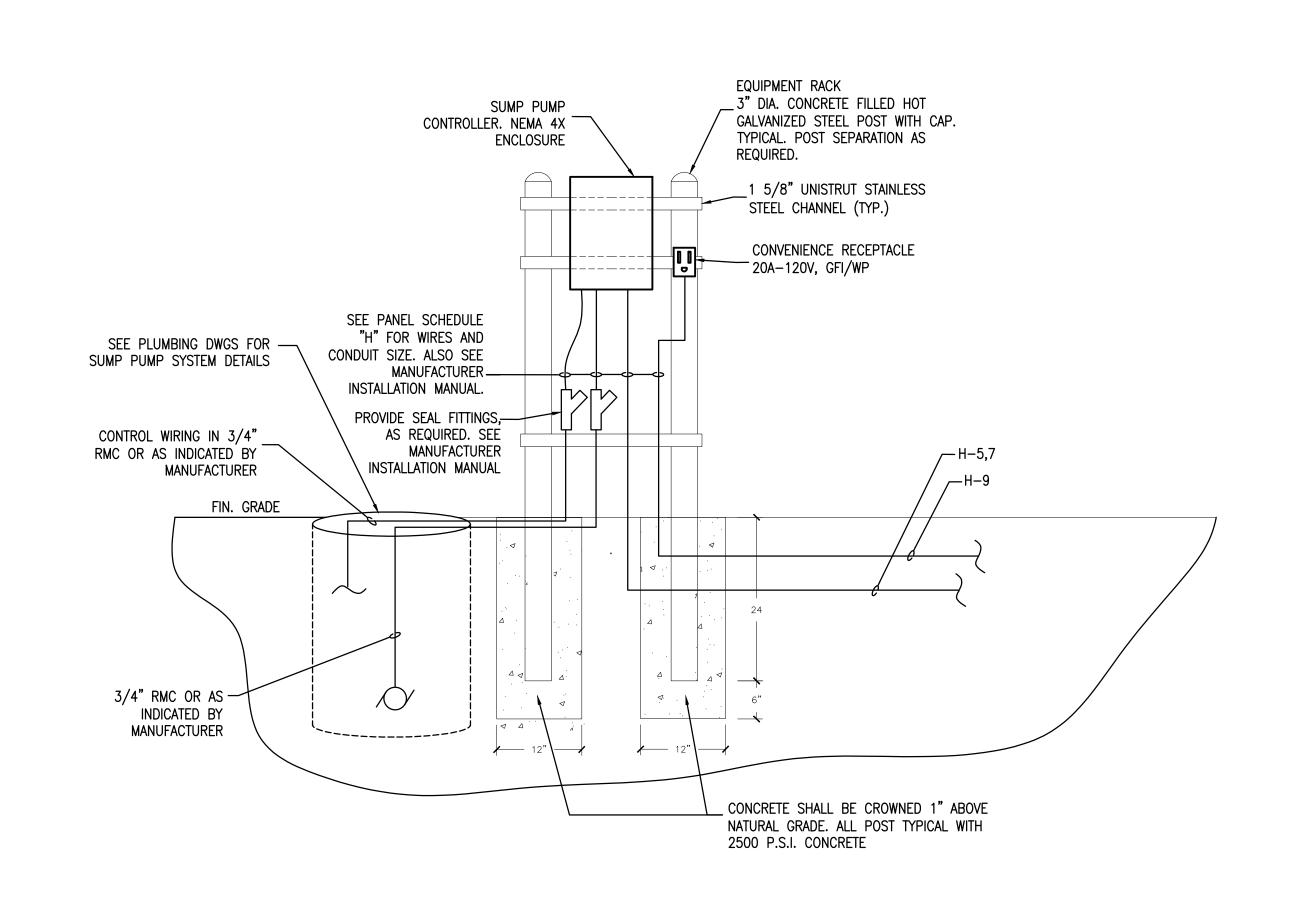


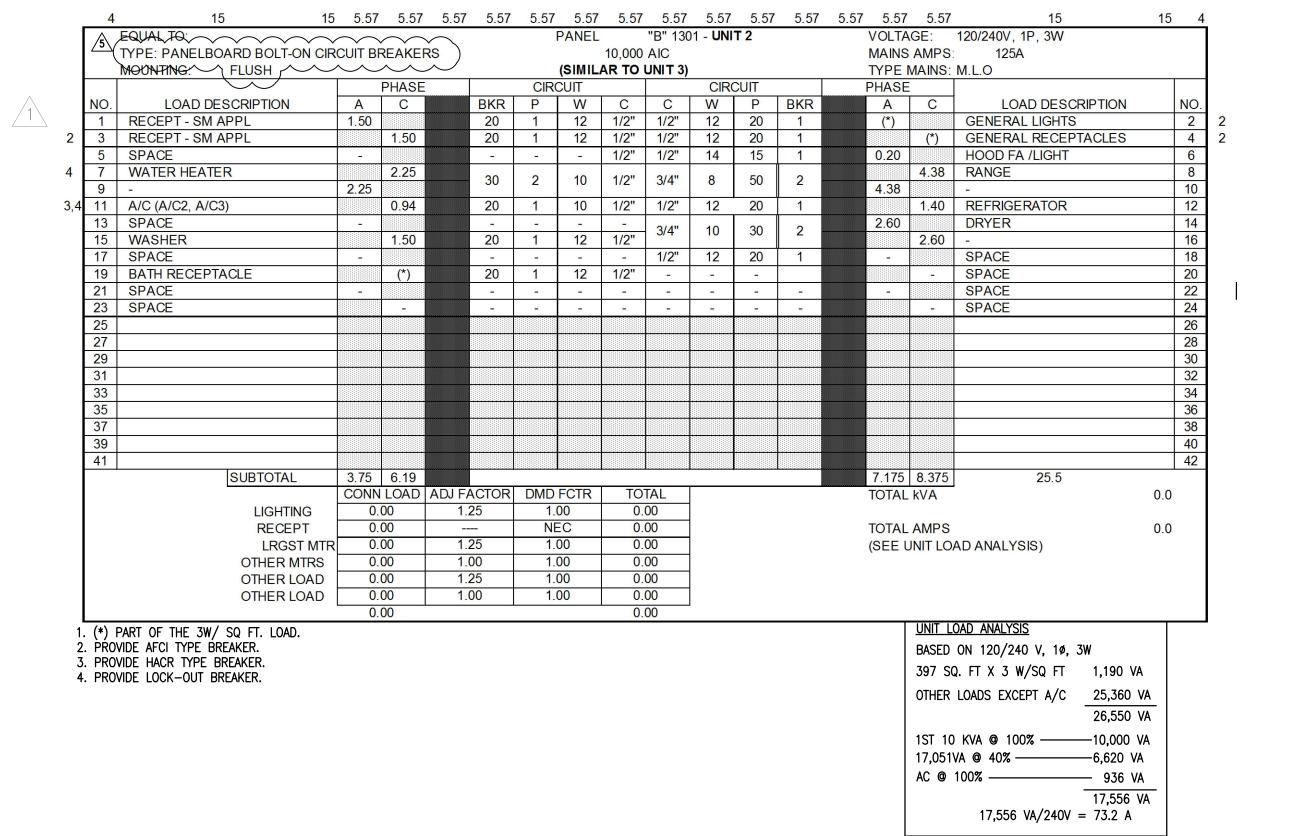

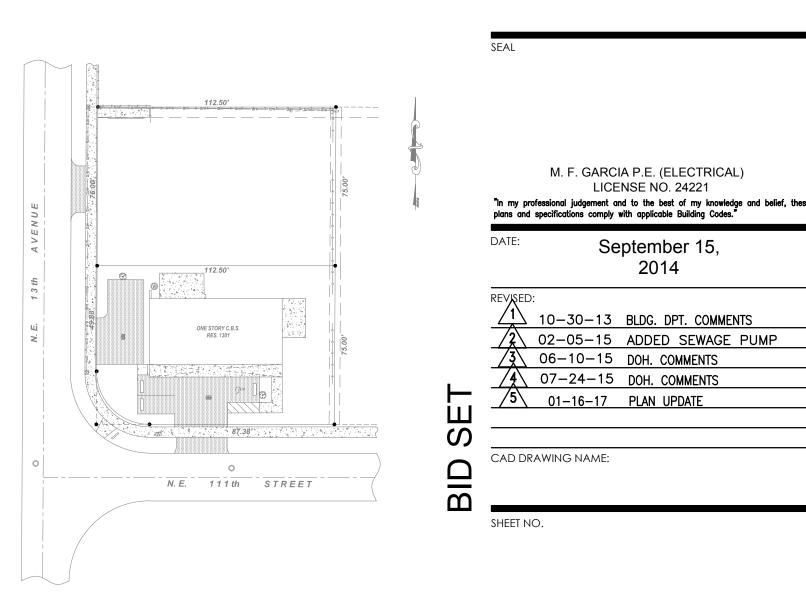SITE PLAN

E-2



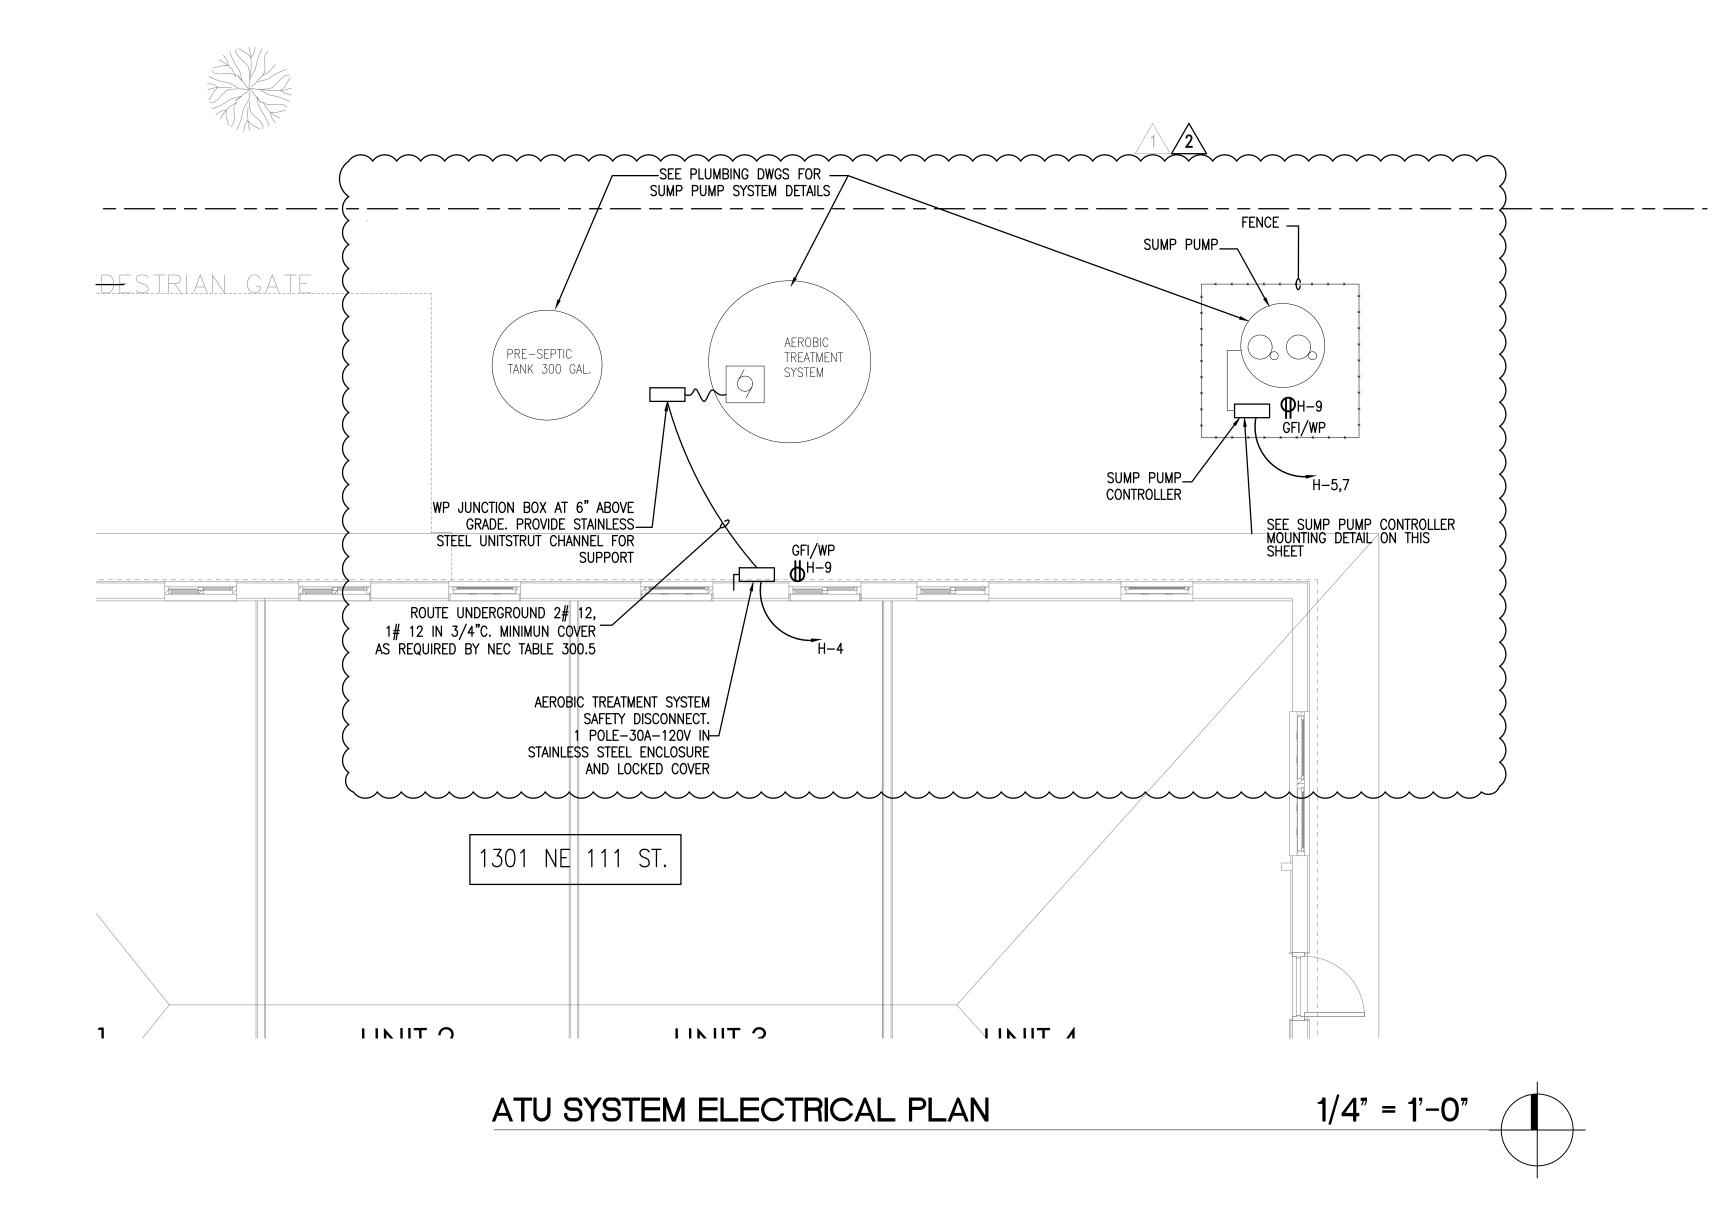

SEWAGE PUMP CONTROLLER MOUNTING DETAIL



ARCHITECTURE, INC.

ARCHITECTURE PLANNING
INTERIOR DESIGN

CONSTRUCTION MANAGEMENT

901 PONCE DE LEON BLVD., SUITE 202 CORAL GABLES, FLORIDA 33134 (305) 461 4001 (FAX) 461 6002 E-MAIL alleguez@bellsouth.net

CONSULTANTS:

MECHANICAL, ELECTRICAL, PLUMBING ENGINEER:

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7210 SOUTHWEST 39TH TERRACE
MIAMI, FLORIDA 33155
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Certificate of Authorization #3144
www.gartek-engineering.com

Gartek Project No. 2867.03

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Gartek Engineering.

PROJEC1

CITY OF MIAMI LIFE QUEST RENOVATIONS 1301 NE 111 ST.

MIAMI, FL

DRAWING TITLE:

ATU SYSTEM ELECTRICAL PLAN

M. F. GARCIA P.E. (ELECTRICAL)
LICENSE NO. 24221
"In my professional judgement and to the best of my knowledge and belief, these plans and specifications comply with applicable Building Codes."

DATE:
February 05, 2015

REVISED:

1 06-15-15 DOH. COMMENTS
2 07-24-15 DOH. COMMENTS

CAD DRAWING NAME:

SHEET NO.