
CITY OF MIAMI - LIFE QUEST DEMOLITION & REPLACEMENT OF 14950 N.E. 11th Ave City of Miami Department of Community Development

– 14950 N.E. 11th Avenue

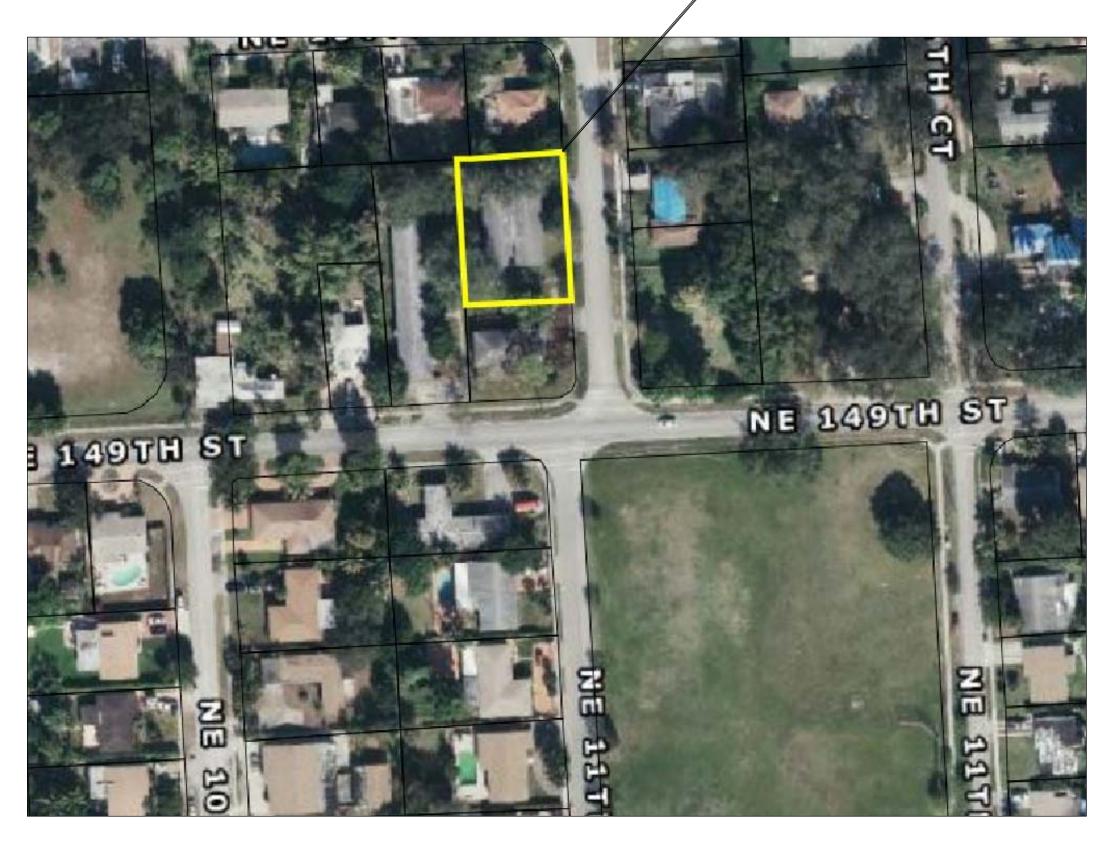

LOCATION MAP





Bid Set - January 9th 2017

Owner's Representative: Dollila Pinkhasov Contract Compliance Analyst City of Miami

> Mayor Tomas P. Regalado

> > Chairman Leon Hardemon


> > > Vice-Chairman Ken Russell

Commissioner Frank Carollo

Commissioner Wifredo (Willy) Gort

> Commissioner Francis Suarez

City Manager Daniel J. Alfonso

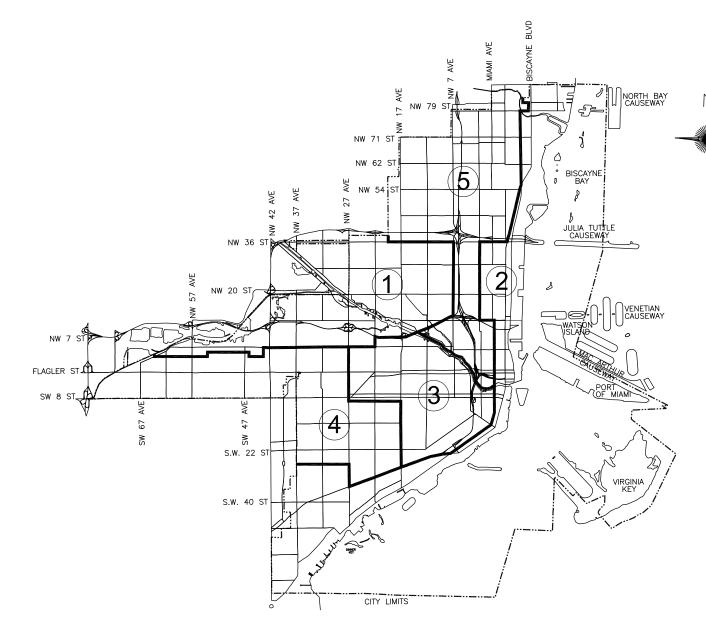





ARCHITECT:





MECHANICAL, ELECTRICAL, PLUMBING ENGINEER: GARTEK ENGINEERING CORP. 7210 SOUTHWEST 39TH TERRACE MIAMI, FLORIDA 33155 TEL: (305) 266-8997 FAX: (305) 264-9496 WWW.GARTEK-ENGINEERING.COM

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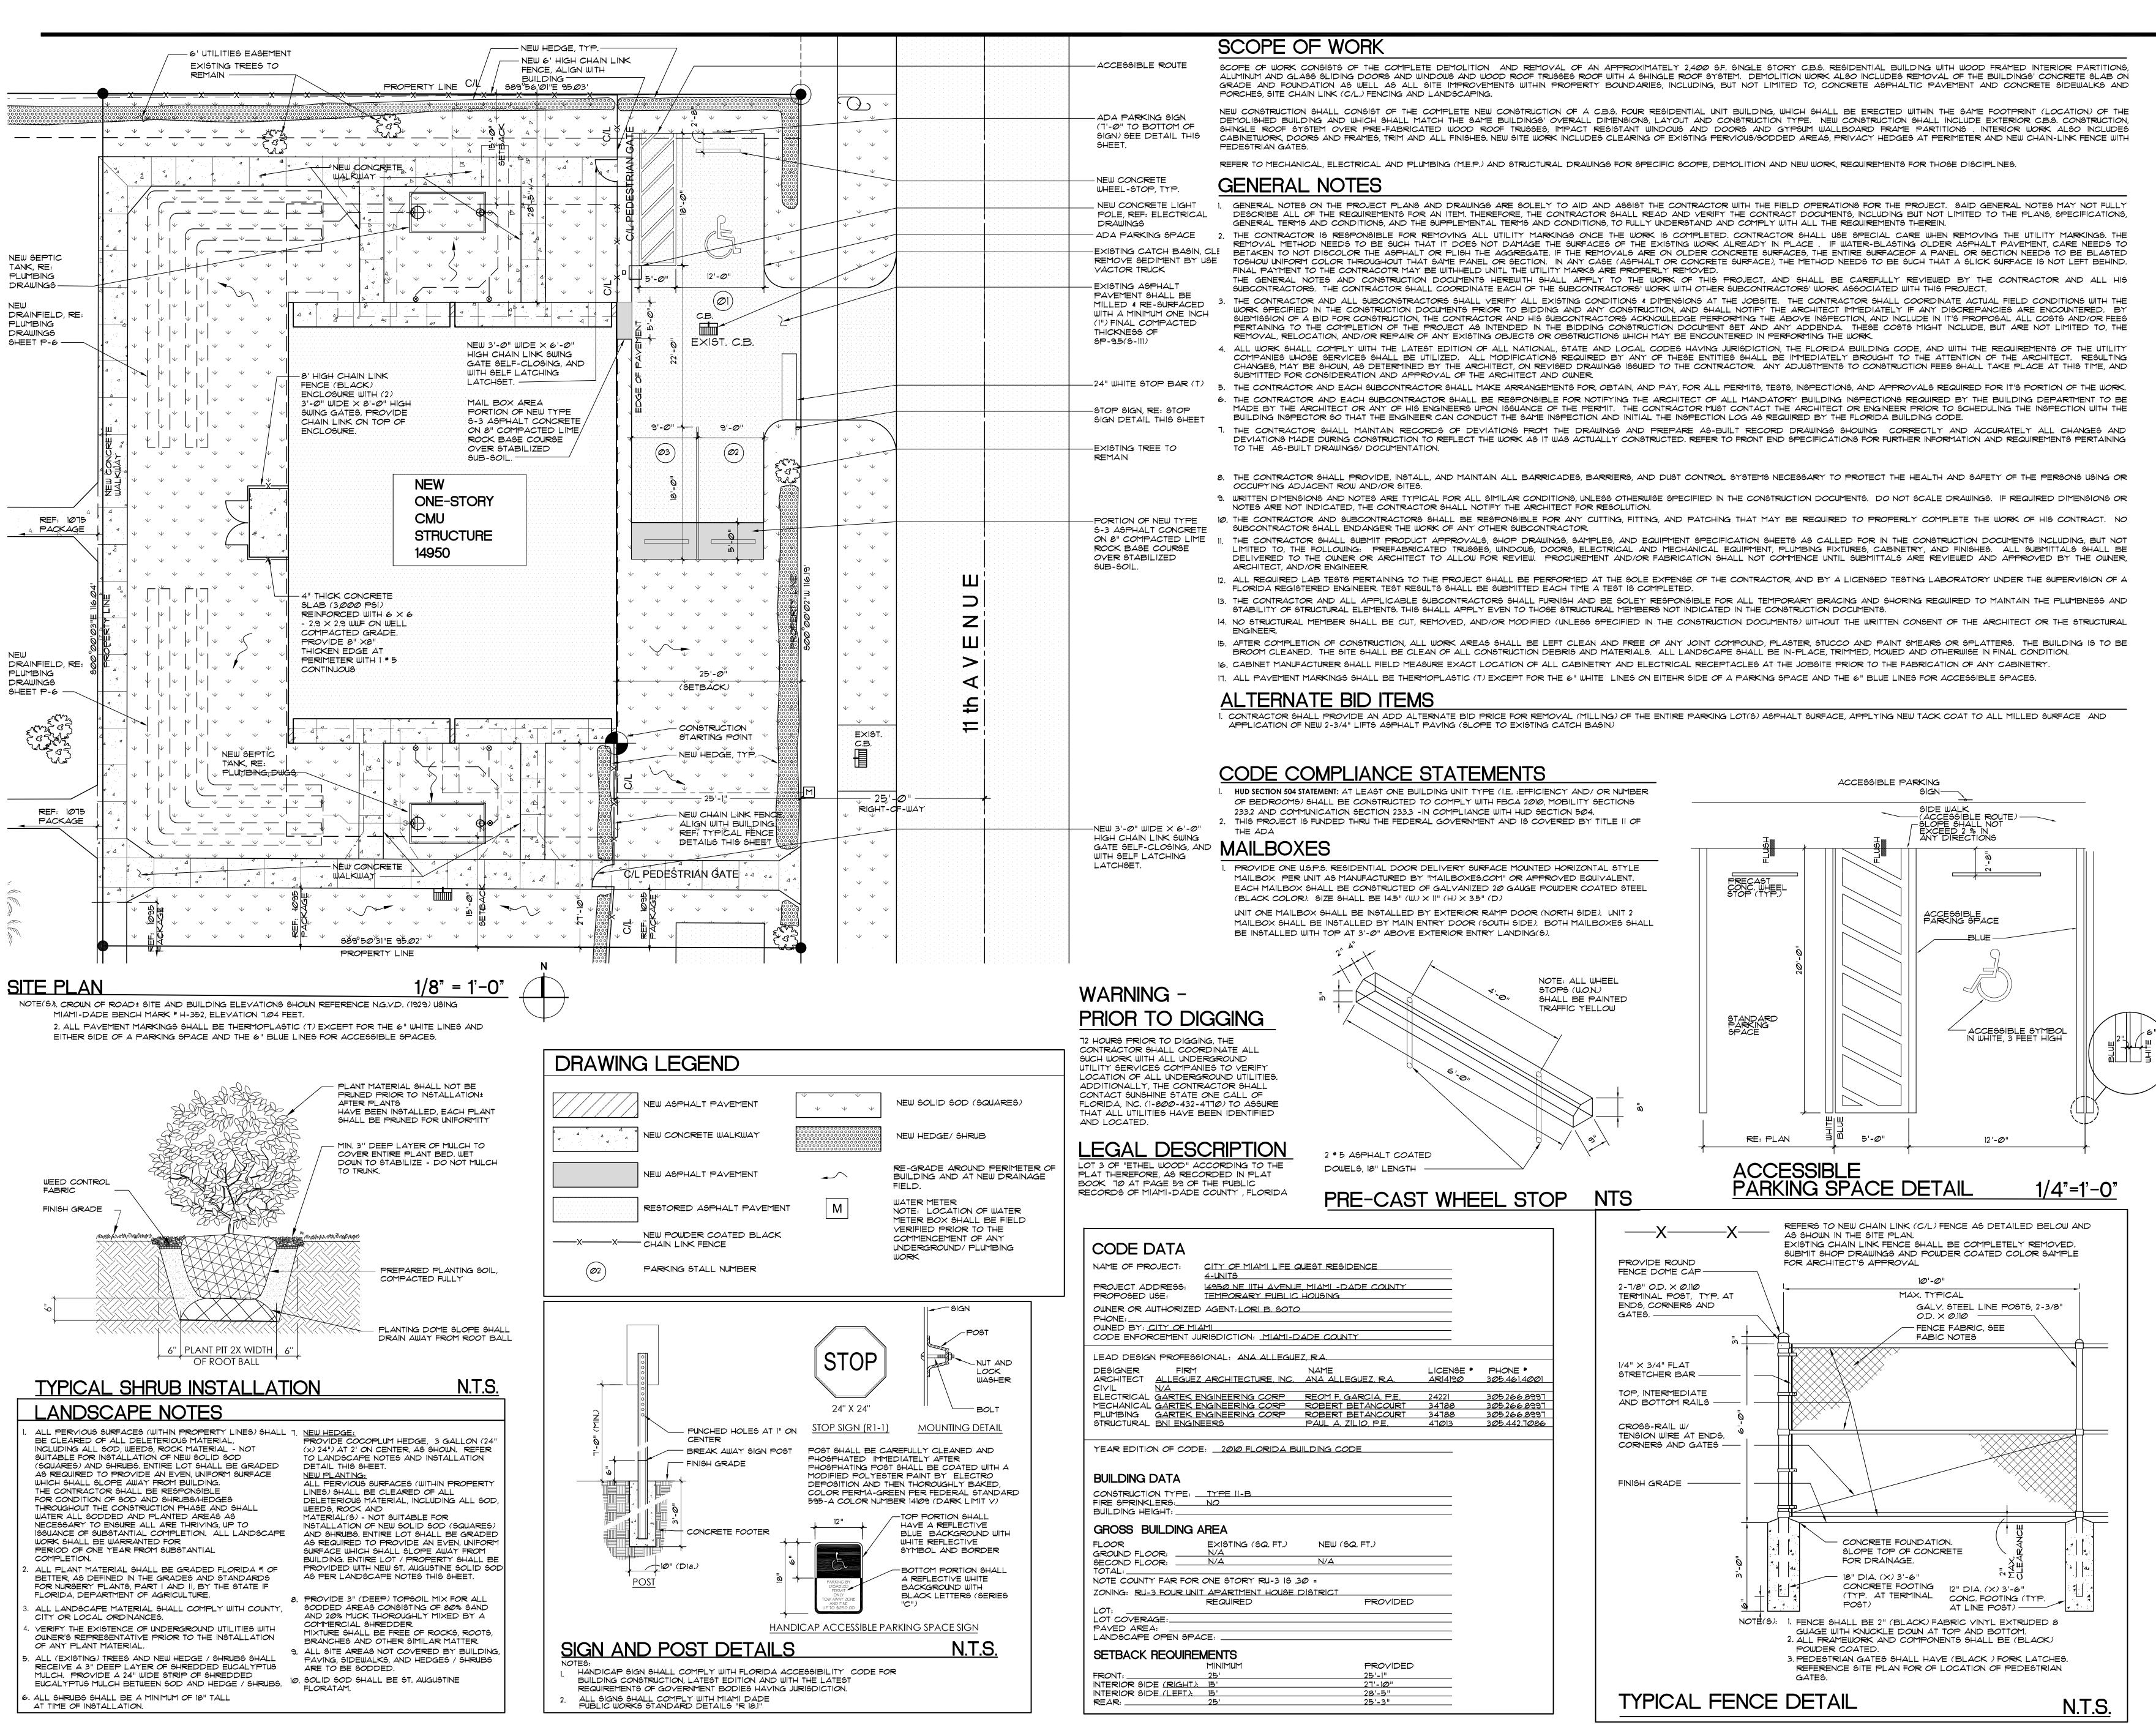
MECHANICAL

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STRUCTURAL ENGINEER: **BNI ENGINEERS** 800 DOUGLAS ROAD, SUITE 300 CORAL GABLES, FL 33134 TEL: (305) 442-7086 FAX: (866) 832-5291 WWW.BNIENGINEERS.COM



SITE PLAN
SEAL ALLEGUEZ, RA LICENSE NO. AR14190
DATE: August 12, 2013
REVISED:
CAD DRAWING NAME: SHEET NO.

CITY OF MIAMI

LIFE QUEST

DEMOLITION


AND

REPLACEMENT

14950 NE 11TH AVENUE

MIAMI, FL

DRAWING TITLE:

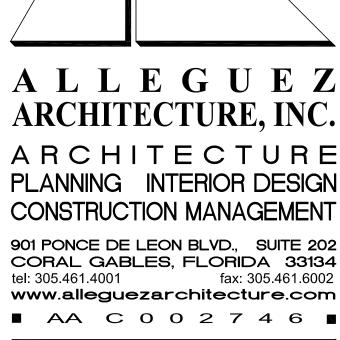

MIAMI, FLORIDA 33155

STRUCTURAL ENGINEER:

BLISS & NYITRAY, INC 800 DOUGLAS ROAD, SUITE 300

CORAL GABLES, FLORIDA 33134

TEL: (305) 442-7086 FAX: (305) 442-7092

CONSULTANTS:


GARTEK ENGINEERING CORP

TEL: (305) 266-8997 FAX: (305) 264-9496

7210 Southwest 39th terrace


MECHANICAL, ELECTRICAL, PLUMBING ENGINEER:

tel: 305.461.4001

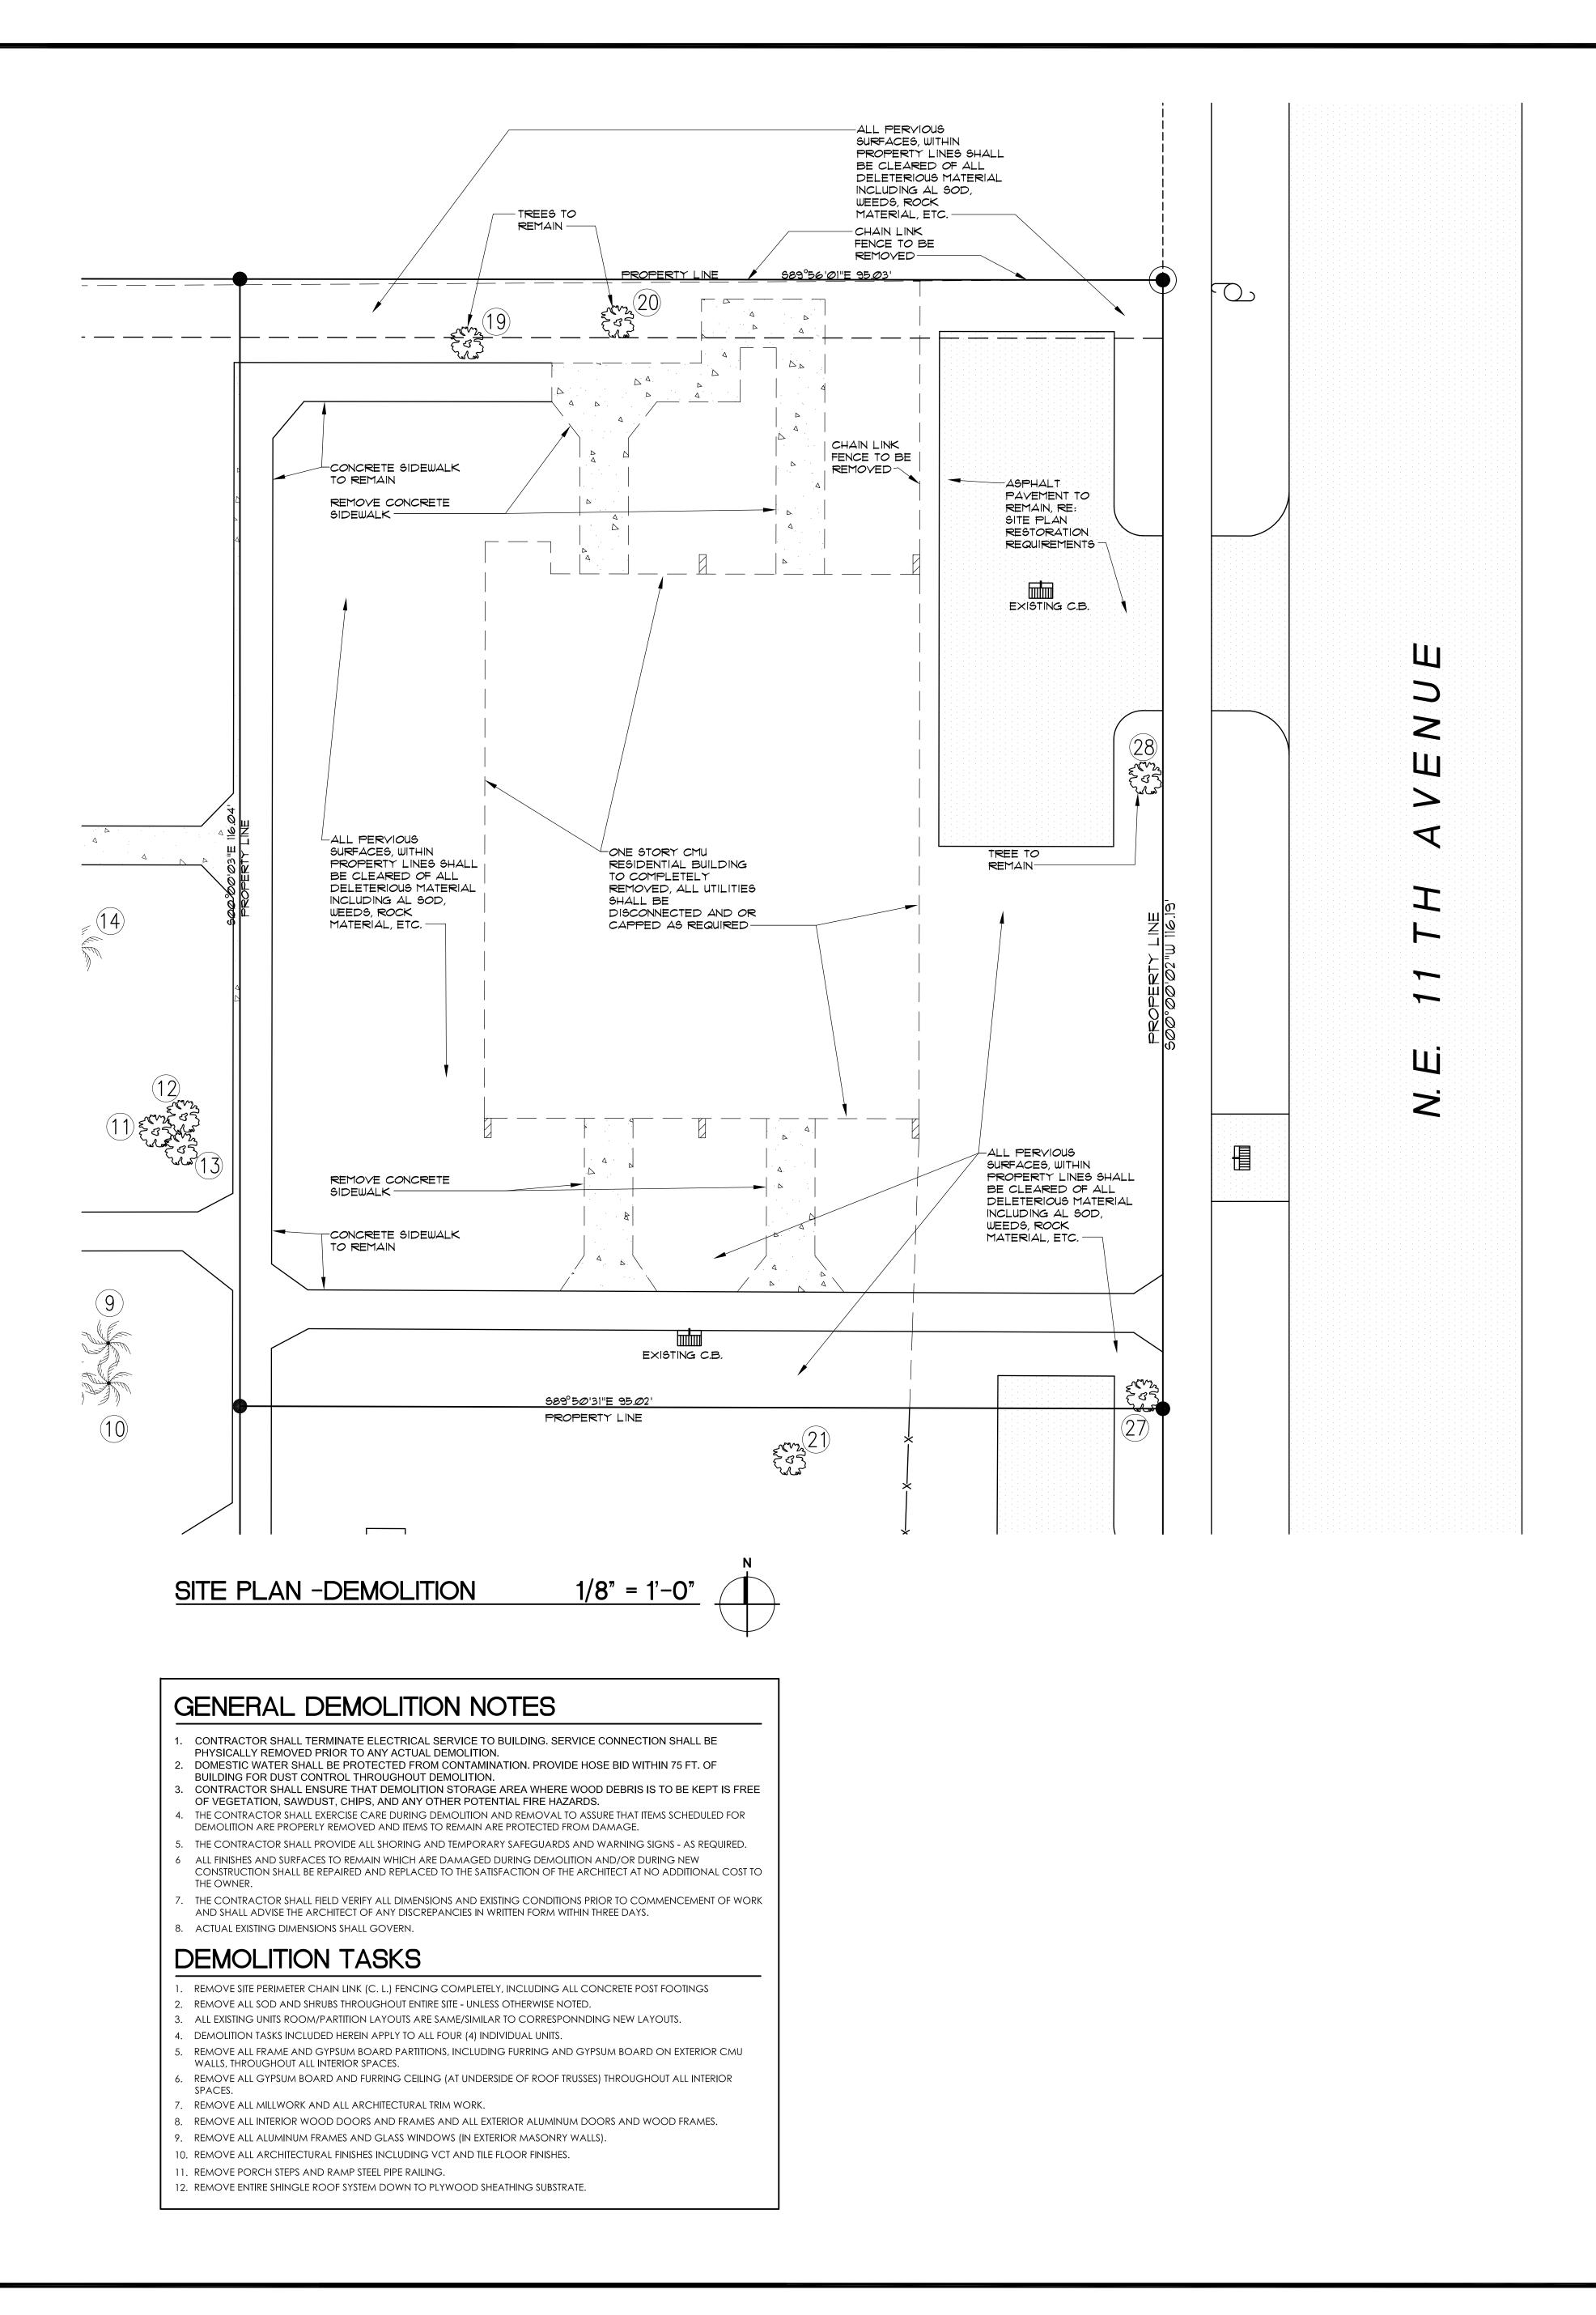


A L L E G U E Z ARCHITECTURE, INC. A R C H I T E C T U R E PLANNING INTERIOR DESIGN CONSTRUCTION MANAGEMENT 901 PONCE DE LEON BLVD., SUITE 202 CORAL GABLES, FLORIDA 33134 tel: 305.461.4001 fax: 305.461.6002 www.alleguezarchitecture.com
CONSULTANTS: MECHANICAL, ELECTRICAL, PLUMBING ENGINEER: GARTEK ENGINEERING CORP. 7210 SOUTHWEST 39TH TERRACE MIAMI, FLORIDA 33155 TEL: (305) 266-8997 FAX: (305) 264-9496 STRUCTURAL ENGINEER: BLISS & NYITRAY, INC. 800 DOUGLAS ROAD, SUITE 300 CORAL GABLES, FLORIDA 33134 TEL: (305) 442-7086 FAX: (305) 442-7092
PROJECT:
CITY OF MIAMI LIFE QUEST RENOVATIONS 14950 NE 11TH AVENUE
MIAMI, FL
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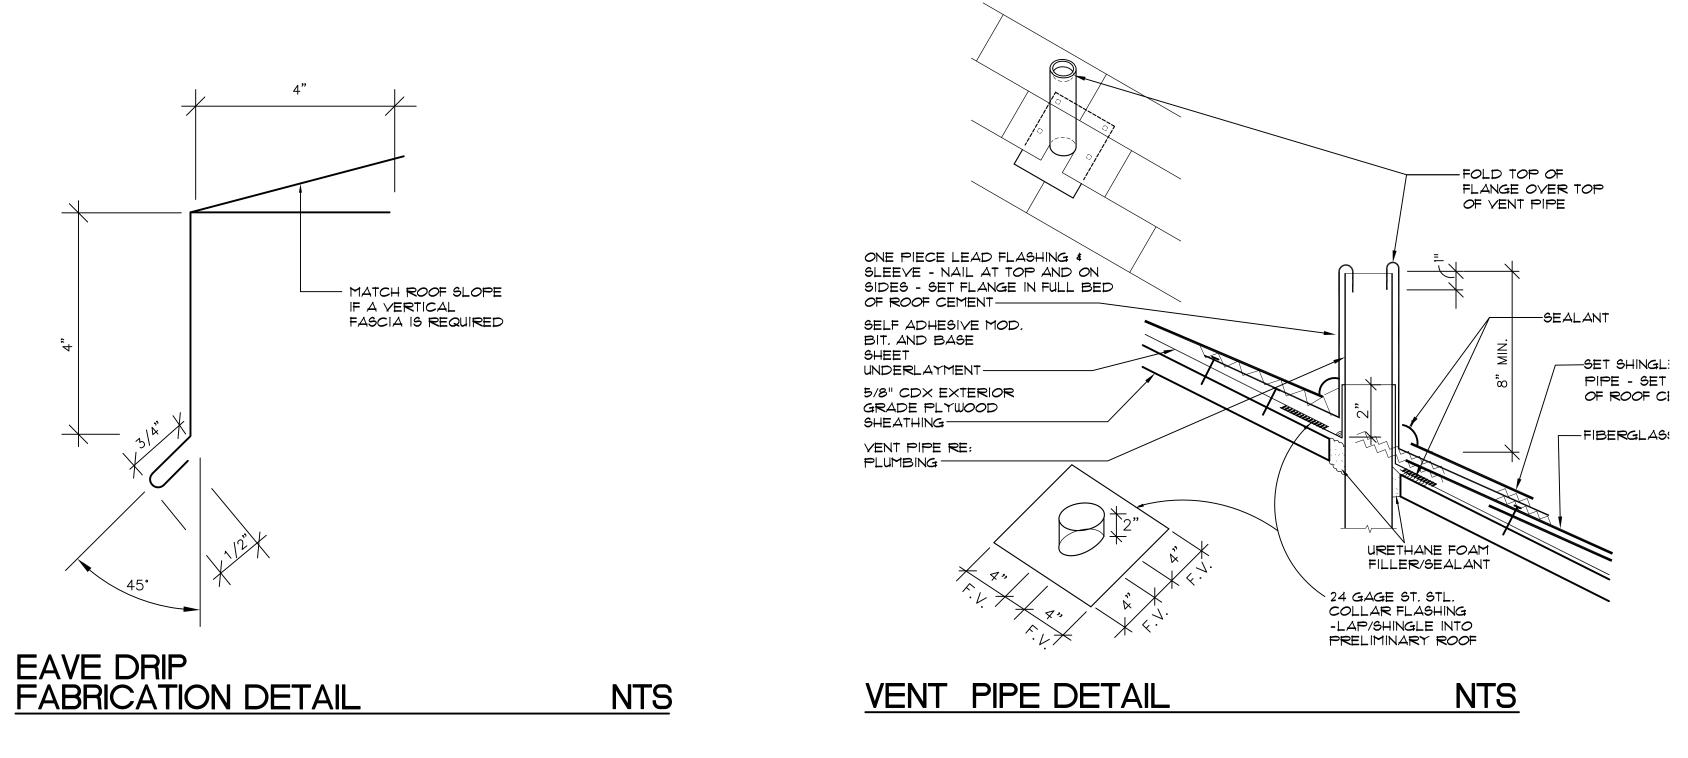


ARCHIT A R C H PLANNING CONSTRUC 901 PONCE DE CORAL GAE tel: 305.461.4001 WWW.&IIEGUA CONSULTANTS: MECHANICAL, ELECTRI GARTEK ENGINEE 7210 SOUTHWEST 39TH TEF MIAMI, FLORIDA 33155	RRACE
miami, florida 33155 tel: (305) 266-8997 fax: (structural engineei BLISS & NYITRAY, II 800 douglas road, suit	r: NC.
800 DOUGLAS ROAD, SUI CORAL GABLES, FLORIDA TEL: (305) 442-7086 FAX: (. 33134
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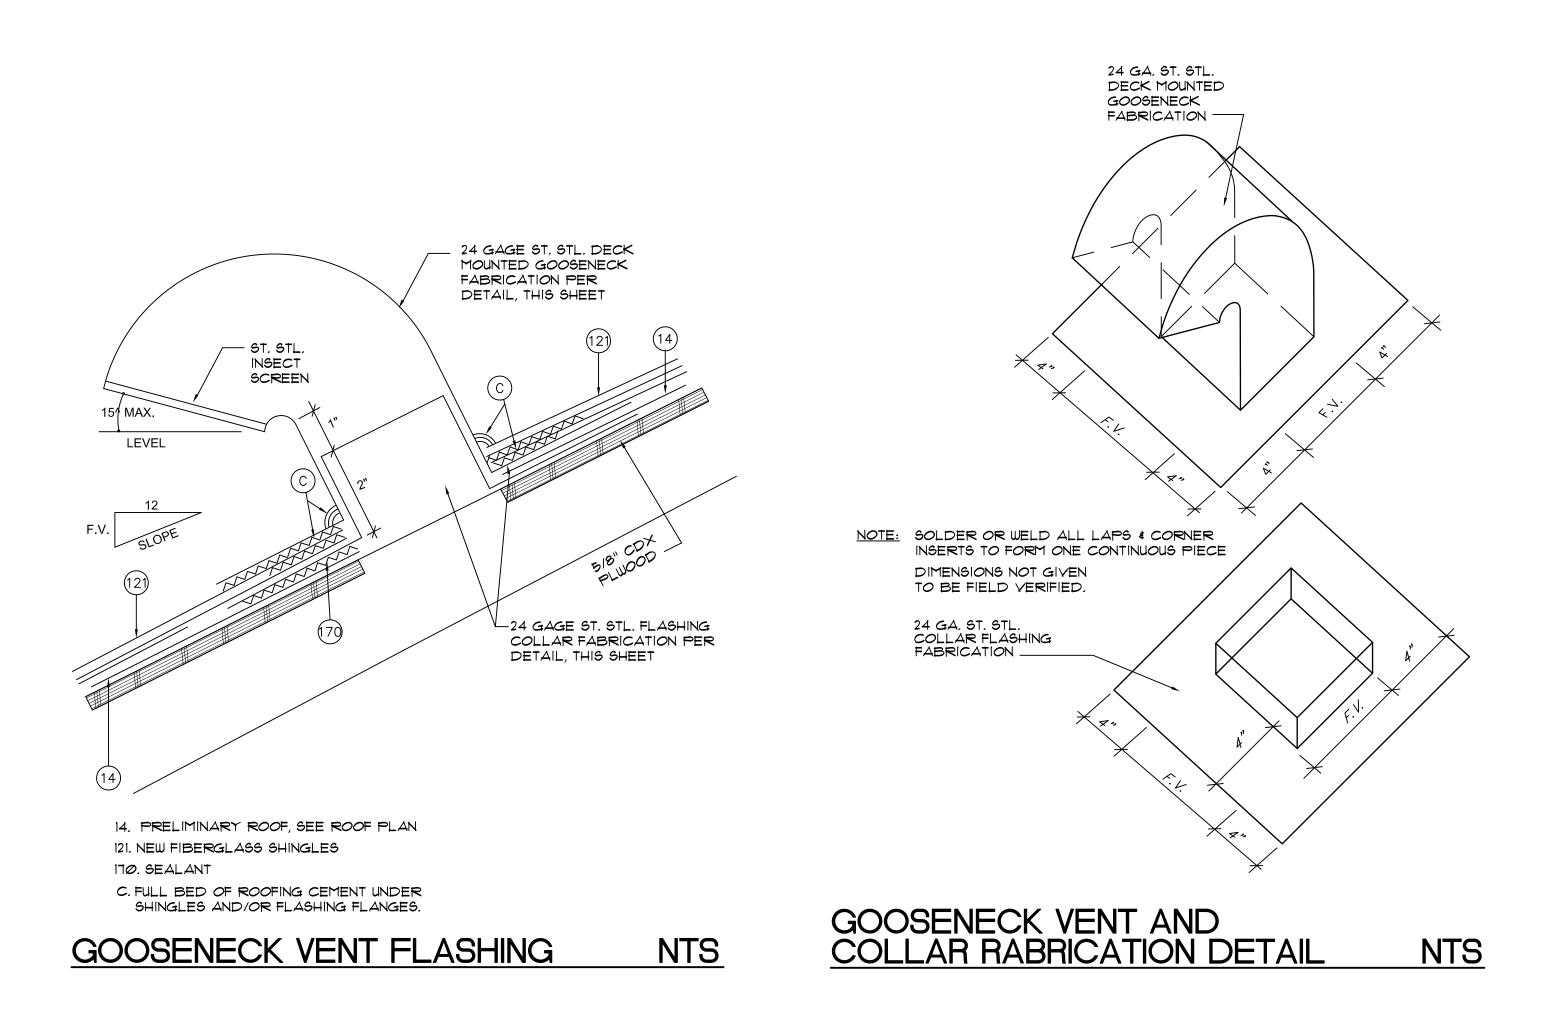


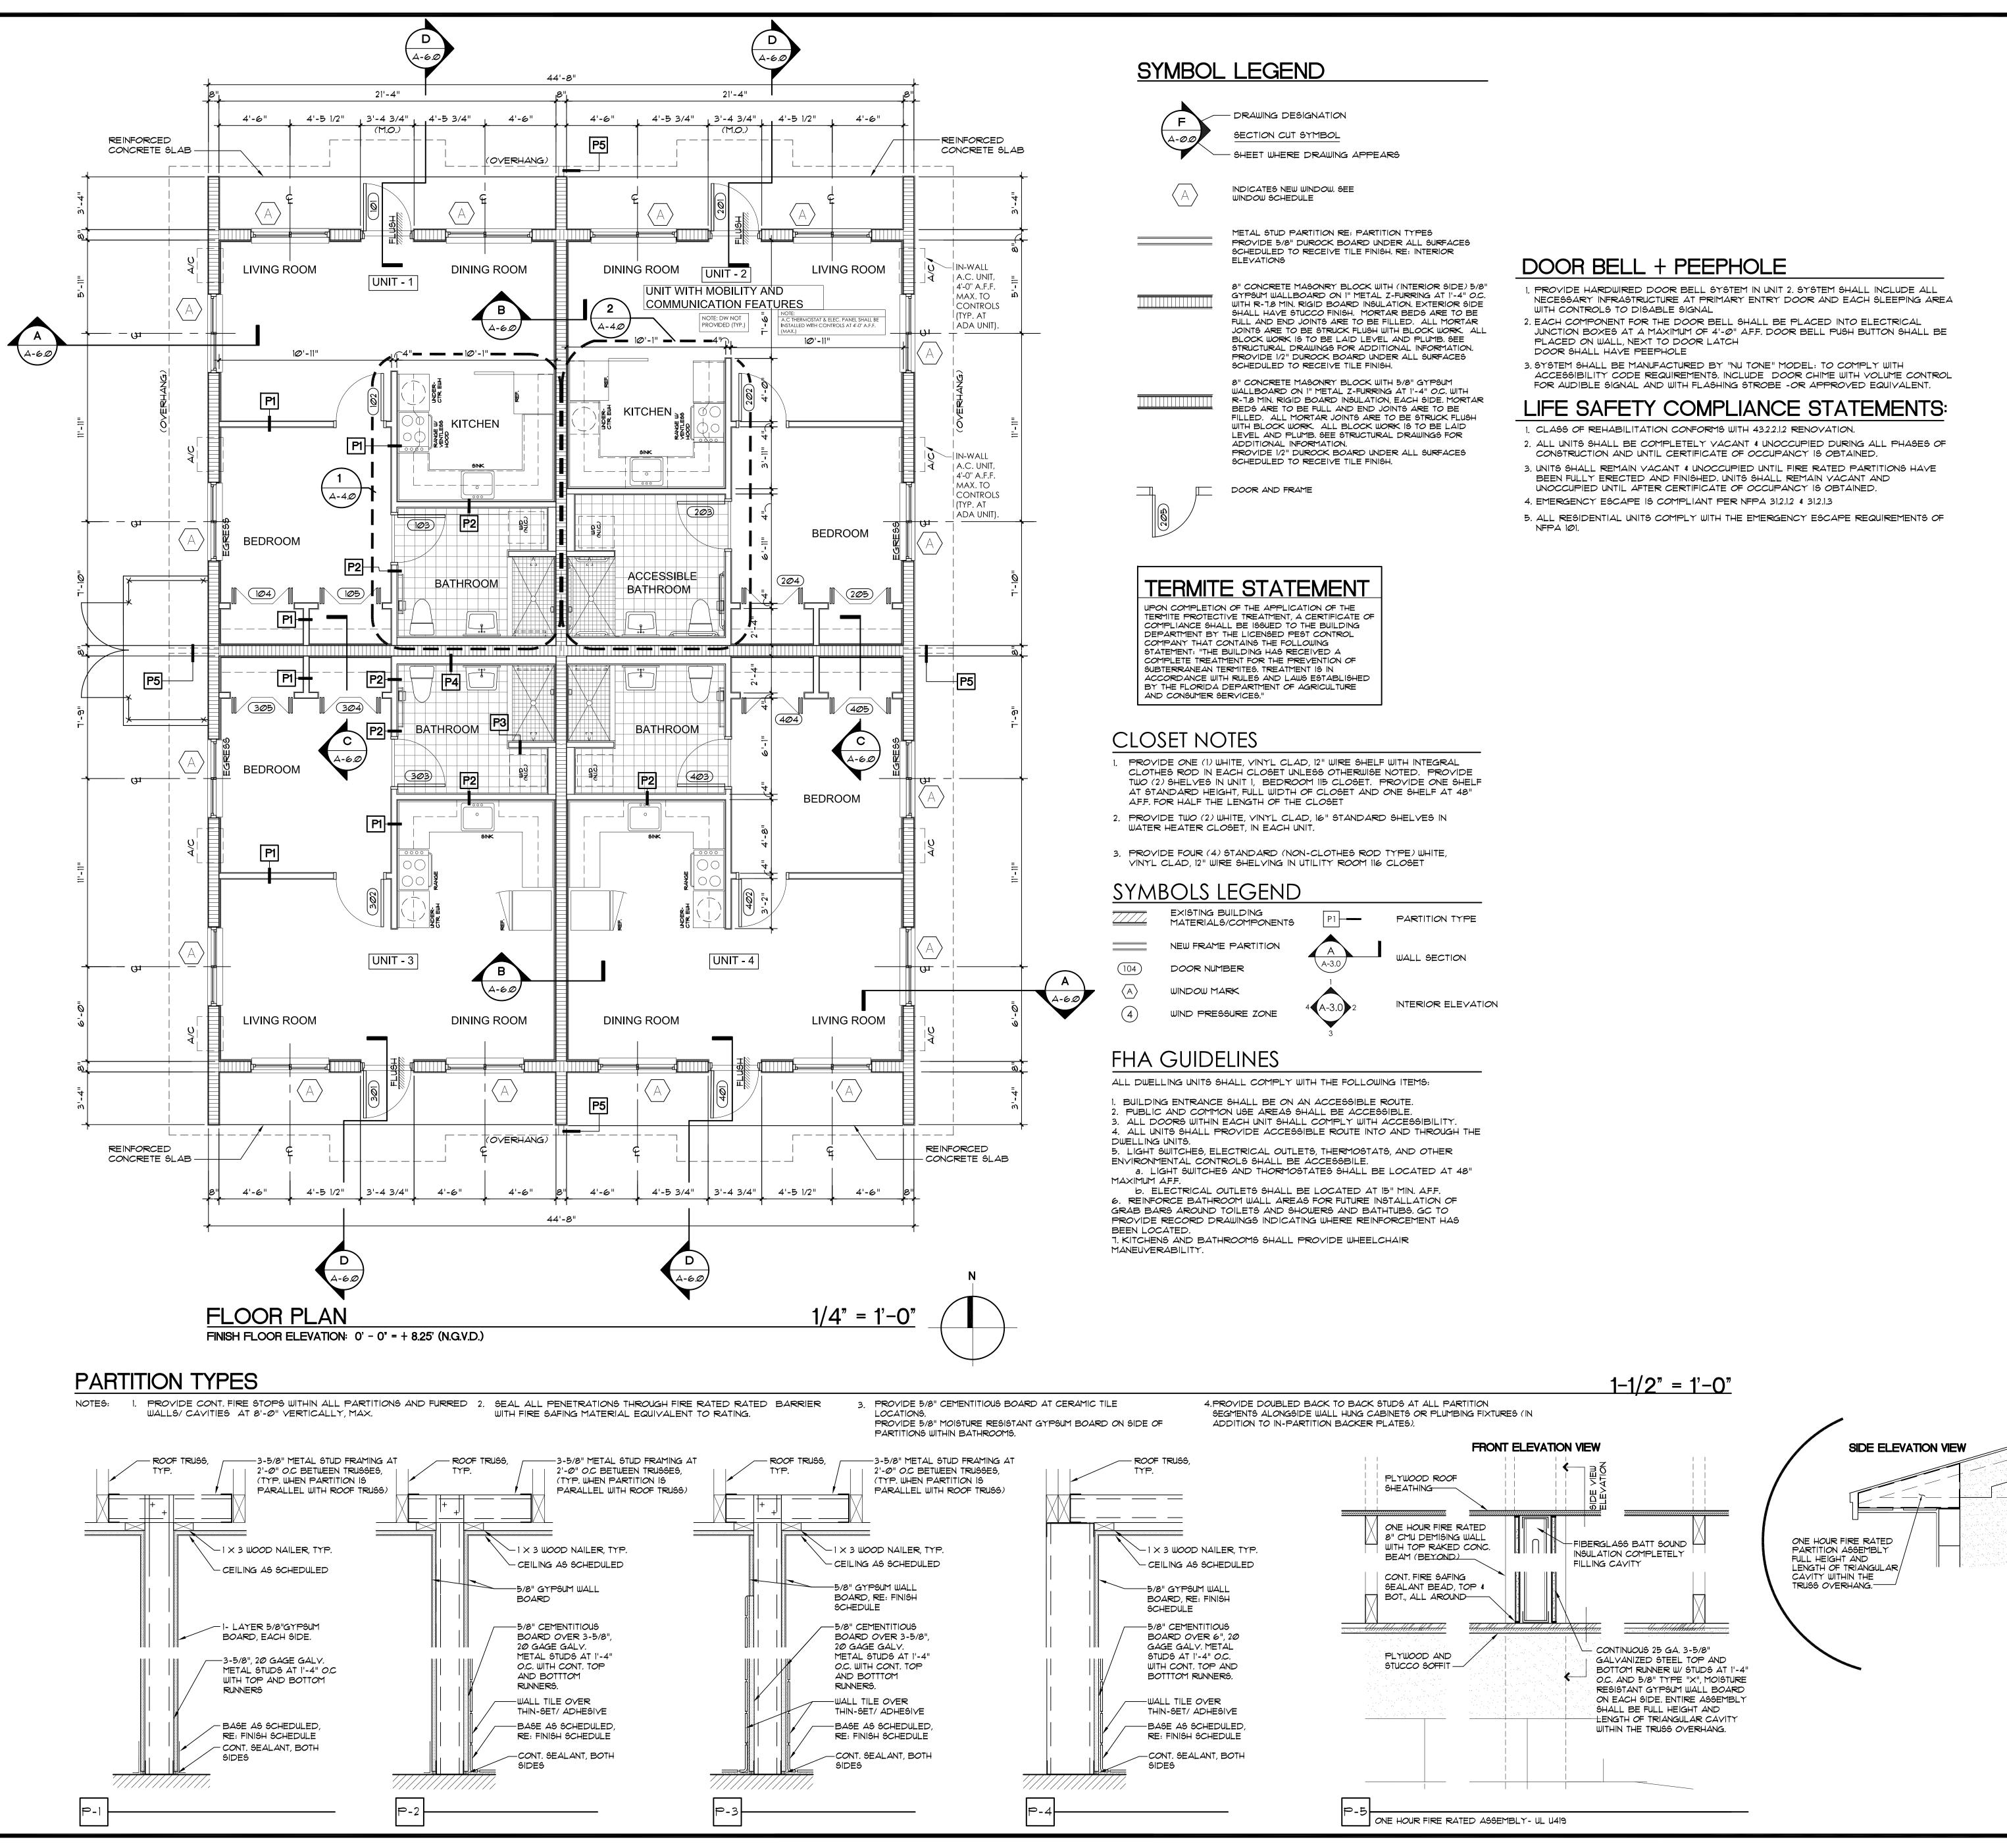
SYMBOL LEGEND
FIBERGLASS FOUR TAB ASPHALT SHINGLES
GOOSENECK VENT
ATTIC OFF-RIDGE VENT (SEE DETAILS ON SOFFIT A-4.1
O VTR VENT THROUGH ROOF
ROOF SYSTEM
1 FIBERGLASS REINFORCED FOUR TAB ASPHALT SHINGLE ROOFING SYSTEM
DECK TYPE: EXISTING WOOD PLANK OR PLYWOOD SHEATHING (SEE NOTE 4)
<u>UNDERLAYMENT:</u> PRO ARMOR SYNTHETIC ROOF UNDERLAYMENT NOA, * 14-1215,05
SHINGLE: TRUEDEFINITION DURATION AS MANUFACTURED BY OWENS CORNING ROOFING & ASPHALT LIC., NOA. * 16-0425.01 COLOR: QUARRY GRAY
ASPHALT SHINGLE SYSTEM WARRANTY: PROVIDE OWENS CORNING 20 YEARS PLATINUM PROTECTION ROOFING SYSTEM LIMITED WARRANTY. APPLICATOR'S WARRANTY: APPLICATOR SHALL PROVIDE A 2 YEARS (NO DOLLAR LIMIT) WARRANTY. SEE APPLICATOR'S WARRANTY NOTE FOR ADDITIONAL INFORMATION.
ROOFING NOTES
 CONTRACTOR SHALL OBTAIN A HIGH VELOCITY ROOFING PERMIT FROM THE GOVERNING AGENCY. ROOFING SYSTEM SHALL HAVE CURRENT MIAMI-DADE COUNTY PRODUCT APPROVAL, NOTICE OF ACCEPTANCE. ALL WORK SHALL BE IN ACCORDANCE WITH NRCA STEEP ROOFING MANUAL AND MANUFACTURER'S INSTALLATION REQUIREMENTS. CONTRACTOR SHALL RE-NAIL WOOD DECK IN ACCORDANCE WITH THE CURRENT PROVISIONS OF CHAPTER 15 (HIGH VELOCITY HURRICANE ZONES) OF THE FLORIDA BUILDING CODE. ROOFING SYSTEMS NOTED WITHIN ARE FOR BASIS AND DESIGN AND ARE SPECIFIED TO ESTABLISH PROJECT STANDARDS. ROOFER MUST BE AN OWENS CORNING ROOFING PLATINUM PREFERRED CONTRACTOR. MANUFACTURER SHALL INSPECT ROOFING INSTALLATION AS REQUIRED TO SATISFY WARRANTY TERMS.
SHOP DRAWING SUBMITTAL
SUBMIT SHOP DRAWINGS FOR ARCHITECT'S APPROVAL PRIOR TO ORDERING ROOFING SYSTEMS. SHOP DRAWINGS SHALL INCLUDE AT A MINIMUM THE FOLLOWING: A. PRODUCT DATA: PROVIDE MANUFACTURER'S INFORMATION ON MEMBRANE MATERIALS, BASE FLASHING, MATERIAL AND INSULATION INCLUDING DETAILS.
B. CALCULATIONS: MANUFACTURER SHALL PROVIDE WIND-UP LIFT DESIGN CRITERIA PER THE FLORIDA BUILDING CODE AND ASCE-1-98. INFORMATION SHALL BE PREPARED AND CERTIFIED BY A FLORIDA LICENSED PROFESSIONAL ENGINEER.
C. MANUFACTURER'S CERTIFICATE: CERTIFY THAT PRODUCTS MEET OR EXCEED SPECIFIED
REQUIREMENTS D. SUPPLY FLORIDA PRODUCT APPROVAL OR MIAMI DADE PRODUCT APPROVAL NOTICE OF ACCEPTANCE (N.O.A.) APPROVAL FOR SELECTED
SYSTEM. E. MATERIAL SAFETY DATA SHEETS: PROVIDE MSDS FOR ALL ROOFING PRODUCTS SUBMITTED.
APPLICATOR'S WARRANTY
THE ROOFING CONTRACTOR SHALL FURNISH WRITTEN WARRANTIES FOR A PERIOD OF TWO (2) YEARS FROM THE DATE OF PROJECT SUBSTANTIAL COMPLETION. THE ROOFER SHALL CERTIFY IN WRITING THAT SYSTEM HAS BEEN INSTALLED PER MANUFACTURER'S INSTALLATION INSTRUCTION/ N.O.A. AND WHEREAS ROOFING CONTRACTOR HAS CONTRACTED (EITHER DIRECTLY WITH OWNER OR INDIRECTLY AS A SUBCONTRACTOR) TO WARRANT SAID WORK AGAINST LEAKS, FAULTY OR DEFECTIVE MATERIALS, ROOFING COMPONENTS DEEMED FAULTY OR IN DISREPAIR, AND WORKMANSHIP FOR THE DESIGNATED WARRANTY PERIOD. DURING THE WARRANTY PERIOD THE CONTRACTOR WILL AT HIS/ HER OWN EXPENSE, MAKE OR CAUSE TO BE MADE SUCH REPAIRS TO OR REPLACEMENTS OF SAID WORK AS ARE NECESSARY TO CORRECT FAULTY AND DEFECTIVE WORK, AND AS ARE NECESSARY TO MAINTAIN SAID WORK IN WATERTIGHT CONDITION. ROOFING CONTRACTOR SHALL BE AN APPROVED SYSTEM MANUFACTURER APPLICATOR.

ARCHIT A R C H PLANNING CONSTRUC 901 PONCE DE CORAL GAB tel: 305.461.4001 WWW.allegue AA C	E G U E Z ECTURE, INC. I T E C T U R E INTERIOR DESIGN TION MANAGEMENT LEON BLVD., SUITE 202 LES, FLORIDA 33134 fax: 305.461.6002 Exarchitecture.com 0 0 2 7 4 6
MECHANICAL, ELECTRI GARTEK ENGINEEF 7210 southwest 39th ter miami, florida 33155	
structural engineef	
BLISS & NYITRAY, IN 800 DOUGLAS ROAD, SUIT CORAL GABLES, FLORIDA	E 300 33134
TEL: (305) 442-7086 FAX: (;	303) 442-7092
PROJECT:	
DEN REPL	E QUEST MOLITION AND ACEMENT 11TH AVENUE
DRAWING TITLE:	MIAMI, FL
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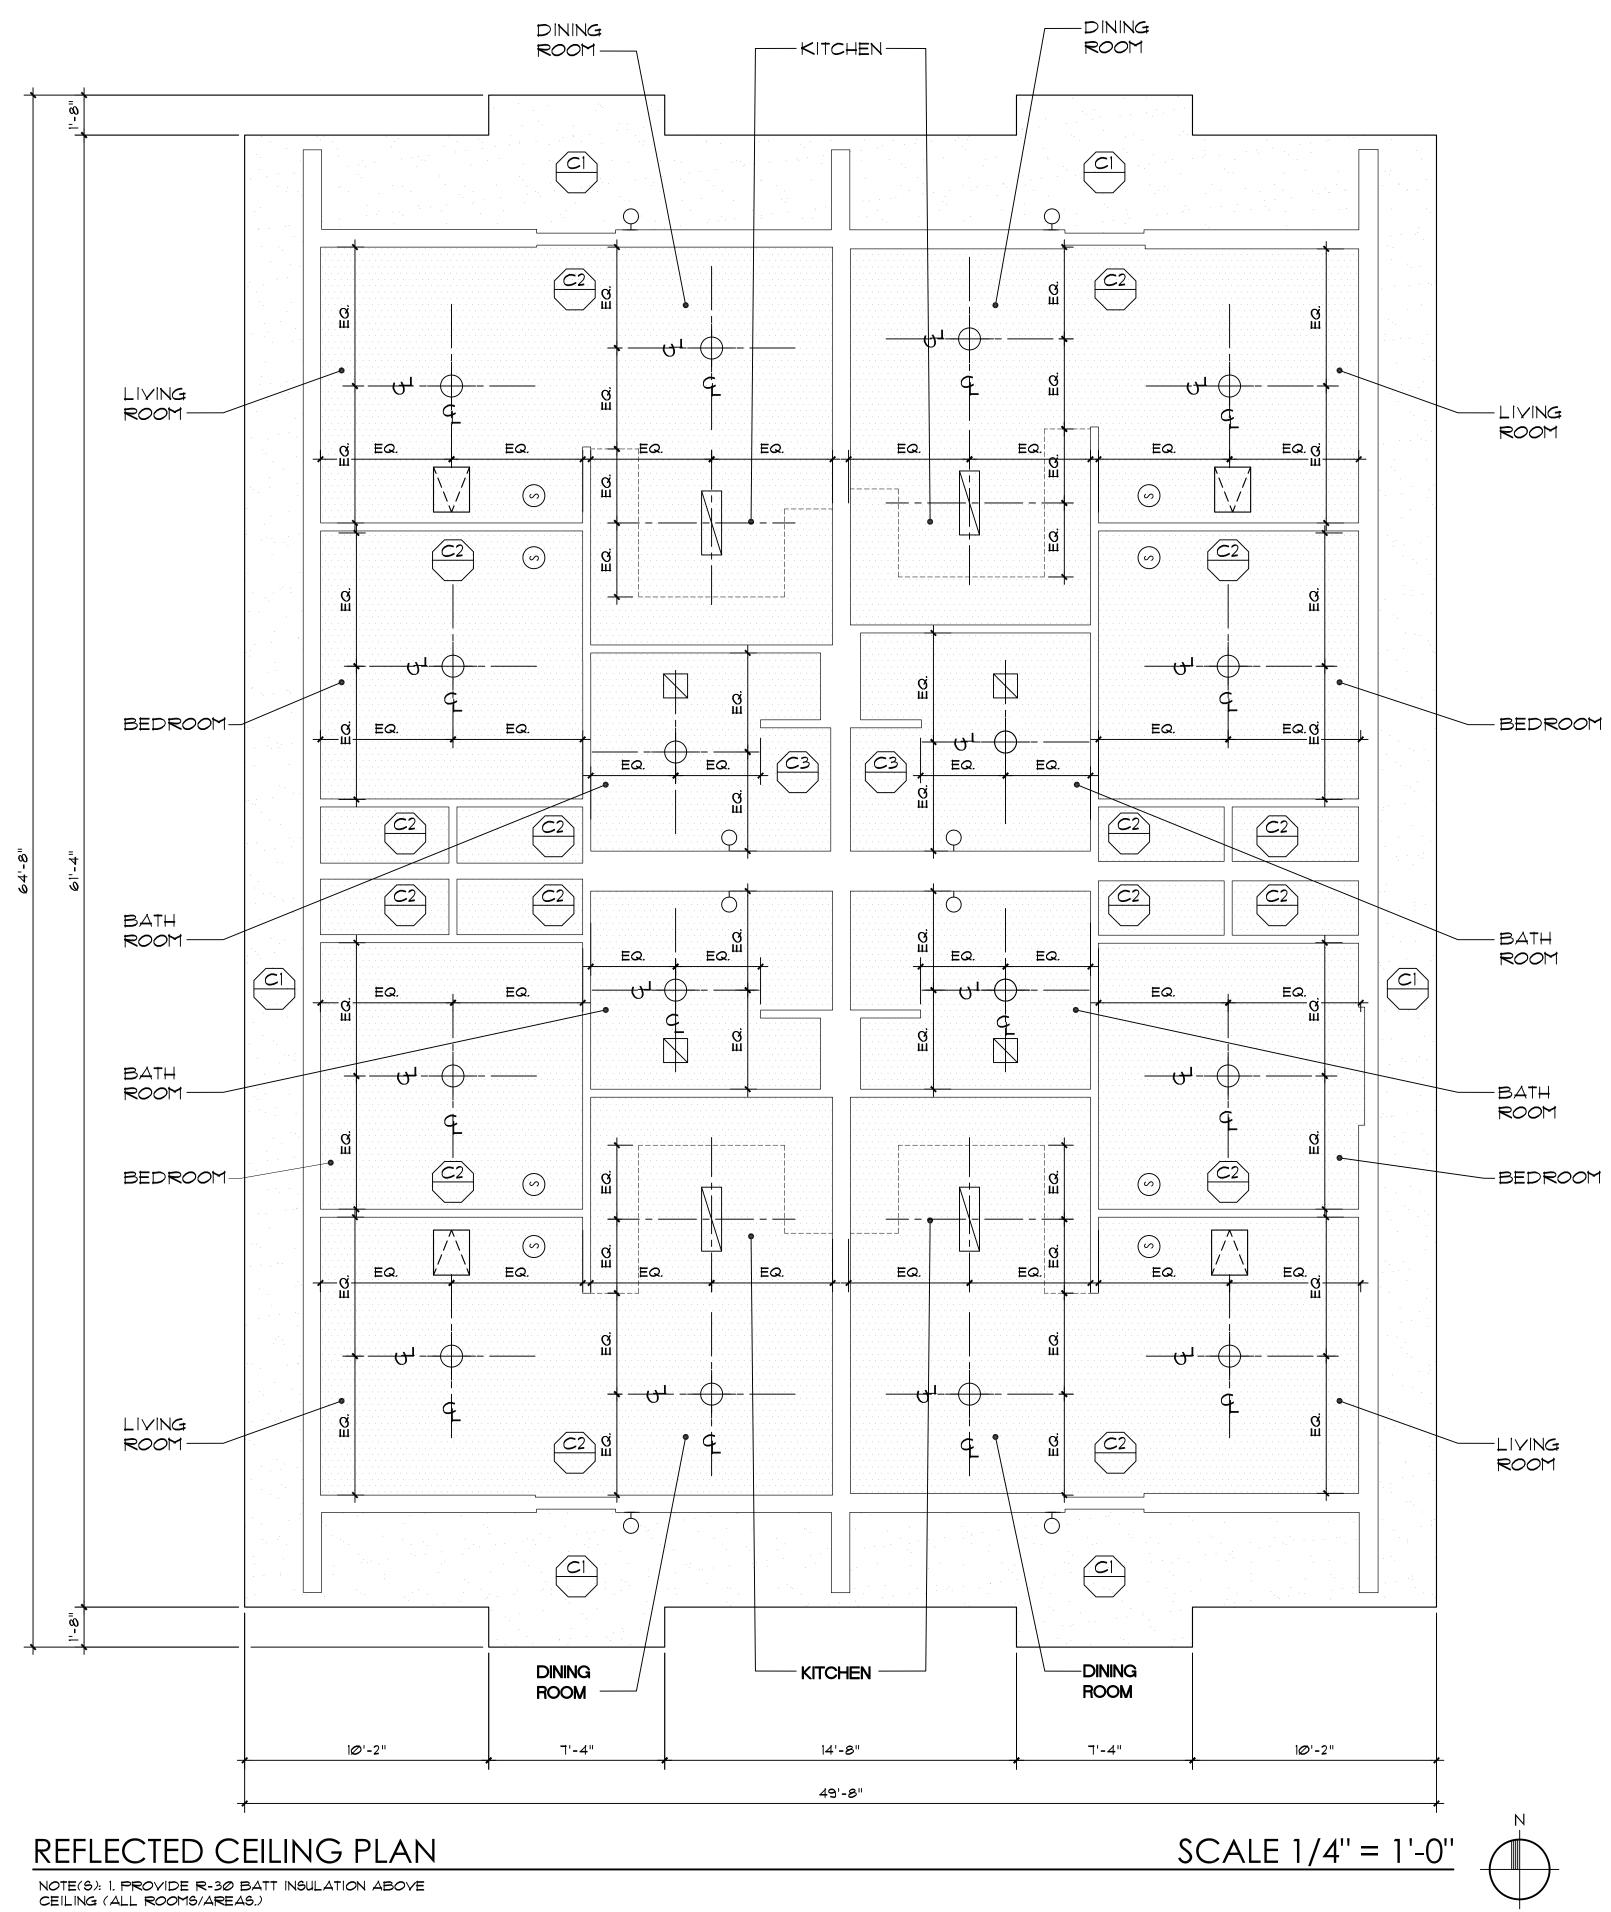


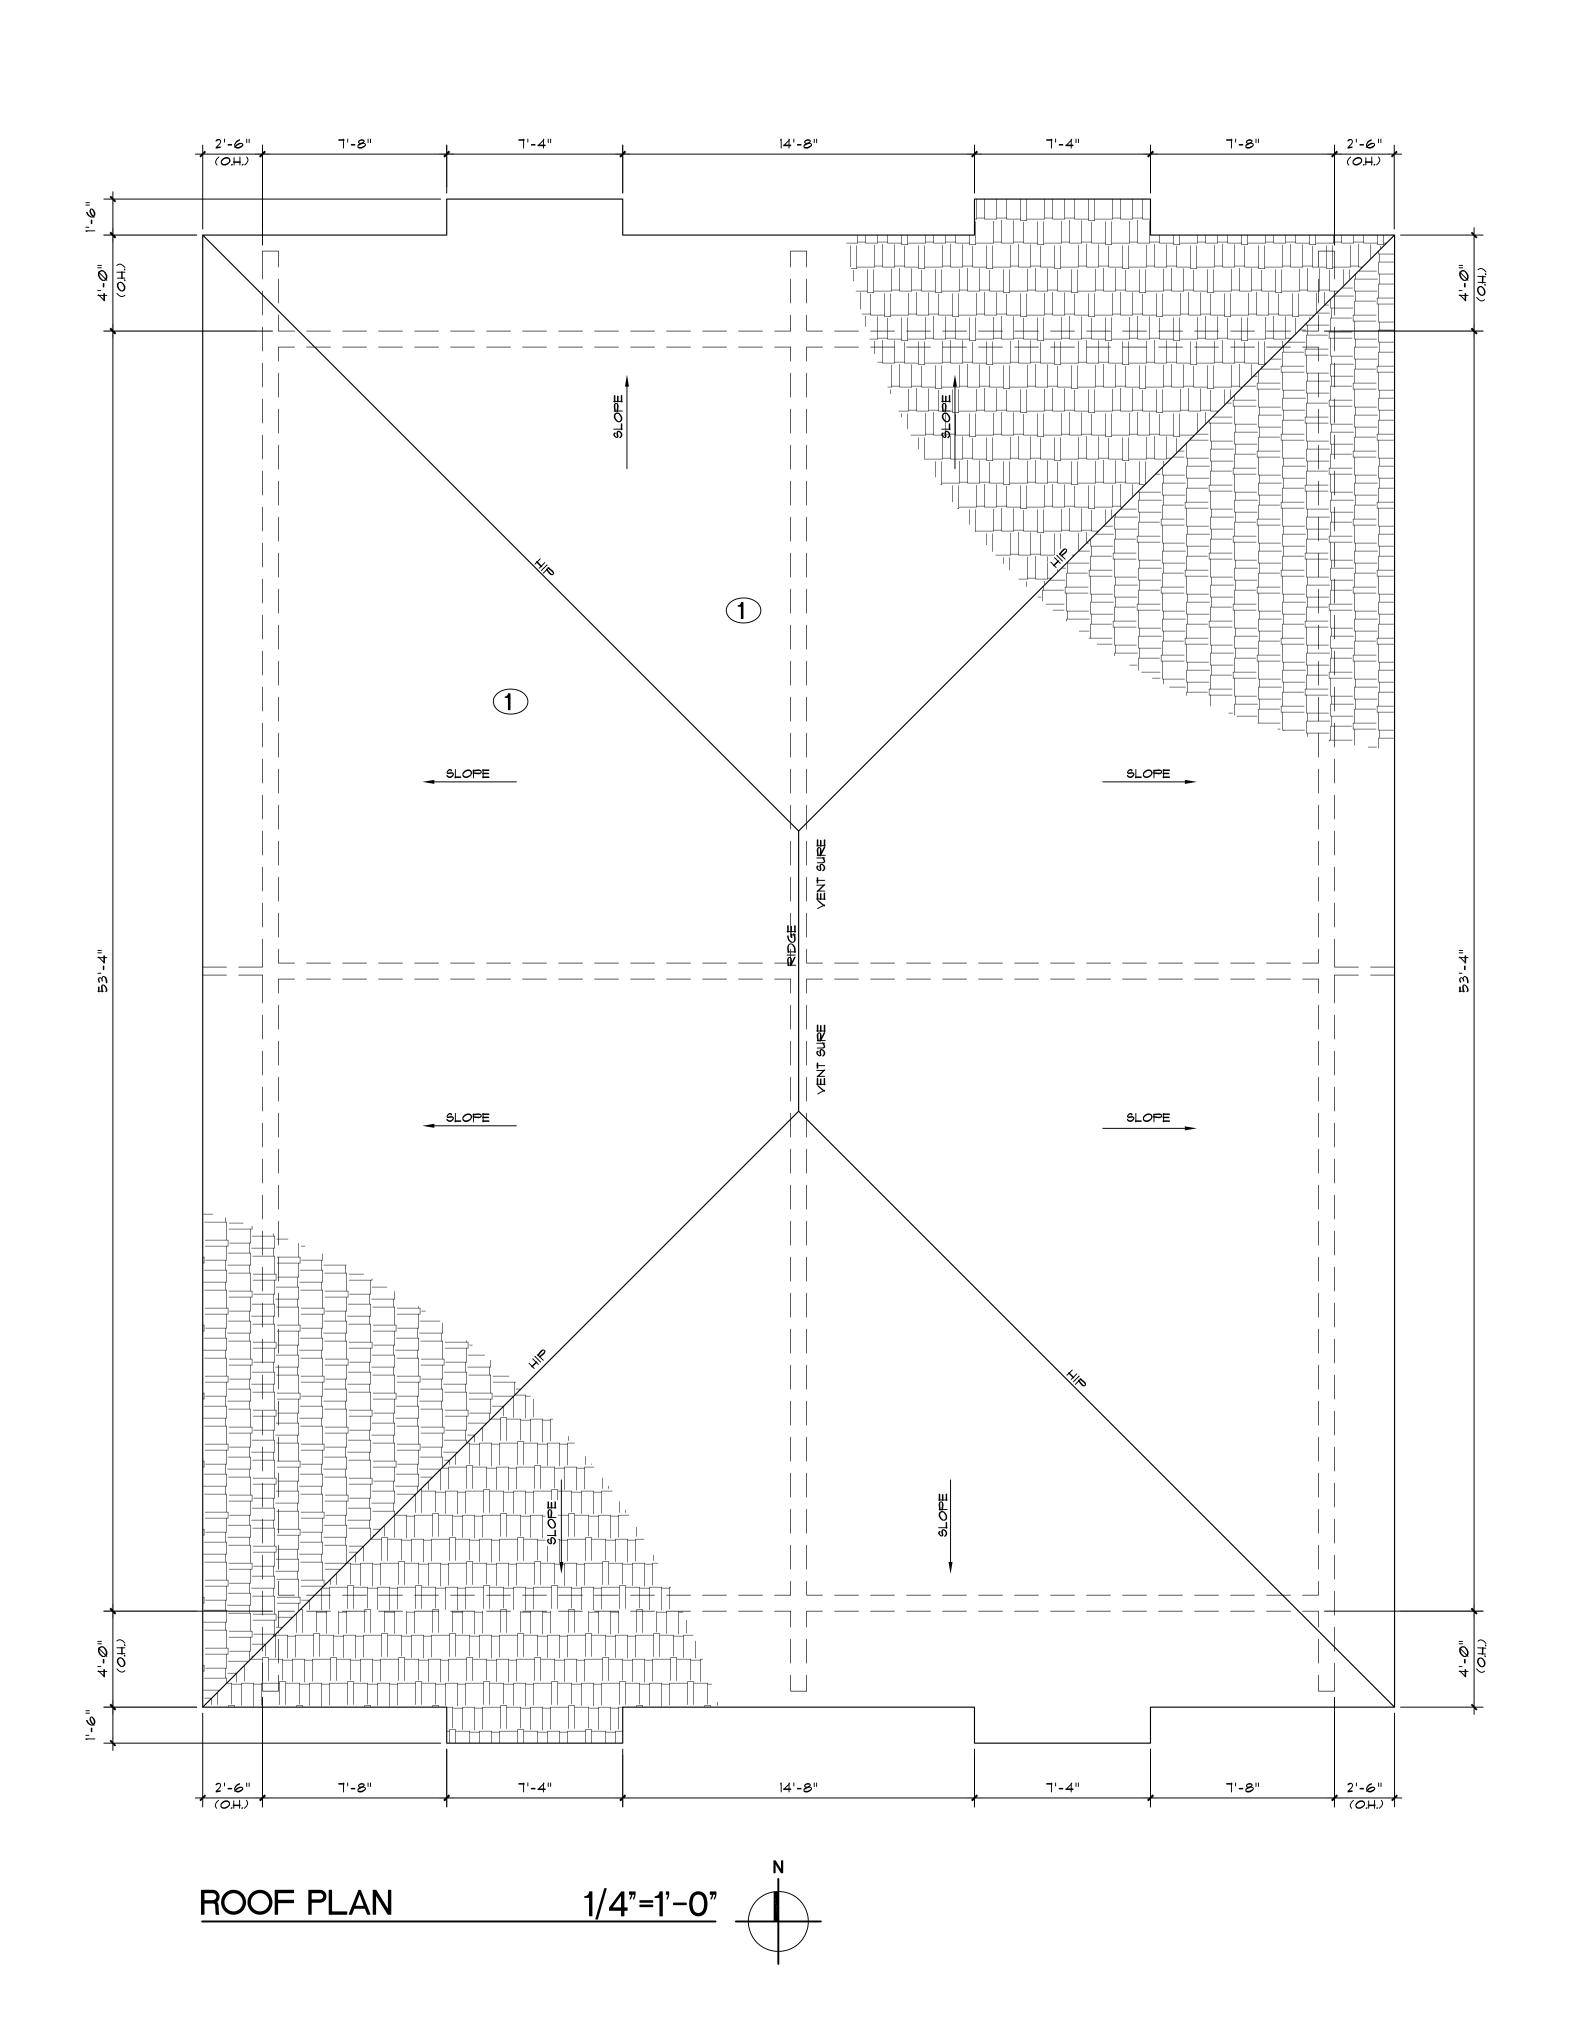
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ARCHITI A R C H I PLANNING CONSTRUCT 901 PONCE DE I CORAL GABL tel: 305.461.4001 WWW.allegue	E G U E Z ECTURE, INC. T E C T U R E INTERIOR DESIGN ION MANAGEMENT LEON BLVD., SUITE 202 ES, FLORIDA 33134 fax: 305.461.6002 zarchitecture.com
MECHANICAL, ELECTRIC GARTEK ENGINEERI	AL, PLUMBING ENGINEER: NG CORP.
7210 SOUTHWEST 39TH TERR/ MIAMI, FLORIDA 33155 TEL: (305) 266-8997 FAX: (30	
structural engineer: BLISS & NYITRAY, ING	
800 DOUGLAS ROAD, SUITE CORAL GABLES, FLORIDA 3 TEL: (305) 442-7086 FAX: (30	3134
PROJECT:	
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CEILING LEGEND

STUCCO (PRIME & PAINT) OVER GALVANIZED METAL LATH ON 15-LB ROOFING FELT OVER 1/2" CDX PLYWOOD SHEATHING OVER EXISTING WOOD TRUSSES

5/8" GYPSUM WALL BOARD (PRIME & PAINT) OVER 7/8" METAL FURRING CHANNELS AT 1'-4" O.C. MECHANICALLY FASTENED TO UNDERSIDE OF TRUSSES.

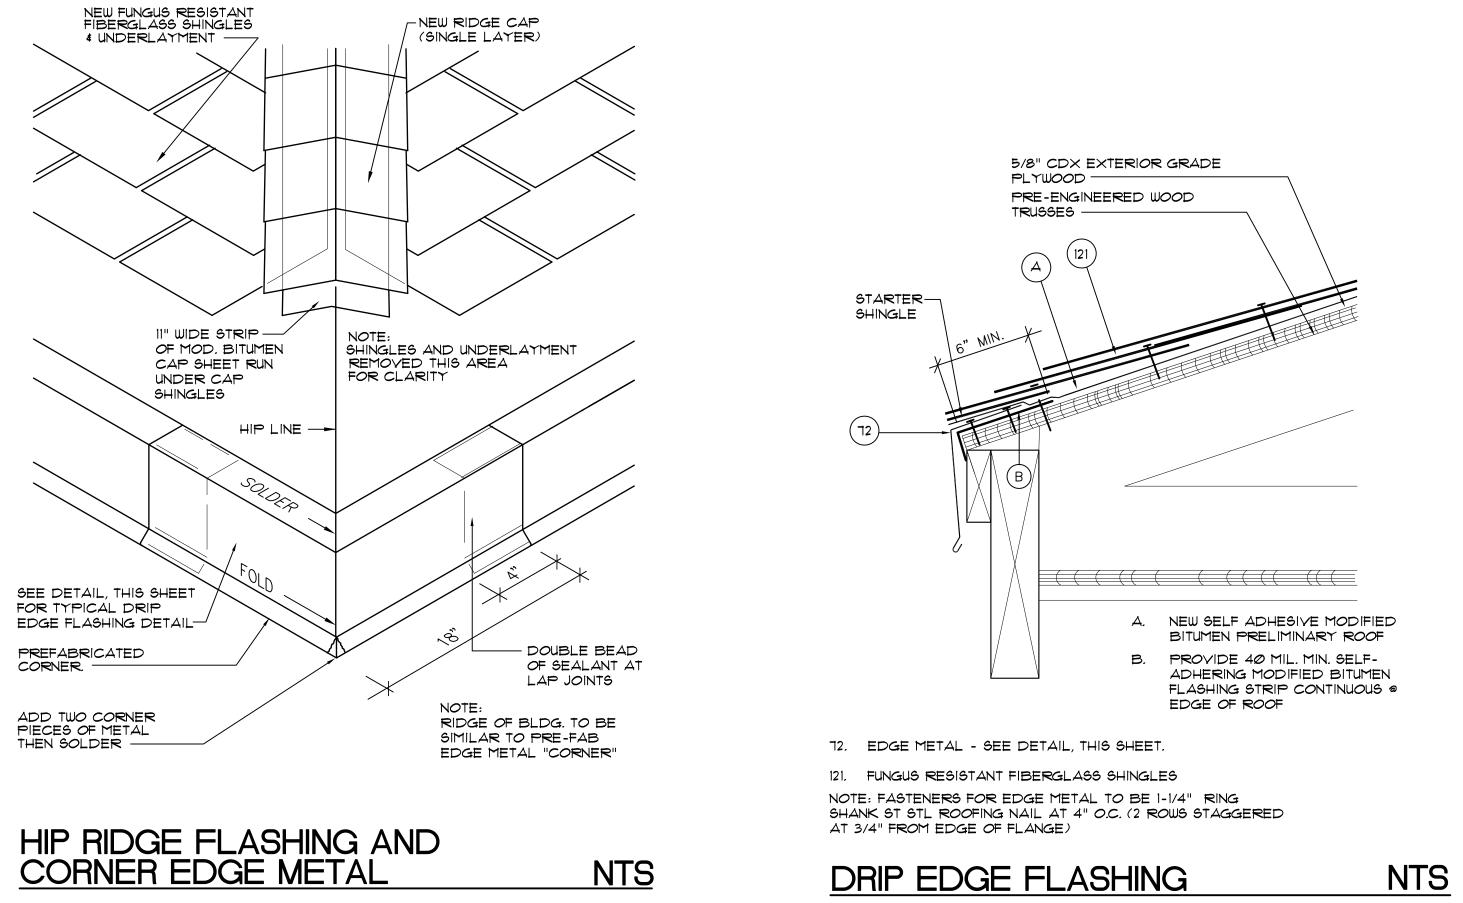5/8" MOISTURE RESISTANT GYPSUM BOARD (PRIME & PAINT) OVER 7/8" METAL FURRING CHANNELS AT 1'-4" O.C. MECHANICALLY FASTENED TO UNDERSIDE OF TRUSSES.


ATTIC ACCESS SPECIFICATION

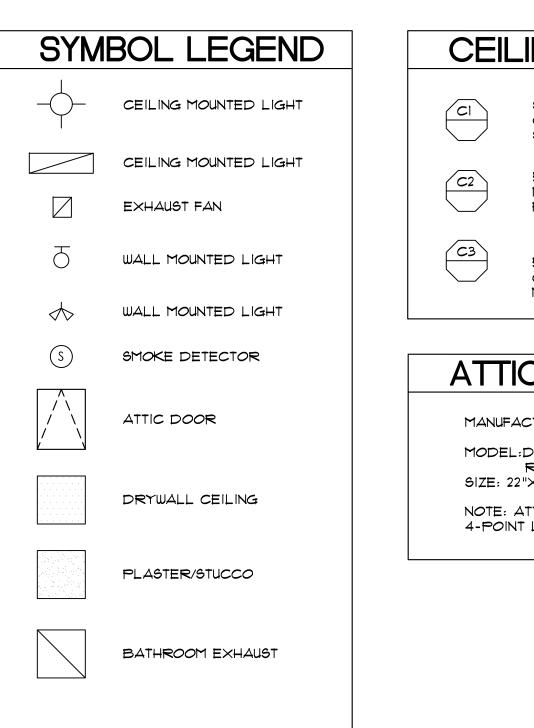
MANUFACTURED: BATTIC DOOR ENERGY CONSERVATION PRODUCTS OR APPROVED EQUIVALENT. MODEL:DELUXE E-2 HATCH ATTIC ACCESS SCUTTLE DOOR R-42 SIZE: 22"×30" (FITS INTO 22 1/2" × 30 1/2" ROUGH OPENING NOTE: ATTIC ACCESS DOOR SHALL BE PROVIDED WITH 4-POINT LOCKING: LATCH \$ HANDLES





GENERAL CABINET NOTES:

- 1. UPPER AND LOWER CABINETS SHALL BE CONSTRUCTED OF 3/4" PLYWOOD INCLUDING DOORS, DRAWER FRONTS AND SHELVES. DRAWER SIDES, BACKS AND BOTTOM SHALL BE 1/2" PLYWOOD, CABINET BACKS SHALL BE 1/4".
- 2. ALL CABINETS AND SHELVING, SHALL HAVE PLASTIC LAMINATE FINISH ON ALL EXPOSED WOOD SURFACES.
- 3. PULLS FOR BASE AND WALL CABINETS SHALL BE 3/16" \times 4" Long stainless steel wire pulls with satin finish.
- 4. ALL HINGES FOR NEW CABINETS SHALL BE CONCEALED FULL OVERLAY, CUP, FREE SWING TYPE HINGES. FOR AMOUNT OF HINGES PER DOOR FOLLOW MANUFACTURER'S RECOMMENDATIONS.
- 5. ALL SHELVES INSIDE CABINETS SHALL BE ADJUSTABLE AND MOUNTED ON ALUMINUM SHELF SUPPORTS/STANDARDS (TYPICAL OF 4 PER SHELF).
- 6. PROVIDE IN-PARTITION SUPPORTS FOR CABINET AND COUNTERTOP INSTALLATION AS REQUIRED.
- ALL FINISH MATERIAL COLORS SHALL BE SELECTED BY THE ARCHITECT.
- 8. PROVIDE EDGE BANDS ON ALL PLYWOOD SHELVES.
- 9. PROVIDE SHOP DRAWINGS BEFORE MANUFACTURING AND INSTALLATION OF BUILT-INS.
- 10. CONTRACTOR SHALL COORDINATE ALL CABINETRY OPENINGS WITH FINAL SELECTED APPLIANCES

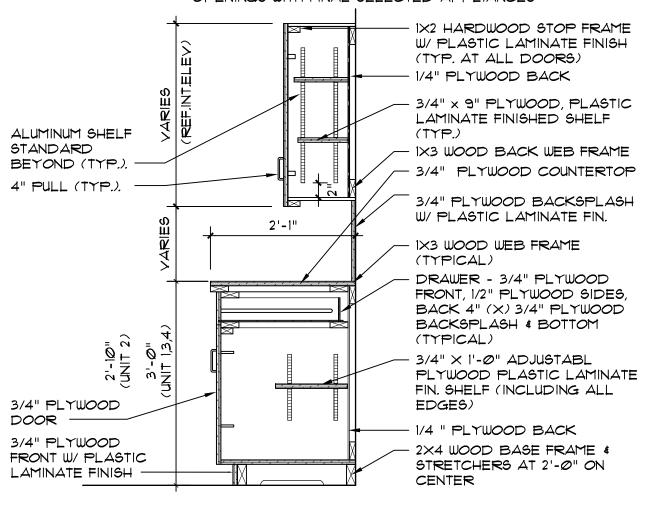

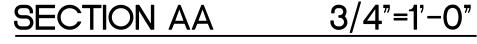


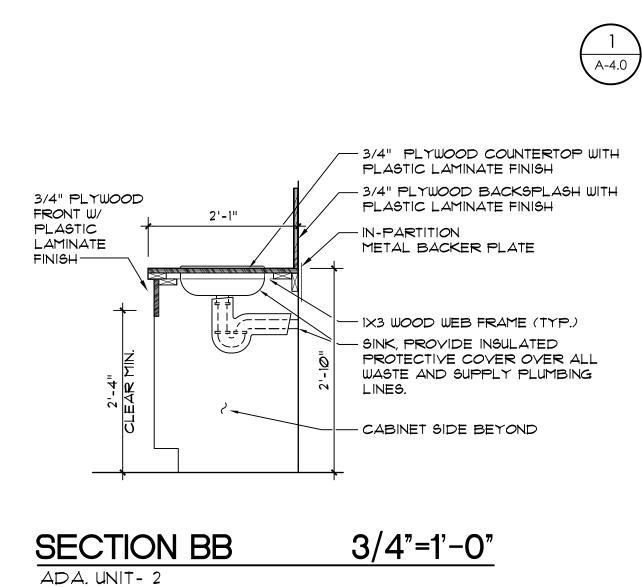

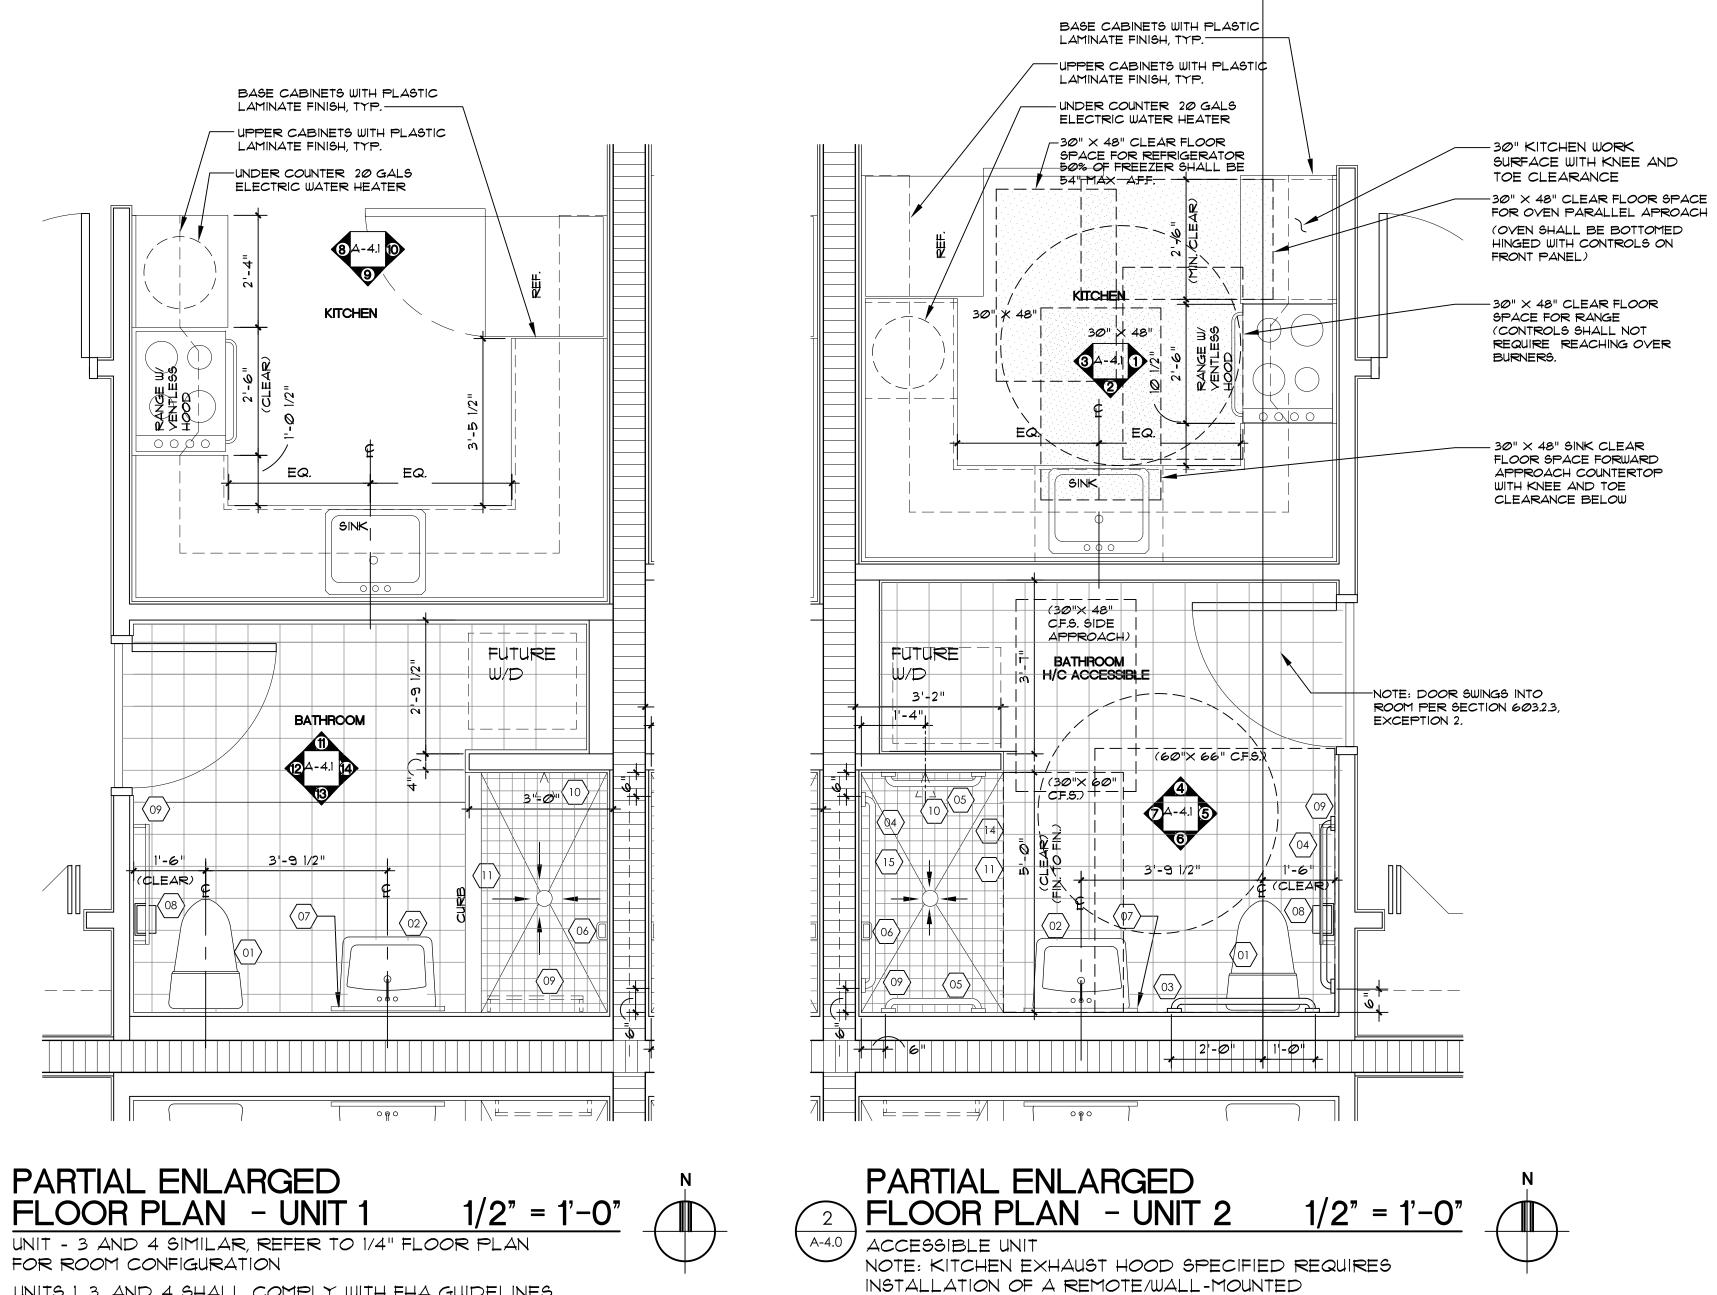

OPERATION SWITCH.

UNITS 1, 3, AND 4 SHALL COMPLY WITH FHA GUIDELINES, SEE SHEET A-2.0 FOR LIST OF REQUIRED ITEMS THAT ARE PART OF THIS CONTRACT

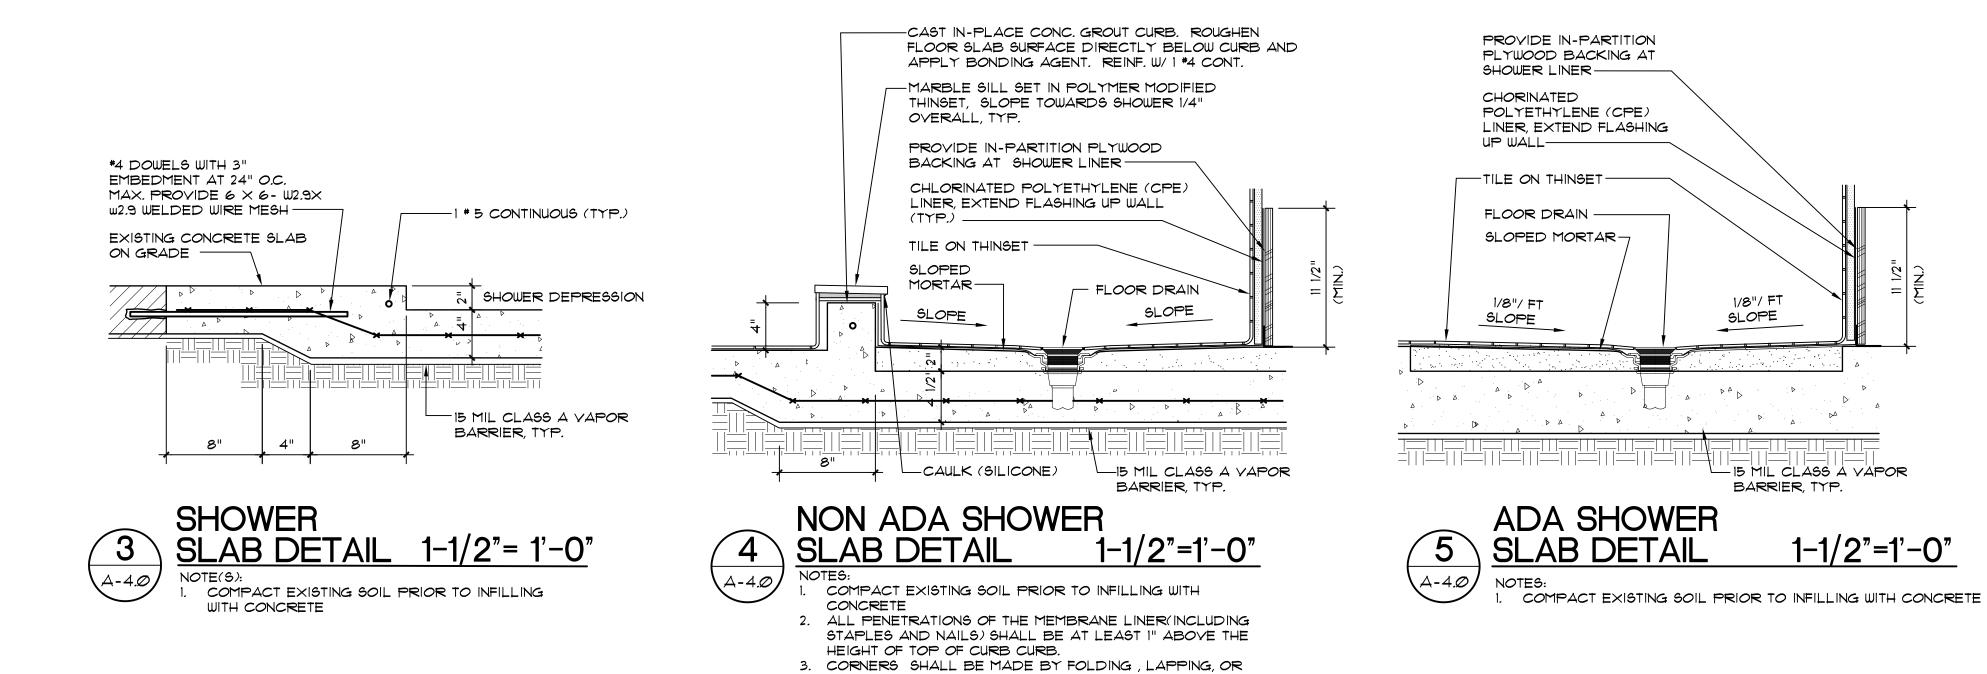

SOLVENT WELDING WITH APPROVED MATERIAL. 4. JOINTS AND SEAMS OF MEMBRANE LINEAR SHALL BE

MANUFACTURER.

FOR FURTHER INFORMATION.


MADE USING MATERIALS APPROVED BY THE MEMBRANE

5. CONCRETE SHALL BE 3,000 PSI, REFERENCE INFILL NOTES

TC	TOILET ROOM ACCESSORY LEGEND			
ITEM NO.	DESCRIPTION	MODEL	REMARK	
$\langle 1 \rangle$	ACCESSIBLE WATER CLOSET	ACCESSIBLE W.C.	REFER TO PLUMBING DRAWINGS	
(02)	WALL HUNG ACCESSIBLE LAVATORY	ACCESSIBLE LAVATORY	REFER TO PLUMBING: DRAWINGS	
(03)	36" GRAB BAR (1-1/4" O.D. STAINLESS STEEL BAR)	BOBRICK MODEL "B-5806.99 × 36'	PROVIDE WITH IN-WALL SUPPORT METAL REINFORCEMENT PLATE SHALL BE 18 GAGE X 6" X SPAN OF GRAB BAR, MIN.	
(04)	42" GRAB BAR (1-1/4" O.D. STAINLESS STEEL BAR)	BOBRICK MODEL "B-5806.99 × 42"	PROVIDE WITH IN-WALL SUPPORT METAL REINFORCEMENT PLATE SHALL BE 18 GAGE X 6" X SPAN OF GRAB BAR, MIN.	
(05)	24" GRAB BAR (1-1/4" O.D. STAINLESS STEEL BAR)	BOBRICK MODEL "B-5806.99 × 24"	PROVIDE WITH IN-WALL SUPPORT METAL REINFORCEMENT PLATE SHALL BE 18 GAGE X 6" X SPAN OF GRAB BAR, MIN,	
(06)	CERAMIC SOAP DISH	DALTILE BA125		
(07)	RECESSED STAINLESS STEEL MEDICINE CABINET W/ MIRROR	BOBRICK MODEL "B-165-1836"	CENTER ABOVE LAVATORY BOTTOM OF REFLECTED SURFACE SHALL BE MOUNTED AT 40" AFF. MAX.	
(08)	CERAMIC TOILET PAPER HOLDER	DALTILE BATTT		
(09)	18" CERAMIC TOWEL BAR	DALTILE BA130	CLIP ON MOUNT	
$\langle 10 \rangle$	SHOWER SYSTEM KIT	AMERICAN STANDARD	REFER TO PLUMBING DRAWINGS	
$\langle 11 \rangle$	SHOWER CURTAIN ROD WITH CONCEALED MOUNTING	BOBRICK MODEL "B-201	SHOWER CURTAIN ROD WITH CONCEALED MOUNTING	
(12)	VINYL SHOWER CURTAIN	BOBRICK MODEL "204-2"		
(13)	SHOWER CURTAIN HOOKS	BOBRICK MODEL "204-1"		
$\langle 14 \rangle$	COLLAPSIBLE WATER DAM	CWR-42	BARRIER FREE WATER DAM COLOR "WHITE"	
$\langle 15 \rangle$	48" GRAB BAR (1-1/4" O.D. STAINLESS STEEL BAR)	BOBRICK MODEL "B-5806.99 × 48"	PROVIDE WITH IN-WALL SUPPORT METAL REINFORCEMENT PLATE SHALL BE 18 GAGE X 6" X SPAN OF GRAB BAR, MIN.	
$\langle 16 \rangle$	WATER CLOGET SEAT	BOBRICK		
NOTE(S	NOTE(S) 1. ALL TOILET ROOM ACCESSORIES SHALL BE AS SPECIFIED OR APPROVED EQUIVALENT 2. ALL EXPOSED PIPES IN KNEE SPACE SHALL BE INSULATED.			
	2. ALL EXPOSED FIFES IN NEE SPACE SHALL BE INSULATED. 3. STEEL STUDS SUPPORTING WALL HUNG PLUMBING FIXTURES SHALL BE DOUBLED AND OR SHALL BE A MINIMUM OF 20 GA., STUDS SHALL BE RIGIDLY CONNECTED AT TOP			
	AND BOTTOM. BACKER PLATES SHALL BE PROVIDED AS A SUPPORT/FASTENER SURFACE FOR ALL WALL HUNG ITEMS AND SHALL BE GALVANIZED STEEL, 18 GA. (MIN.)			
	AND SHALL BE SECURELY FASTENED TO NOT LESS THAN TWO (2) STUDS, WALLS SHALL BE REINFORCED AROUND ALL TOILETS AND SHOWERS FOR FUTURE INSTALLATION OF GRAB BARS IN UNITS 1, 3 AND 4 TO MEET FHA CRITERIA.			
	4. GARMENT HOOKS AT TOILET STALL DOORS SHALL BE WITH BUMPER			
5. PROVIDE ALUMINUM HEAT SINC AT BOTTOM OF THE PANELS AND DOORS 6. SUBMIT SHOP DRAWINGS FOR ARCHITECT'S REVIEW PRIOR TO ORDERING				
	TOILET ACCESSORIES. 1. AT ALL SHOWER COMPARTMENTS, CEMENTITIOUS MORTAR BOARD AND 4" (1) (1) (1) (2) (2) (2) (2) (2) (2) (2) (2) (2) (2			
	(X) 4" CERAMIC TILE SHALL BE INSTALLED FROM FIN. FLOOR TO UNDERSIDE OF CEILING.			


ARCHI ARCHI PLANNING CONSTRUC 901 PONCE D CORAL GA tel: 305.461.4001 WWW.allegu AA C	E G U E TECTURE, IN I T E C T U R I T E C T U R I NTERIOR DESIC CTION MANAGEMEI E LEON BLVD., SUITE 2 BLES, FLORIDA 331 fax: 305.461.60 Jezarchitecture.cc C O O 2 7 4 6 IIICAL, PLUMBING ENGINEER:
7210 SOUTHWEST 39TH T MIAMI, FLORIDA 33155 TEL: (305) 266-8997 FAX STRUCTURAL ENGINE BLISS & NYITRAY, 800 DOUGLAS ROAD, S CORAL GABLES, FLORIE TEL: (305) 442-7086 FAX	IERRACE K: (305) 264-9496 EER: , INC. UITE 300 DA 33134
PROJECT:	
LI REN	y of miami fe quest iovations e 11th aven
DRAWING TITLE:	MIAMI, FL
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SEPT	EMBER 15, 2014



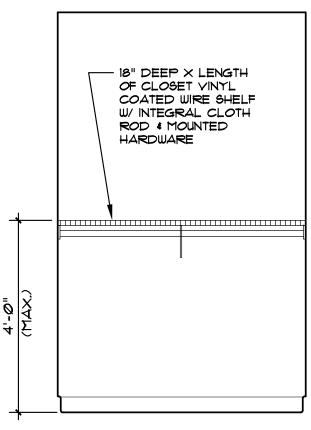


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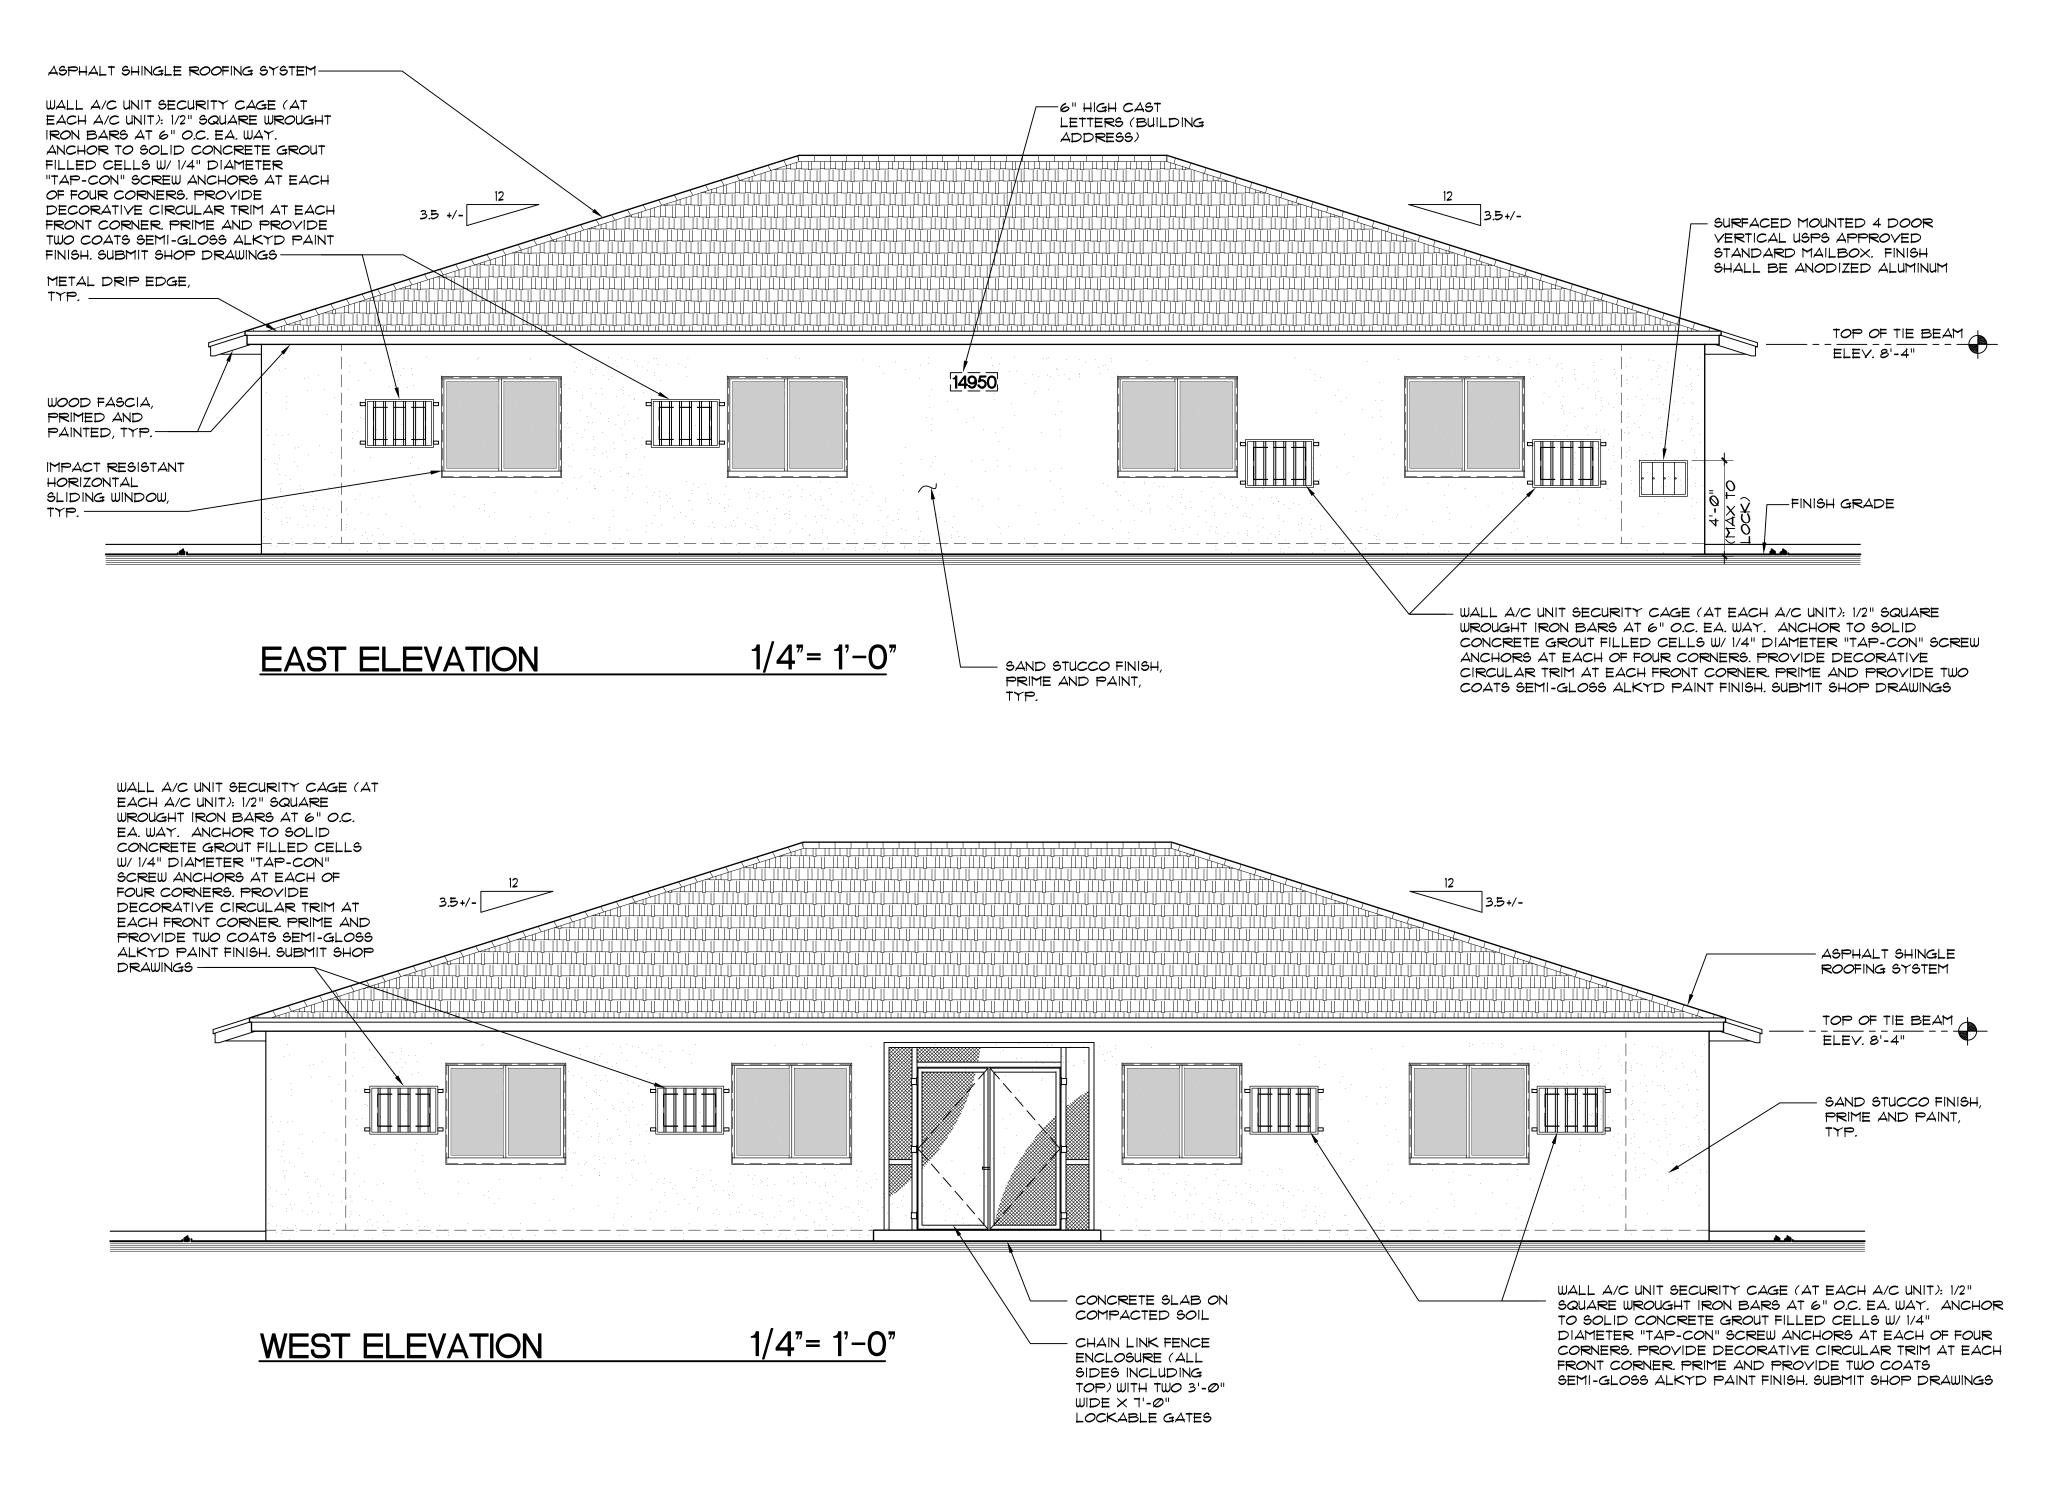
A L L E G U E ARCHITECTURE, IN A R C H I T E C T U F PLANNING INTERIOR DES CONSTRUCTION MANAGEME 901 PONCE DE LEON BLVD., SUITE CORAL GABLES, FLORIDA 33 tel: 305.461.4001 fax: 305.461. www.alleguezarchitecture.c	C. RE IGN ENT 202 3134 6002
CONSULTANTS: MECHANICAL, ELECTRICAL, PLUMBING ENGINEER: GARTEK ENGINEERING CORP. 7210 SOUTHWEST 39TH TERRACE MIAMI, FLORIDA 33155 TEL: (305) 266-8997 FAX: (305) 264-9496 STRUCTURAL ENGINEER: BLISS & NYITRAY, INC. 800 DOUGLAS ROAD, SUITE 300 CORAL GABLES, FLORIDA 33134 TEL: (305) 442-7086 FAX: (305) 442-7092	
PROJECT:	
RENOVATIONS 14950 NE 11TH AVEN MIAMI, FL	1UE
INTERIOR ELEVATIONS	
SEAL AR0014190 ANA ALLEGUEZ, RA LICENSE NO. AR14190 DATE: SEPTEMBER 15, 2014	
REVISED:	
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SOUTH ELEVATION



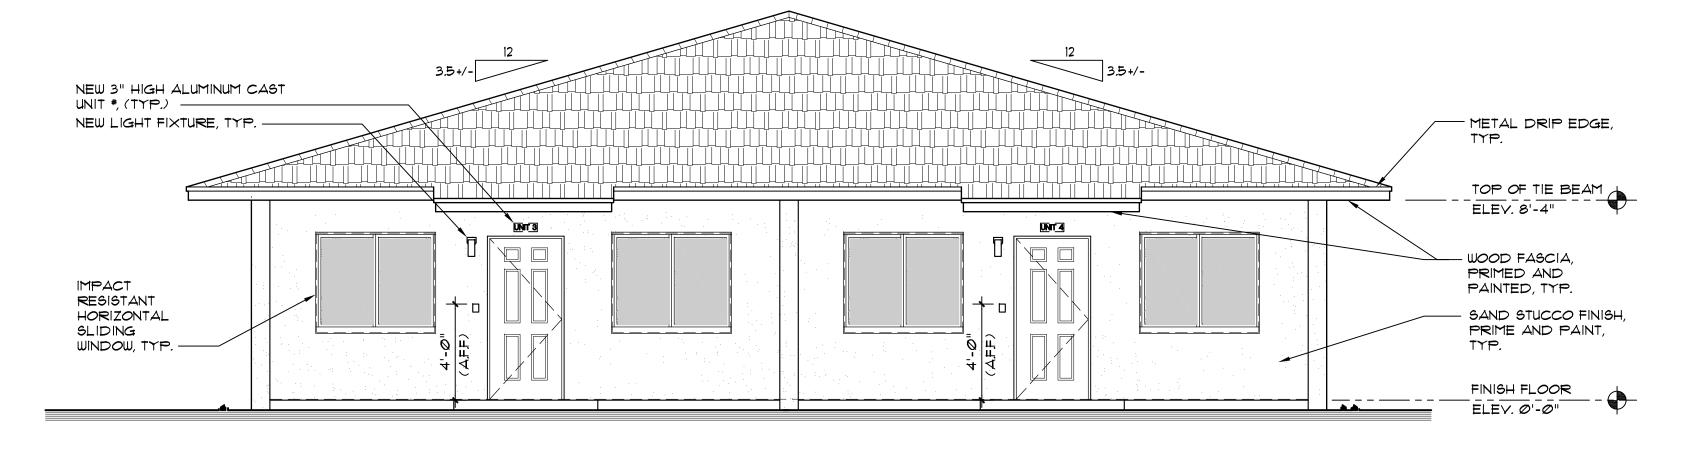


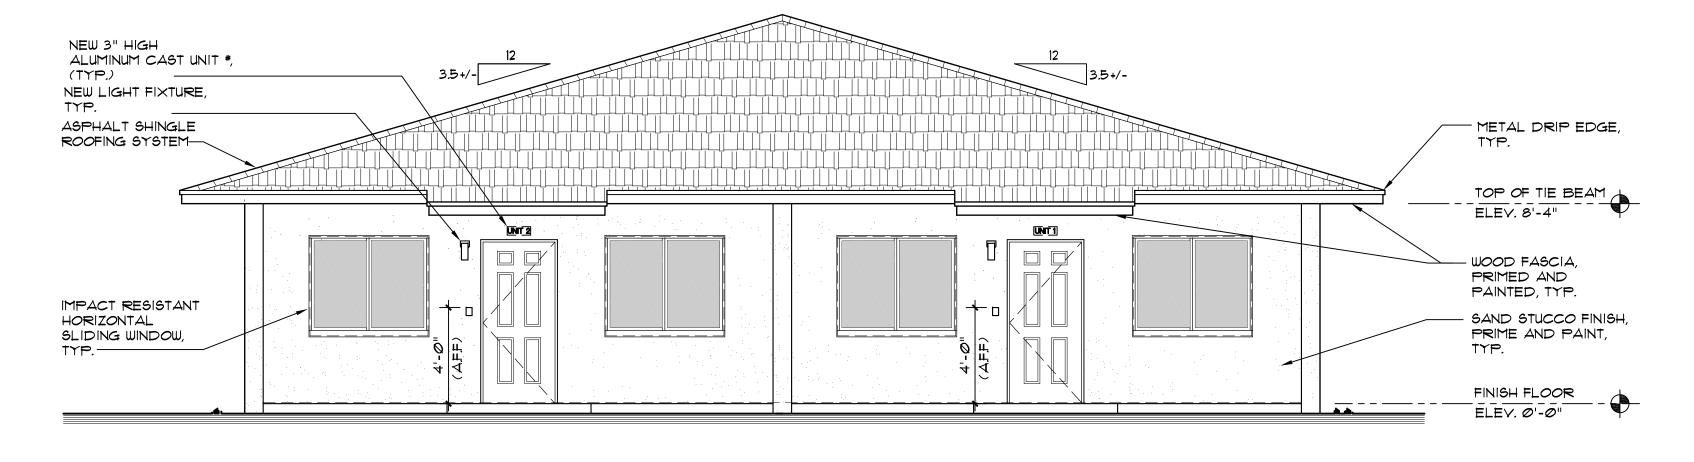


<u>1/4"= 1'-0"</u>

1/4"= 1'-0"

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CITY OF MIAMI LIFE QUEST RENOVATIONS 4950 NE 11TH AVEN MIAMI, FL TRAVING TITLE REXTERIOR BUILDING BUILDING BUILDING BUILDING BUILDING BUILDING BUILDING LEVATIONS		
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	CAD DRAWING NAME: SHEET NO.	

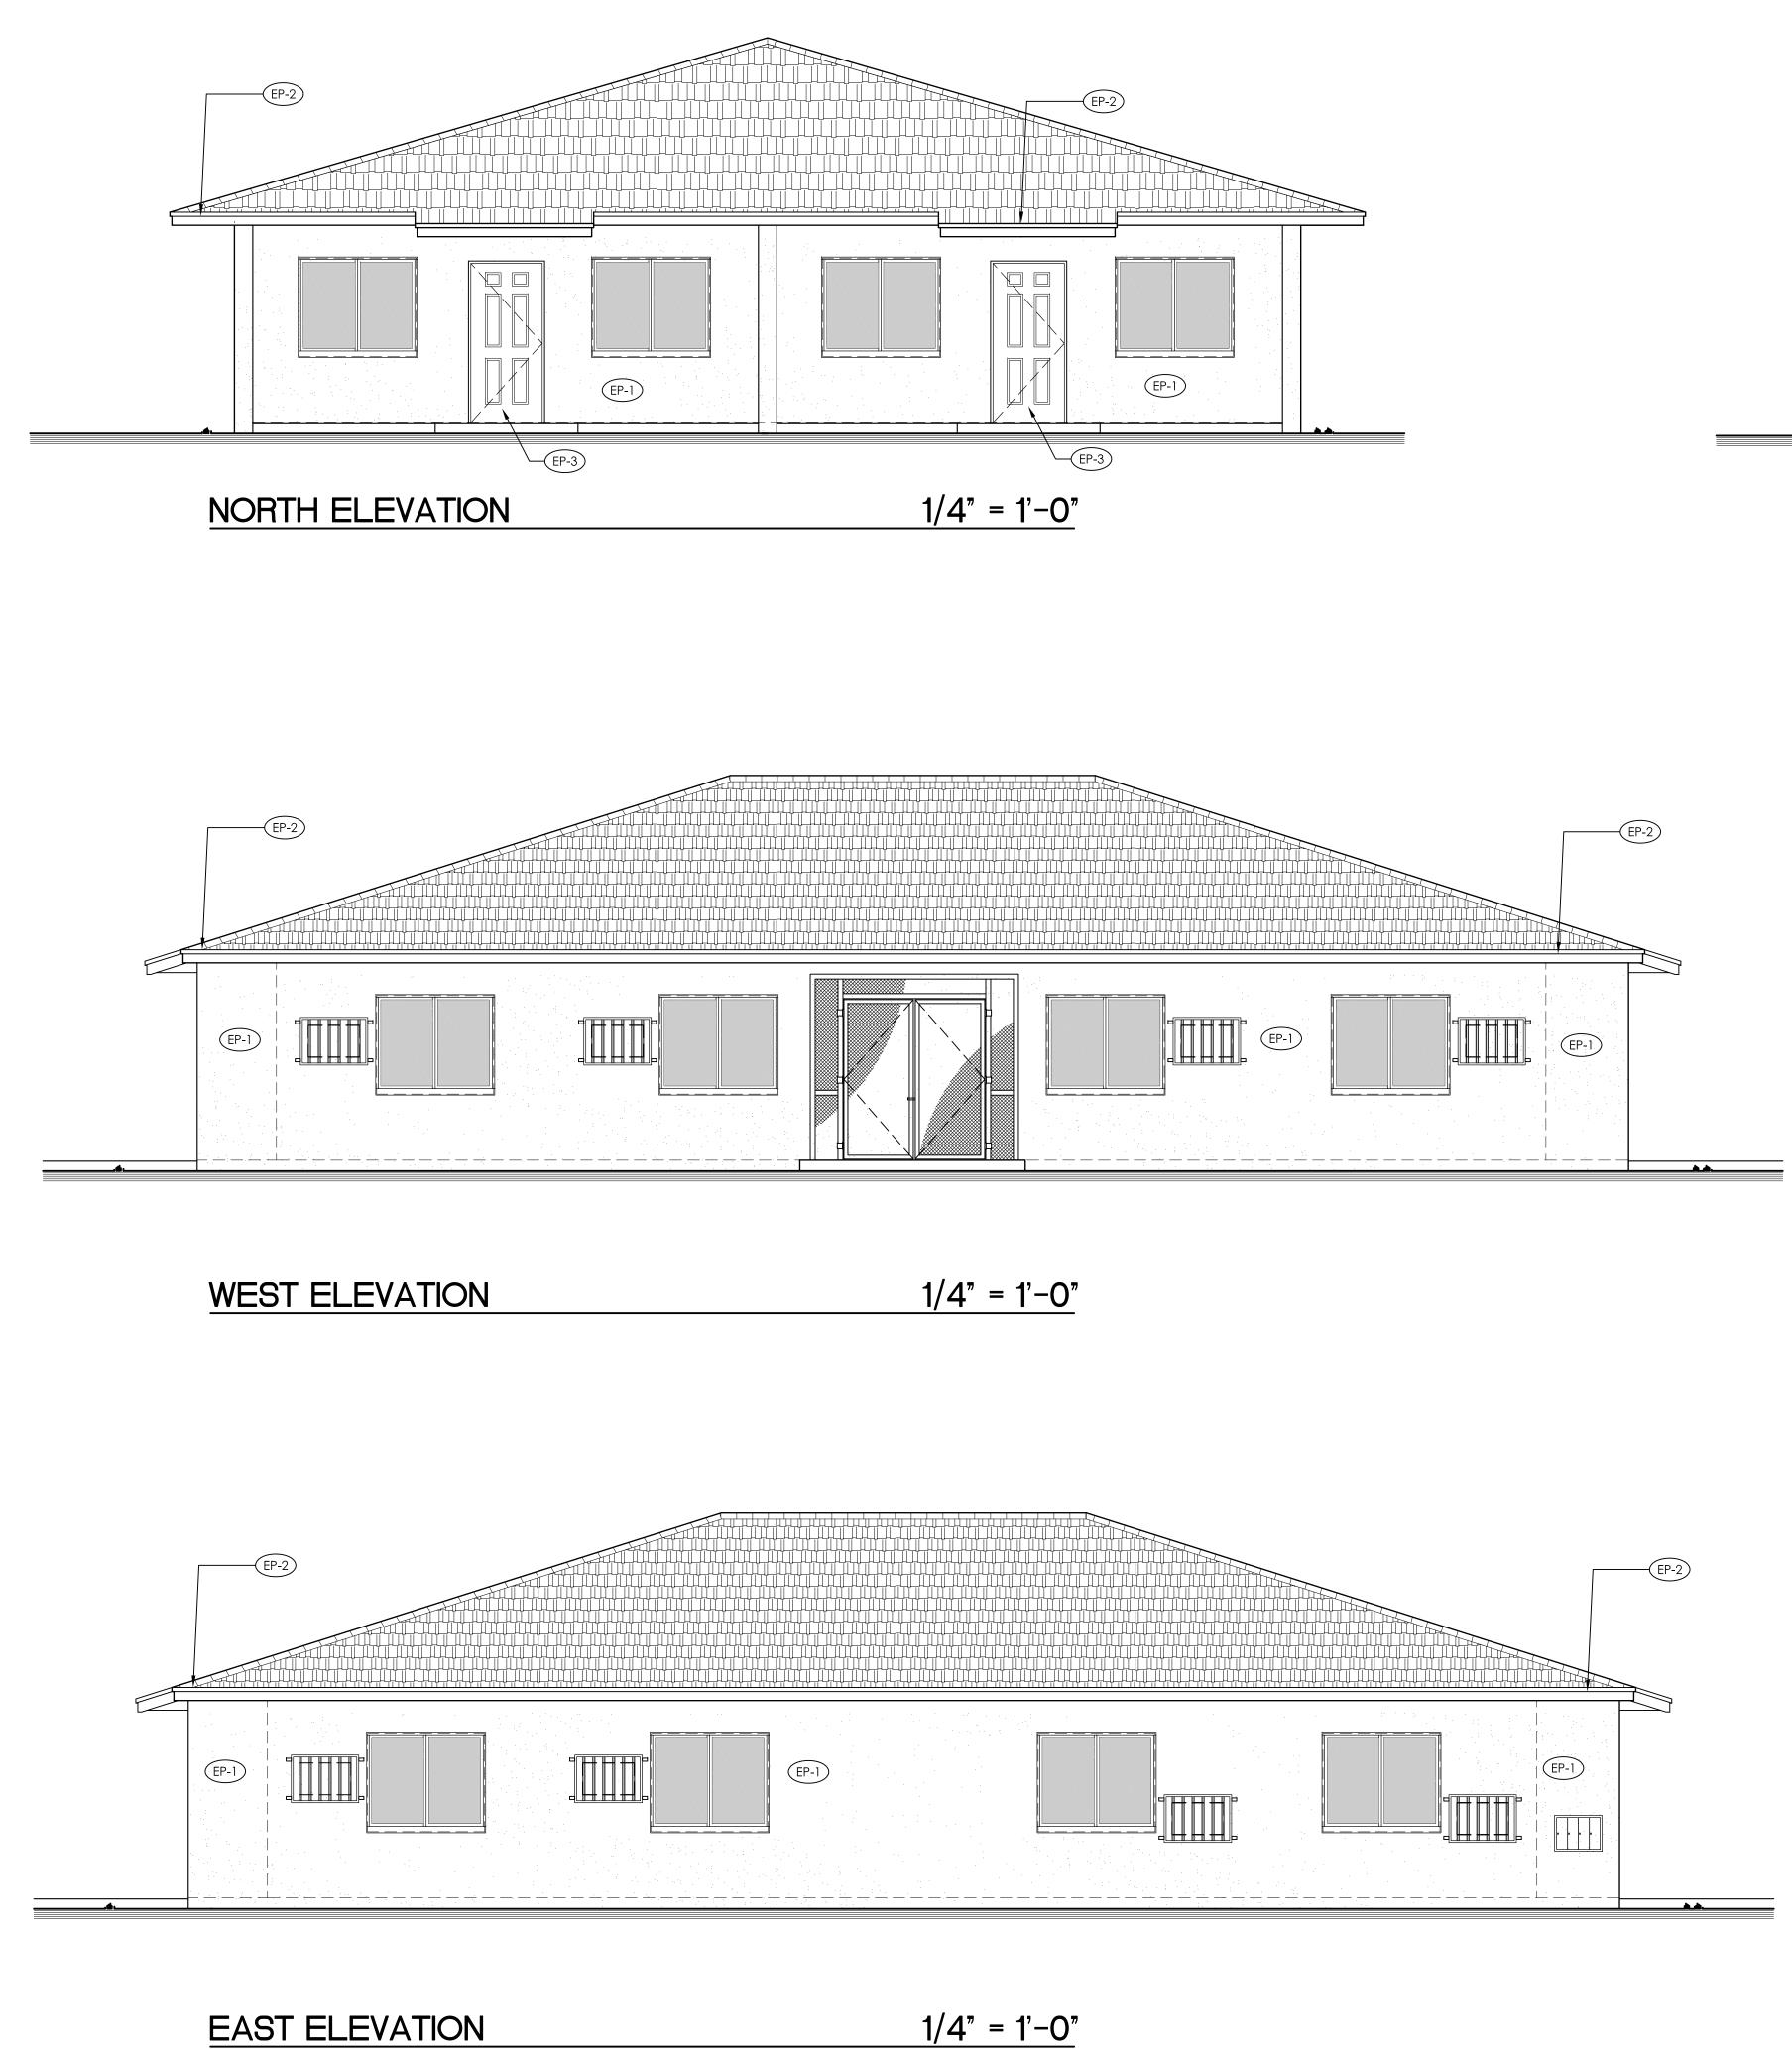


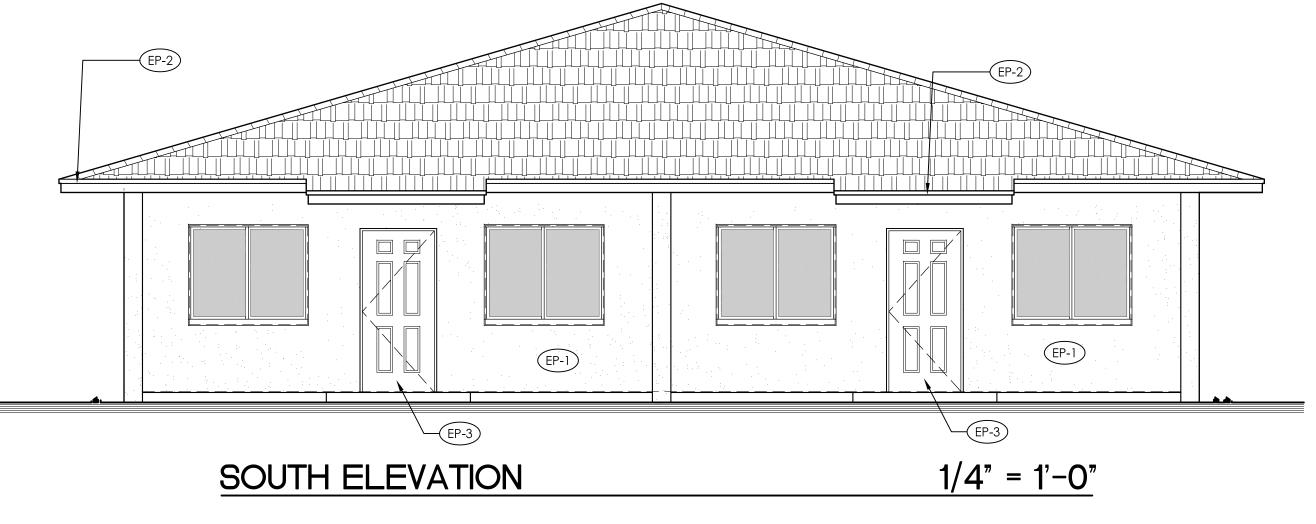

1/4" = 1'-0"

SYN	SYMBOL LEGEND		
(EP-I)	DENOTES PAINT COLOR		
EXT	ERIOR FINISHE	ES	
SCH	IEDULE		
MARK	COLOR	REMARKS	
(EP-1)	SEA SALT SW 6204	FIELD COLOR	
EP-2	EXTRA WHITE Sw 7006	FASCIA AND SOFFIT	
EP-3	EXTRA WHITE SW 7006	DOORS	
 NOTES : 1. PROVIDE MOCKUP PAINT SAMPLES 4' X 4' SQUARE FOR EACH COLOR OF PAINT TO BE APPROVED BY OWNER. 2. DO NOT PAINT OVER CODE-REQUIRED LABELS SUCH AS UNDERWRITERS LABORATORIES (UL) AND FACTORY MUTUAL (FM), NAME EQUIPMENT IDENTIFICATION, PERFORMANCE RATING, OR NOMENCLATURE PLATES. 3. PAINT WARRANTY: SIX (6) YEARS WARRANTY FOR LABOR AND MATERIAL FROM THE PAINT MANUFACTURER. 4. SHOP DRAWING SUBMITTAL: a. SUBMIT MANUFACTURER PRODUCT SAFETY DATA, MANUFACTURER'S TECHNICAL INFORMATION, INCLUDING PAINT LABEL ANALYSIS AND APPLICATION INSTRUCTIONS FOR EACH MATERIAL PROPOSED FOR USE; 			
 b. SAMPLES: PROVIDE COLOR CHIPS FOR REVIEW BY ARCHITECT. c. SUBMIT PAINT MANUFACTURER'S PROPOSED 6 YEAR WARRANTY DOCUMENT. 5. PHASE PROJECT TO ALLOW A MINIMUM OF 28 DAYS FOR STUCCO AND PLASTER TO CURE PROPERLY. IF PAINTING BEGINS BEFORE THE 28 DAY CURING PERIOD, THEN A MOISTURE AND PH TEST SHALL BE MADE ACCORDING TO ASTM D4262 AND ASTM D4269. 6. DO NOT PAINT OVER FACTORY -FINISHED OR INSTALLER-FINISHED SPECIFIED ITEMS, CONCEALED SURFACES, FINISHED METAL MATERIAL (SUCH AS ANODIZED ALUMINUM, STAINLESS STEEL, BARE COPPER, BARE BRONZE AND METALS OF SIMILAR FINISH), OPERATING PARTS AND CODE REQUIRED LABELS. 			
7. BASIS OF DESIGN IS SHERWIN WILLIAMS OR APPROVED EQUIVALENT.			

ARCHIT A R C H I PLANNING CONSTRUCT 901 PONCE DE CORAL GABI tel: 305.461.4001 WWW.allegue	E G U E Z ECTURE, INC. I T E C T U R E INTERIOR DESIGN INTERIOR DESIGN ION MANAGEMENT LEON BLVD., SUITE 202 LES, FLORIDA 33134 fax: 305.461.6002 carchitecture.com
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MIAMI, FLORIDA 33155 TEL: (305) 266-8997 FAX: (3 STRUCTURAL ENGINEER	
BLISS & NYITRAY, IN 800 DOUGLAS ROAD, SUITE CORAL GABLES, FLORIDA 3	5 300 33134
TEL: (305) 442-7086 FAX: (3	05) 442-7092
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			COR/ tel: 305. www.	AL GABL 461.4001 allegue:	ES, FLORIDA fax: 305 zarchitectur	331 5.461.60 e.cc
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	402	в	3'-Ø"	6'-8"	1-3/4"	WOOD	WOOD PRE-HUNG	PAINT	PAINT	2		_	_
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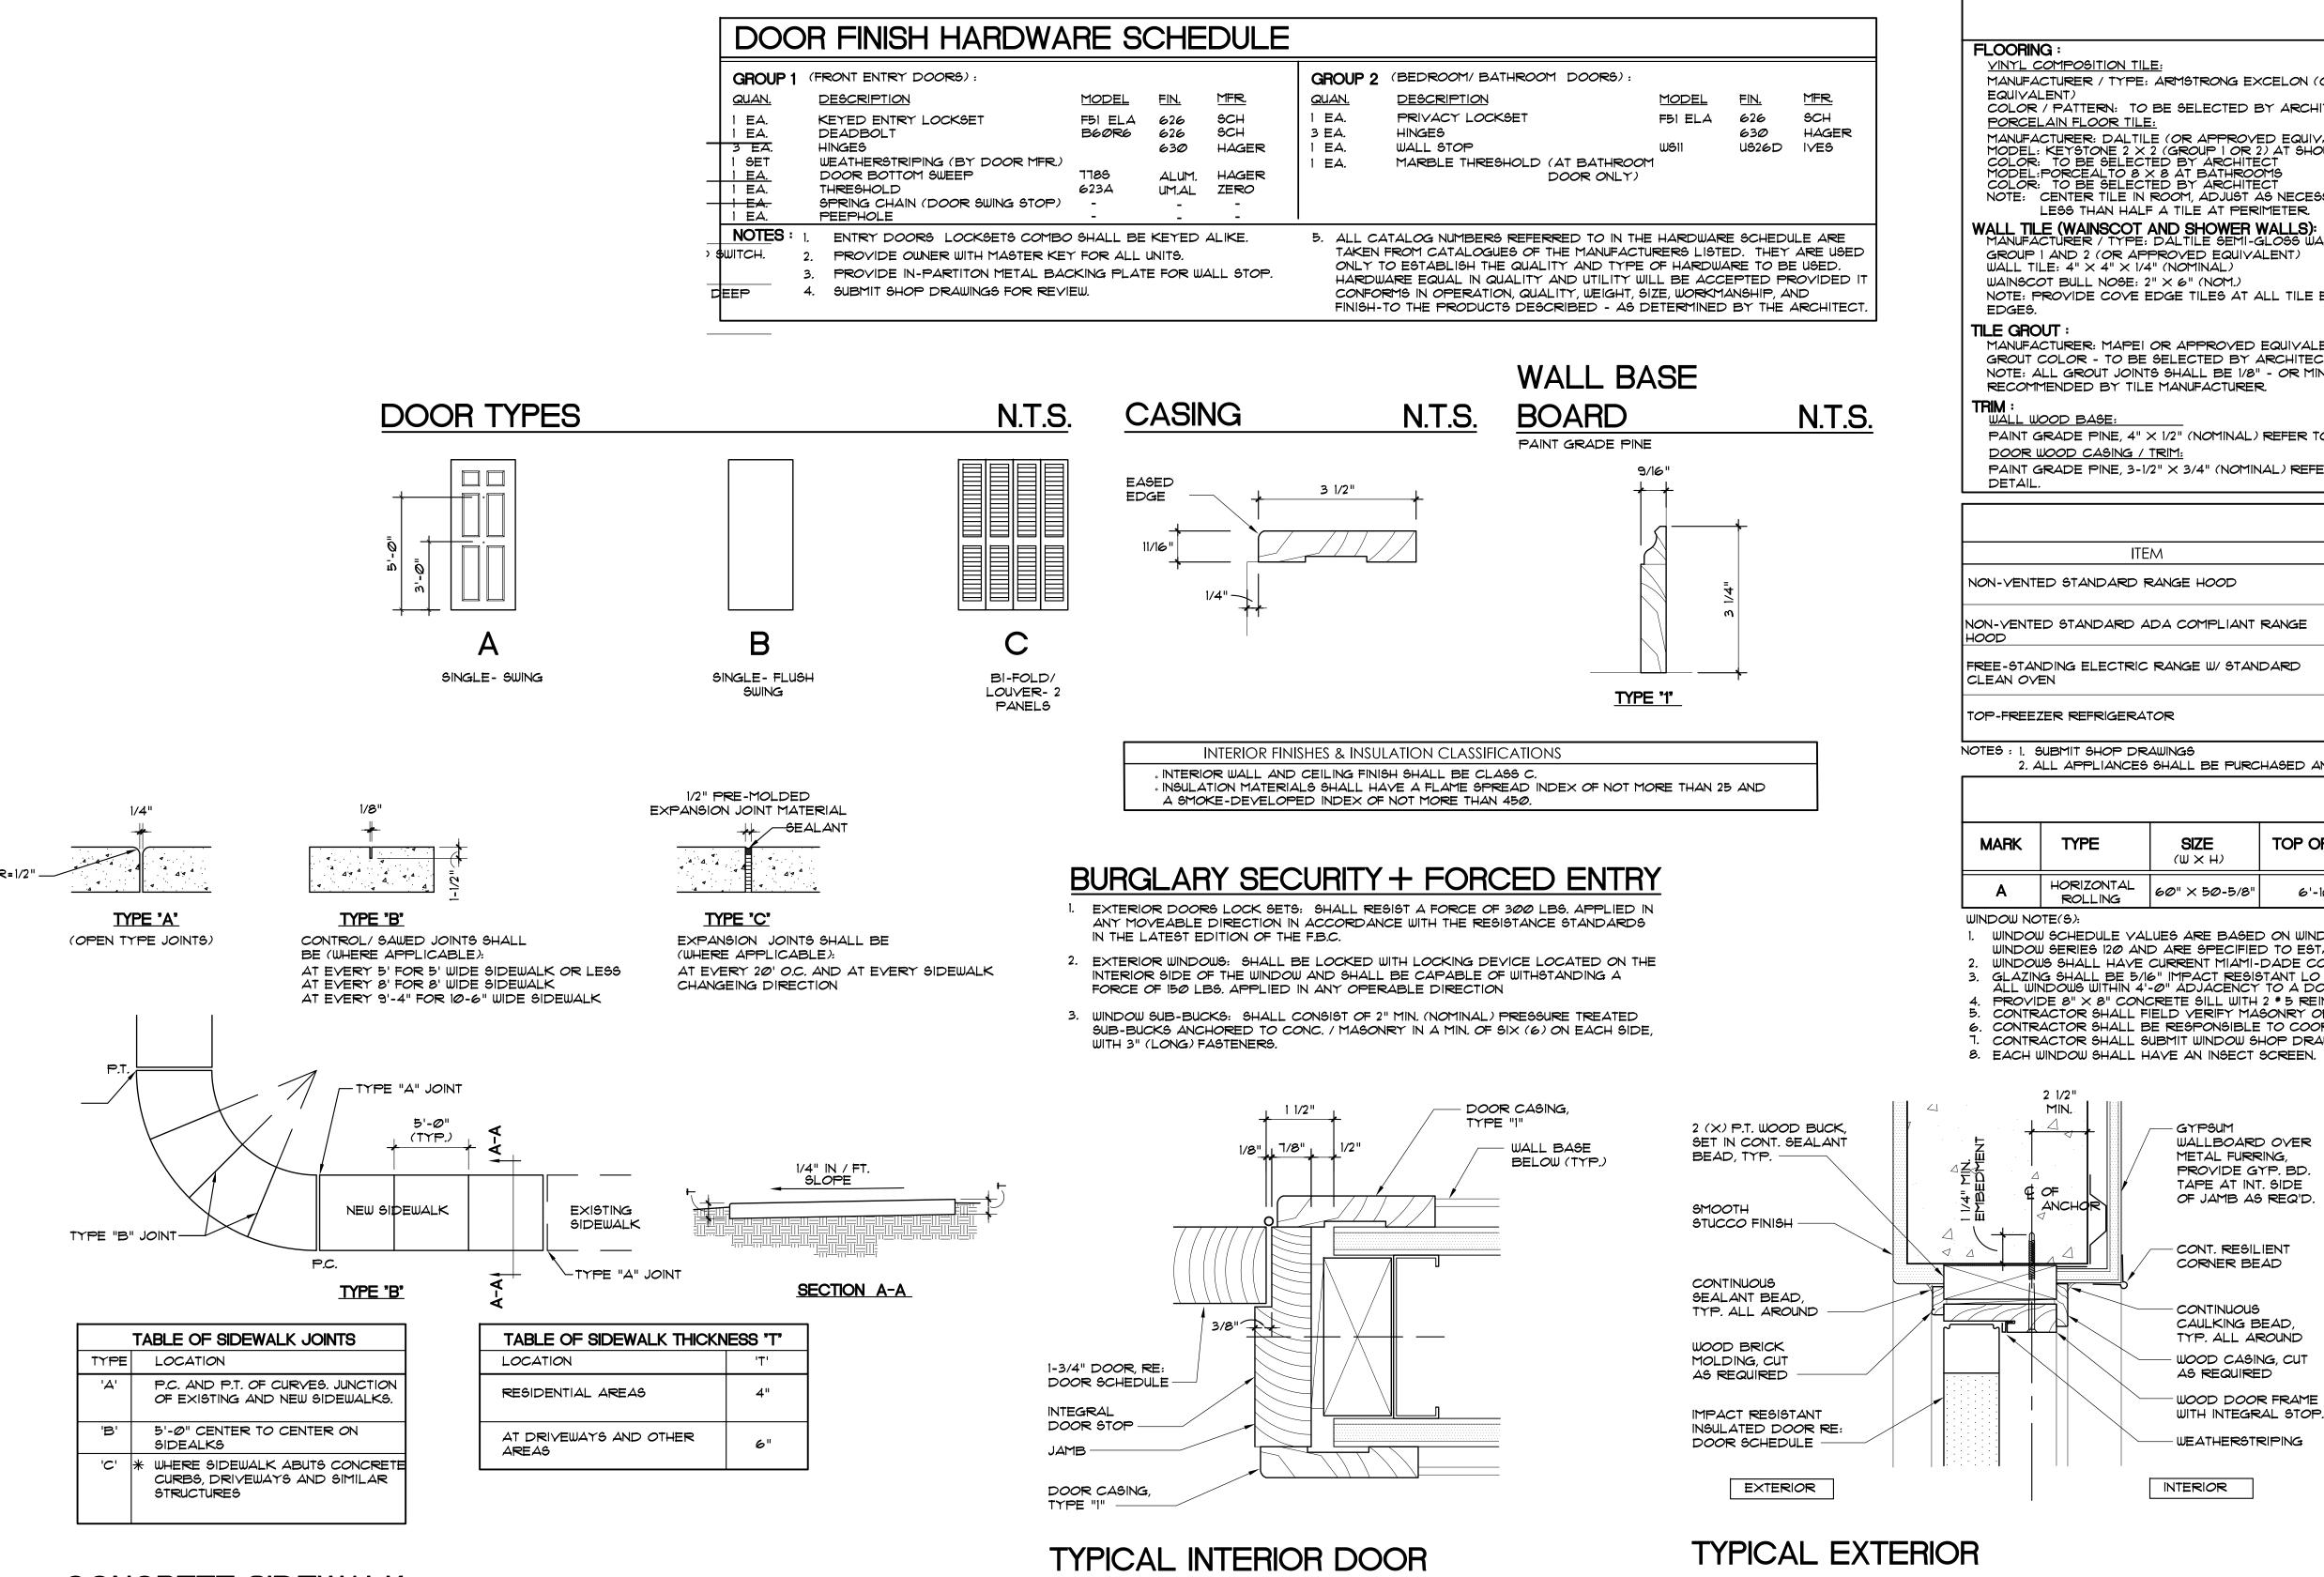
1. ALL DOORS SHALL BE INSTALLED WITH BACK OF DOOR FRAME, HINGE SIDE, AT 4" FROM NEAREST/ADJACENT PARTITION UNLESS OTHERWISE NOTED. 2. PROVIDE 1/2" MAX. HEIGHT ALUMINUM THRESHOLD WITH 1:2 (MAX.) CHAMFERED EDGES AT EXTERIOR DOORS. 3. PROVIDE PRE-FAB 1/2" MAX. HT. MARBLE THRESHOLD WITH CHAMFERED EDGES AT BATHROOM DOORS. 4. INTERIOR DOORS SHALL BE SMOOTH FLUSH HARDWOOD COMPOSITE SOLID CORE PRE-HUNG (TYPE). FRAME SHALL BE WOOD, PAINT GRADE,

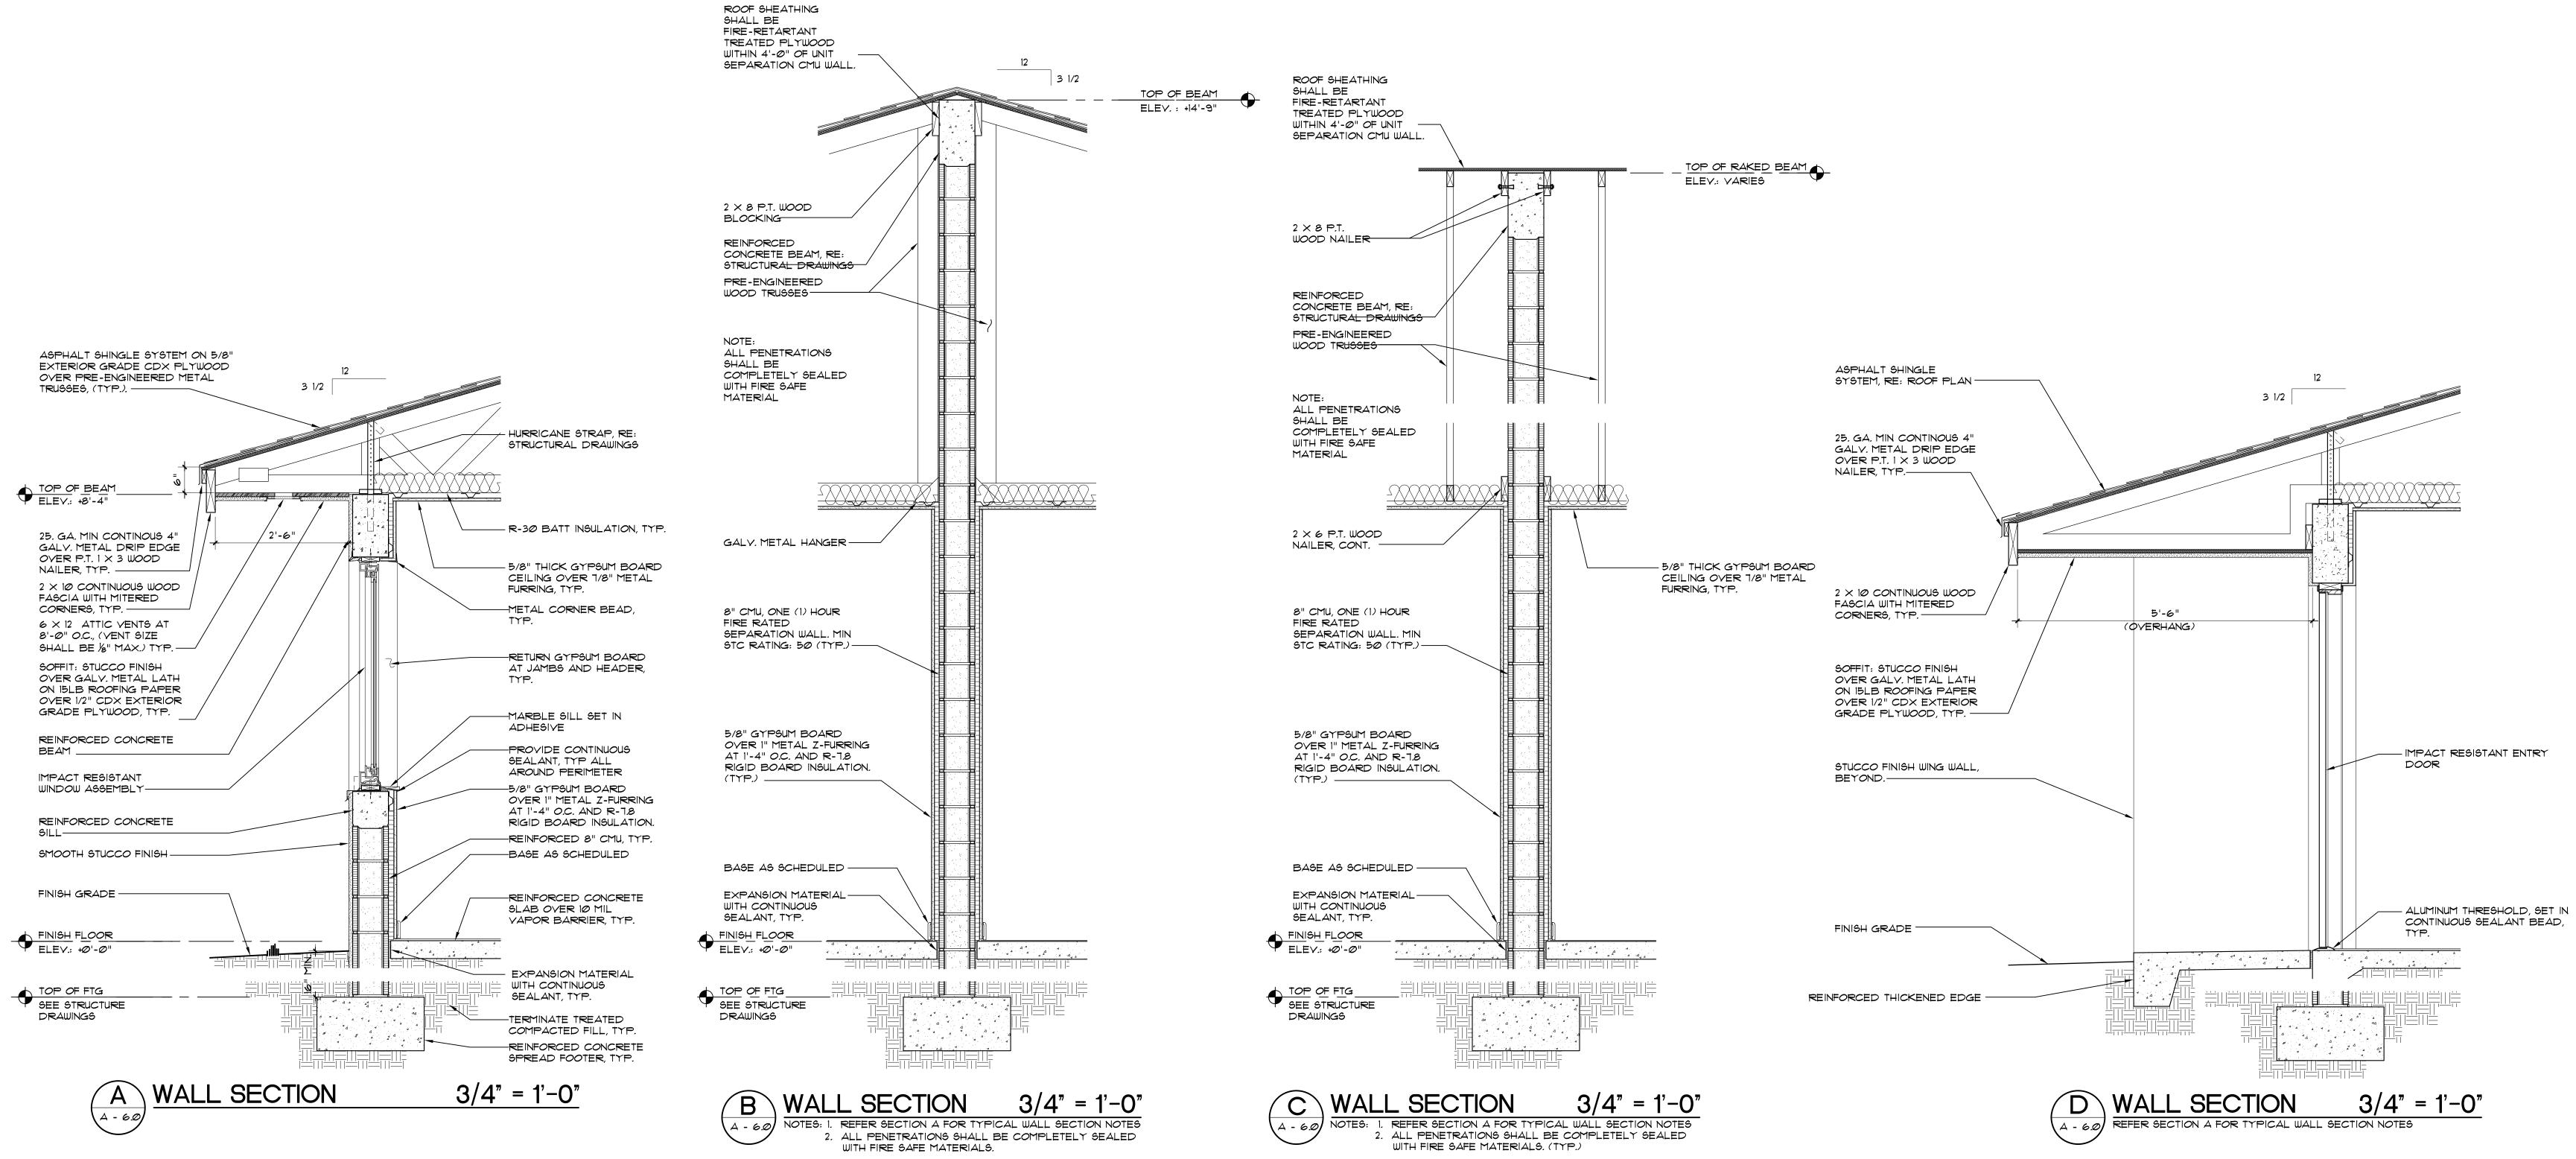CONSISTING OF 1 (X) MAIN FRAME; 3" "CLAMSHELL" TYPE CASING ALL AROUND, BOTH SIDES AND INTEGRAL STOP. PROVIDE SHIM AS REQUIRED AND CONTINUOUS SEALANT BEAD BETWEEN ALL DISSIMILAR MATERIALS (BACK OF CASING TO GYPSUM BOARD). PROVIDE 2 (X) SUB-FRAME AT JAMBS & HEAD; PROVIDE (3) STUD ANCHORS PER JAMB. 5. WOOD BI-FOLD DOORS SHALL BE PROVIDED WITH METAL TRACK AT HEAD.

6. ALL WOOD DOORS AND FRAMES SHALL RECEIVE ONE PRIMER COAT AND TWO COATS SATIN LATEX PAINT. 7. ALL EXTERIOR DOORS SHALL BE INSULATED (TYPE). 8. PROVIDE "PEEP" HOLE ON EXTERIOR/ENTRY DOOR. PROVIDE A SECOND (TWO) PEEP HOLE AT UNIT WITH MOBILITY FEATURES (HC ACCESSIBLE) AT 3'-0"

A.F.F. COMPLYING WITH FBCA-10.

<u>QUAN.</u> EA. 1 EA. DEADBOLT 3 EA. HINGES I SET <u>| EA.</u> | EA. THRESHOLD PEEPHOLE 1 EA. NOTES : \$WITCH. 2



CONCRETE SIDEWALK

NTS

HEAD + JAMB DETAIL

6"

DOOR HEAD DETAIL

JAMB SIMILAR

	ROOM NAME		FLC		ASE				WAL	LS					CF	EILINC	35	REMARKS
					AGE	NO	RTH	SOL	ЛН	EA	ST	WE	ST					ΠΕΜΑΠΚΟ
		V.C.T.	CERAMIC TILE	PAINTED WOOD BASE BOARD	COVE CERAMIC TILE BASE	FAINT ON GYPSUM BOARD	4 X 4 CERAMIC WALL TILE	PAINT ON GYPSUM BOARD	4×4 CERAMIC WALL TILE	PAINT ON GYPSUM BOARD	4×4 CERAMIC WALL TILE	PAINT ON GYPSUM BOARD	4×4 CERAMIC WALL TILE	PAINT ON GYPSUM BOARD				NOTE : * MOISTURE RESISTANT GYPSUM BOARD • REFER: INTERIOR ELEVATIONS
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	BATHROOM	\top	\square		\frown	\mathbf{k}		$\overline{\ast}$	\square	$\widetilde{\ast}$		\mathbf{k}						

1. ALL NEW GYPSUM BOARD SURFACES SHALL BE PROVIDED WITH TAPED AND COMPOUND LEVEL 4 (SMOOTH). 2. REFER TO INTERIOR ELEVATIONS FOR TILE INSTALLATION HEIGHTS.

3. PROVIDE FIRE STOP	AT ALL CAVITY	WALLS/ PARTITION A 8'-0" MAX.	

WALTER: WALL FINSH (PAINT): WALL FINSH (PAINT		FINISH	H MATE	RIALS			
 To be selected by Architect Centrer TILE IN ROOM, ADJUST AS NECESSARY TO AVOID LESS THAN HALF A TILE AT PERIMETER. LE (WAINSCOT AND SHOWER WALLS): COTWEER / TYPE: DATILLE SEMI-GLOSS WALL TILE I AND 2 (OR APPROVED EQUIVALENT) ILE: 4" X 4" X 1/4" (NOMINAL) REFER TO DETAIL COTOR - TO BE SELECTED BY ARCHITECT COLOR - TO BE SELECTED BY ARCHITECT MANFACTURER: WILSONART OR APPROVED EQUIVALENT COLOR - TRIM: GRADE PINE, 4" X 1/2" (NOMINAL) REFER TO DETAIL WODD TRIM - BASE BOARDS, DOOR FRAMES AND INCOMINAL AND AND ACTIRER TO DETAIL WODD CASING / TRIM: GRADE PINE, 3-1/2" X 3/4" (NOMINAL) REFER TO DETAIL WODD CASING / TRIM: GRADE PINE, 3-1/2" X 3/4" (NOMINAL) REFER TO DETAIL WANFACTURER: WILSONART OR APPROVAL BY ARCHITECT SUBMIT SAMPLES FOR APPROVAL BY ARCHITEC	COMPOSITION TILE: ACTURER / TYPE: ARMSTRONG EXCELON (OF LENT) ? / PATTERN: TO BE SELECTED BY ARCHITE LAIN FLOOR TILE: ACTURER: DALTILE (OR APPROVED EQUIVAL CTURER: DALTILE (OR APPROVED EQUIVAL KEYSTONE 2 X 2 (GROUP I OR 2) AT SHOW ?: TO BE SELECTED BY ARCHITECT	R APPROVED ECT LENT)	MANUFACTI INTERIOR (ALL GYF VOC INTE SEMI-GLO CONTRAC COLOR:	URER: SHERWIN GYPSUM BOARD SUM BOARD SU ERIOR LATEX PR OSS PROMAR 20 CTOR SHALL PR ONE COLOR -	D SURFACES - WALLS AND CEILINGS): RFACES SHALL RECEIVE ONE COAT OF PROMAR 200 ZERO RIMER WHITE AND TWO (2) COATS OF LATEX BASED 20 ZERO VOC. 20 VIDE 4' X 4' PAINT SAMPLES OF EACH COLOR FOR APPROVAL. TO BE SELECTED		
ACTURER: MAPEI OR APPROVED EQUIVALENT COLOR - TO BE SELECTED BY ARCHITECT ALL GROUT JOINTS SHALL BE 1/8" - OR MINIMUM MENDED BY TILE MANUFACTURER. JOOD BASE: GRADE PINE, 4" × 1/2" (NOMINAL) REFER TO DETAIL WOOD CASING / TRIM: GRADE PINE, 3-1/2" × 3/4" (NOMINAL) REFER TO 	2: TO BE SELECTED BY ARCHITECT CENTER TILE IN ROOM, ADJUST AS NECESS, LESS THAN HALF A TILE AT PERIMETER. LE (WAINSCOT AND SHOWER WALLS): ACTURER / TYPE: DALTILE SEMI-GLOSS WALL I AND 2 (OR APPROVED EQUIVALENT) ILE: 4" X 4" X 1/4" (NOMINAL) OT BULL NOSE: 2" X 6" (NOM.) PROVIDE COVE EDGE TILES AT ALL TILE EX	LTILE	ALL WOO LATEX P INDUSTRI CONTRAC COLOR: EXTERIOR ALL EXT INDUSTRI INDUSTRI	D TRIM SURFAC RIMER/ SEALER AL DTM ACRYLI CTOR SHALL PR WHITE METAL DOORS: ERIOR METAL D AL PRO-CRYL I AL DTM ACRYLI	ES SHALL RECEIVE ONE COAT OF PREPRITE PROBLOCK WHITE AND TWO (2) COATS OF GLOSS FINISH PAINT PRO IC GLOSS EXTRA WHITE COVIDE PAINT SAMPLE (ON MATERIAL) FOR APPROVAL.		
MANUFACTURER: WILSONART OR APPROVED EQUIVALENT GRADE PINE, 4" X 1/2" (NOMINAL) REFER TO DETAIL MANUFACTURER: WILSONART OR APPROVED EQUIVALENT WOOD CASING / TRIM: COLOR: TO BE SELECTED BY ARCHITECT WOOD CASING / TRIM: SUBMIT SAMPLES FOR APPROVAL BY ARCHITECT GRADE PINE, 3-1/2" X 3/4" (NOMINAL) REFER TO SUBMIT SAMPLES FOR APPROVAL BY ARCHITECT	CTURER: MAPEI OR APPROVED EQUIVALEN COLOR - TO BE SELECTED BY ARCHITECT ALL GROUT JOINTS SHALL BE 1/8" - OR MINIT		CEMENT STUCCO / PLASTER SURFACES SHALL RECEIVE ONE COAT HOT STUCCO				
ΚΙΤΟΗΕΝΙ ΔΡΡΙΙΔΝΙΟΕ ΥΟΗΕΝΙΙΕ	GRADE PINE, 4" × 1/2" (NOMINAL) REFER TO WOOD CASING / TRIM:		MANUFACTI COLOR: TO	URER: WILGONAR O BE GELECTED	RT OR APPROVED EQUIVALENT BY ARCHITECT		
		KITCHE	N APPL	IANCE	SCHEDULE		
ITEM MANUFACTURER MODEL	ITEM	MANUFAC	CTURER	MODEL			

ITEM	MANUFACTURER	MODEL	
NTED STANDARD RANGE HOOD	GENERAL ELECTRIC	JN327HWW	COLOR: WHITE LOCATION: UNITS 1, 3 AND 4
ITED STANDARD ADA COMPLIANT RANGE	AIR KING:	ES-ADA SERIES	ADA COMPLIANT WITH INTEGRAL REMOTE OPERATION WALL MOUNT LOCATION: UNIT 2
ANDING ELECTRIC RANGE W/ STANDARD DVEN	GENERAL ELECTRIC	JB450DFWW	COLOR: WHITE ON WHITE SIZE: 36-1/4" HIGH X 31-1/4" WIDE X 27-1 (ADA COMPLIANT) LOCATION: ALL UNITS
EZER REFRIGERATOR	GENERAL ELECTRIC	GTHI8IBDWW	COLOR: WHITE SIZE: 66-5/8" HIGH \times 29-1/2" WIDE \times 32-1/8" DEEF COMPLIANT) 18.0 CU. FT. LOCATION: ALL UNITS

2. ALL APPLIANCES SHALL BE PURCHASED AND INSTALLED BY THE GENERAL CONTRACTOR.

TYPE	SIZE	TOP OF M.O.	MAT	ERIAL	N	IATERIAL	MIAMI-DADE CO.	REMARKS			
	(U × H)		FRAME	GLAZING	FRAME	GLAZING	N.O.A. #				
HORIZONTAL ROLLING	60" × 50-5/8"	6'-10"	ALUMINUM	LAMINATED GLASS	ESP - WHITE		15-0929.13				

1. WINDOW SCHEDULE VALUES ARE BASED ON WINDOW MODELS MANUFACTURED BY CGI WINDOWS AND DOORS, SENTINEL HORIZONTAL ROLLING WINDOW SERIES 120 AND ARE SPECIFIED TO ESTABLISH PROJECT WINDOW STANDARDS.

2. WINDOWS SHALL HAVE CURRENT MIAMI-DADE COUNTY PRODUCT APPROVAL NOTICE OF ACCEPTANCE (N.O.A.). 3. GLAZING SHALL BE 5/16" IMPACT RESISTANT LO E 366 WITH GRAY TINT, SUBMIT GLAZING SAMPLE FOR APPROVAL. ALL WINDOWS WITHIN 4'-0" ADJACENCY TO A DOOR SHALL BE OF CATEGORY II SAFETY GLAZING.

PROVIDE 8" × 8" CONCRETE SILL WITH 2 * 5 REINFORCING CONTRACTOR SHALL FIELD VERIFY MASONRY OPENINGS PRIOR TO FABRICATION OF WINDOWS.

CONTRACTOR SHALL BE RESPONSIBLE TO COORDINATE DOORS / WINDOWS OVERALL DIMENSIONS WITH ROUGH MASONRY OPENINGS. CONTRACTOR SHALL SUBMIT WINDOW SHOP DRAWINGS PRIOR TO ORDERING WINDOWS FOR ARCHITECT'S REVIEW FOR APPROVAL.

INT	3"=1'-0"	TYPICAL WINDOW HEAD DETAIL	INTERIOR 3"=1'-0"
	USOD CASING, CUT AS REQUIRED NOOD DOOR FRAME NITH INTEGRAL STOP. NEATHERSTRIPING	SHIM AS REQ'D. ALUM. FRAME, IMPACT RESISTANT WINDOW RE: WINDOW SCHEDULE	PERIMETER CAULKING, TYP.
	CORNER BEAD CONTINUOUS CAULKING BEAD, IYP. ALL AROUND 1000 CASING, CUT	CONTINUOUS SEALANT BEAD, TYP. ALL AROUND BACKBED SEALANT, TYP AT FLANGE	CONT. REGILIENT CORNER BEAD
	GYPSUM VALLBOARD OVER METAL FURRING, PROVIDE GYP. BD. TAPE AT INT. SIDE OF JAMB AS REQ'D. CONT. RESILIENT	SMOOTH STUCCO FINISH I (X) P.T. WOOD BUCK, SET IN BED OF SEALANT, TYP.	GYPSUM WALLBOARD OVER METAL FURRING, PROVIDE GYP. BD. TAPE AT INT. SIDE OF JAMB AS REQ'D.

A L L E G U E Z ARCHITECTURE, INC. A R C H I T E C T U R E PLANNING INTERIOR DESIGN CONSTRUCTION MANAGEMENT 901 PONCE DE LEON BLVD., SUITE 202 CORAL GABLES, FLORIDA 33134
tel: 305.461.4001 fax: 305.461.6002 www.alleguezarchitecture.com AACOO2746 CONSULTANTS:
MECHANICAL, ELECTRICAL, PLUMBING ENGINEER: GARTEK ENGINEERING CORP. 7210 SOUTHWEST 39TH TERRACE MIAMI, FLORIDA 33155 TEL: (305) 266-8997 FAX: (305) 264-9496
STRUCTURAL ENGINEER: BLISS & NYITRAY, INC. 800 DOUGLAS ROAD, SUITE 300 CORAL GABLES, FLORIDA 33134 TEL: (305) 442-7086 FAX: (305) 442-7092
PROJECT:
CITY OF MIAMI LIFE QUEST RENOVATIONS 4950 NE 11TH AVENU
MIAMI, FL
DRAWING TITLE:
SCHEDULES
AND DETAILS
SEAL
ALLEGUE OF
AR0014190
ANA ALLEGUEZ, RA LICENSE NO. AR14190
DATE: SEPTEMBER 15, 2014
REVISED:
CAD DRAWING NAME:
Sheet NO.
$\Delta - / \Omega$

PLUMBING GENERAL NOTES A. UNLESS OTHERWISE SPECIFIED ON THIS DRAWING CONTRACTOR SHALL

REFER TO ORIGINAL LANDLORD SPECIFICATIONS FOR ALL APPLICABLE REQUIREMENTS, NOTES, DETAILS, CONSTRUCTION'S STANDARDS, ETC., COORDINATE WITH LANDLORD REQUIREMENTS PRIOR TO ORDERING AND/OR INSTALLATION OF ANY EQUIPMENT AND ACCESSORIES SHOWN.

1. THE WORK THAT IS TO BE DONE UNDER THIS HEADING INCLUDES THE FURNISHING OF ALL LABOR, MATERIALS AND EQUIPMENT PERMITS, FEES, INSPECTIONS, TEST, INSURANCE, ETC., REQUIRED FOR THE COMPLETION OF THE PLUMBING SYSTEM SHOWN ON DRAWINGS OR LISTED BELOW.

. CONTRACTOR SHALL VERIFY THE EXACT LOCATION OF EXISTING PIPES BEFORE COMMENCING TO WORK AND MAKE MODIFICATIONS AS REQUIRED WITHOUT ADDITIONAL COST TO THE OWNER. 3. ALL PIPING SHALL BE INSTALLED RECESSED IN CHASES, FURRING

OR PARTITIONS. 4. EXISTING PIPES SERVING AREAS NOT COVERED BY THIS CONTRACT BUT IN SERVICE AT THIS TIME SHALL NOT BE INTERRUPTED EXCEPT AS A TEMPORARY INTERRUPTION COORDINATED WITH THE OWNER AND LANDLORD. 5. PLUMBING CONTRACTOR SHALL PAY ALL FEES, INSPECTION AND

6. PLUMBING CONTRACTOR SHALL VERIFY ALL SPACE CONDITIONS AND DIMENSIONS AT JOB SITE PRIOR TO FABRICATION AND INSTALLATION OF MATERIALS AND EQUIPMENT.

7. COORDINATE ALL WORK WITH OTHER TRADES.

CONNECTION CHARGES REQUIRED.

8. PLUMBING CONTRACTOR SHALL GUARANTEE ALL WORK FREE OF DEFECTS IN MATERIALS AND WORKMANSHIP FOR A PERIOD OF ONE YEAR FROM DATE OF ACCEPTANCE. 9. PROVIDE SHOCK ABSORBERS SIZE, QUANTITY AND LOCATION AS PER P.D.I. STANDARDS.

10. PROVIDE SHUT-OFF VALVE FOR EACH GROUP OF FIXTURE AND EACH FIXTURE SUPPLY. WATER DISTRIBUTION VALVES 2" AND SMALLER VALVES ARE TO BE TEFLON SEATED, BRONZE BODY, FULL PORT BALL VALVES. 11. WHEREVER DISSIMILAR METALS ARE TO BE JOINED, A DIELECTRIC FITTING SHALL BE PROVIDED TO CONNECT BOTH TYPES OF PIPES.

12. CONTRACTOR SHALL BE RESPONSIBLE TO COORDINATE ALL ROUGH-INS WITH THE MANUFACTURER BEFORE MAKING ANY INSTALLATION.

13. POTABLE HOT AND COLD WATER SYSTEMS SHALL BE "LEAD FREE" WITH LEAD CONTENT NOT EXCEEDING 0.2 PERCENT FOR SOLDER AND FLUXES AND 8 PERCENT FOR PIPE FITTINGS, FIXTURES AND TRIM. CONTRACTOR SHALL VERIFY MANUFACTURER'S COMPLIANCE. 14. ALL POTABLE HOT AND COLD WATER SYSTEMS SHALL BE FLUSHED CLEAR,

STERILIZED WITH AN APPROVED SOLUTION AND THROUGHLY FLUSHED OF ALL RESIDUAL SOLUTION AFTER FINAL PRESSURE TESTS AND WITH ALL TRIM AND CONNECTIONS INSTALLED.

15. PROVIDE SHUT-OFF AND VACUUM BREAKER TO ALL HOSE BIBBS AND FAUCETS WITH HOSE-END CONNECTIONS. ALL EXTERIOR HOSE BIBS ARE TAMPER PROOF 16. ALL FLOOR DRAINS SHALL HAVE TRAP PRIMERS TO PROTECT THE SEAL OF

THE TRAP. 17. PVC PIPING IS NOT ALLOWED IN RETURN AIR PLENUMS. IF RETURN AIR PLENUMS ARE USED, CONTRACTOR SHALL REPLACE ALL EXISTING PVC PIPING WITH CAST IRON OR COPPER PIPING.

18. DRAINAGE SYSTEM DESIGN IS BASED ON 1/8" PER FOOT MINIMUM FALL FOR PIPES 3" OR LARGER AND 1/4" PER FOOT MINIMUM FALL FOR PIPES 2" OR SMALLER, ANY DEVIATIONS SHALL BE APPROVED BY ARCHITECT/ENGINEER.

19. ALL VENT THROUGH ROOF OPENINGS SHALL BE OFFSETED TO A MINIMUM DISTANCE OF 3'-0" FROM PARAPET WALL OR ROOF EDGE. SEE ARCHITECTURAL DRAWINGS FOR ROOF FLASHING. LEAD FLASHING WILL NOT BE ACCEPTED. 20. COORDINATE SCHEDULING OF ALL REQUIRED INSPECTIONS WITH APPROPRIATE

REGULATORY BODIES. 21. ALL FIRE RATED WALL PENETRATIONS SHALL BE PROTECTED WITH A UL APPROVED FIRE STOPPING ASSEMBLY SYSTEM.

22. CONDENSATE DRYWELL SHALL BE LOCATED MINIMUM 1 FOOT AWAY FROM THE STRUCTURE SIDEWALL, CONTRACTOR TO COORDINATE EXACT LOCATION IN FIELD.

ALL PLUMBING FIXTURES SHALL COMPLY WITH TABLE 604.4 FBC - PLUMBING FOR "MAXIMUN FLOW RATES AND CONSUMPTION FOR PLUMBING FIXTURES AND FIXTURE FITTINGS"

PLUMBING DEMOLITION NOTES

1. SITE INVESTIGATION:

- EXAMINATION OF CONTRACT DOCUMENTS AND SITE OF WORK; THE CONTRACTOR AND SUBCONTRACTOR IS REQUIRED, BEFORE SUBMITTING HIS/HER PROPOSAL, TO VISIT THE SITE OF THE PROPOSED WORK AND FAMILIARIZE HIMSELF/HERSELF WITH THE NATURE AND EXTENT OF THE WORK AND ANY LOCAL CONDITIONS THAT MAY IN ANY MANNER AFFECT THE WORK TO BE DONE AND EQUIPMENT, MATERIALS AND LABOR REQUIRED THEREFOR, SINCE THE WORK INVOLVES EXISTING BUILDINGS, SYSTEMS AND FACILITIES, SPECIAL CONSIDERATION SHALL BE GIVEN TO EXAMINATION OF WORKING CONDITIONS, EXISTING FACILITIES AND ALL BUILDING STRUCTURES TO FAMILIARIZE HIMSELF/HERSELF WITH ALL EXISTING CONDITIONS. SLIGHT VARIATION OF ROUTING AND OR CONSTRUCTIONS SHOULD BE ANTICIPATED BY THIS CONTRACTOR TO AVOID CONFLICTS WITH OTHER TRADES ARE EXPRESSLY INCLUDED AS PART OF THE WORK WHENEVER REQUIRED AT NO ADDITIONAL COST TO THE OWNER. IGNORANCE ON THE PART OF THE CONTRACTOR WILL IN NO WAY RELIEVE HIM/HER OF THE OBLIGATIONS AND RESPONSIBILITIES ASSUMED UNDER THIS CONTRACT.
- 2. THE NATURE OF THE REMODEL TYPE CONSTRUCTION POSES SPECIAL PROBLEMS FOR THE DESIGNER ENGINEERS AS WELL AS THE PLUMBING CONTRACTOR. EVERY EFFORT HAS BEEN MADE BY THE ENGINEERS TO SHOW AND VERIFY, WHERE POSSIBLE, THE LOCATION OF THE EXISTING PLUMBING SYSTEMS. THE MAJOR PORTION OF THE PLUMBING SYSTEMS ARE AS SHOWN ON THE DRAWINGS: HOWEVER MINOR DEVIATIONS MAY BECOME EVIDENT AS THE JOB PROGRESSES. NO ADVANTAGE IS TO BE TAKEN BY THE PLUMBING CONTRACTOR BECAUSE THESE MINOR DIFFERENCES. PLUMBING CONTRACTOR SHALL PERFORM A FIELD VERIFICATION BEFORE BIDDING THIS PROJECT.
- 3. CONTRACTOR WILL BE RESPONSIBLE FOR COORDINATING HIS/HER DEMOLITION WORK WITH OTHER TRADES, AND TO PROTECT FROM DAMAGE EXISTING PIPES USED FOR FUTURE CONNECTIONS.
- 4. CONTRACTOR SHALL FIELD VERIFY THE EXACT LOCATION, DEPTH AND CONDITION OF ALL EXISTING PIPES, IN EACH UNIT, INCLUDING THROUGH THE USE OF VIDEO INSPECTION. ANY AND ALL DEFICIENCIES ENCOUNTERED THAT MAY NEGATIVELY IMPACT THE PLUMBING DESIGN, RESULTING IN ADDITIONAL CONSTRUCTION COSTS, SHALL BE BROUGHT TO THE IMMEDIATE ATTENTION OF A.E. FOR CONSIDERATION AND APPROVAL PRIOR TO SUCH TASKS BEING PERFORMED.
- 5. EXISTING PIPES SERVING AREAS NOT COVER BY THIS CONTRACT BUT IN SERVICE AT THIS TIME SHALL NOT BE INTERRUPTED UNLESS IT IS A TEMPORARY INTERRUPTION COORDINATED WITH THE OWNER.
- 6. PLUMBING CONTRACTOR SHALL CAP ALL UNUSED DRAINAGE SYSTEMS BELOW FINISHED FLOOR AND REMOVE ALL UNUSED PORTIONS ABOVE GROUND AND ALL ASSOCIATED ACCESSORIES AND TRIMS.
- 7. PLUMBING CONTRACTOR SHALL CAP ALL UNUSED DOMESTIC HOT AND COLD WATER LINES AT BRANCH VALVES FROM MAIN DISTRIBUTION LINES AND REMOVE ALL UNUSED PIPING, HANGERS AND ACCESSORIES. 8. ALL CAPPED PLUMBING LINES SHALL BE INSPECTED PRIOR TO COVERING

PLUMBING SPECIFICATION

1. GENERAL:

MATERIAL SHALL BE NEW, UNUSED, BEST OF THEIR RESPECTIVE KINDS AND FREE FROM DEFECTS IN WORKMANSHIP; IN CONFORMANCE WITH THE LATEST PUBLICATIONS IN FORCE AT TIME OF BIDDING. 2. PIPE AND FITTINGS:

A. SANITARY SOIL AND VENT PIPING: SERVICE WEIGHT CAST IRON BELL AND SPIGOT PIPE AND FITTINGS, ASTM.A74- LATEST EDITION, NO HUB CAST IRON PIPE AND FITTINGS, CISPI. 301-LATEST EDITION, PIPE AND FITTINGS SHALL BE MARKED WITH THE COLLECTIVE TRADEMARK OF THE CAST IRON SOIL PIPE INSTITUTE, OD DWV. COPPER PIPE WITH CAST BRASS OR WROUGHT COPPER SOLDER JOINT FITTINGS, ASTM. B306–79, (ABOVE GROUND). VENTING AS HEREIN BEFORE SPECIFIED OR GALVANIZED THREADED STEEL WITH MALLEABLE IRON FITTINGS. B. DOMESTIC WATER SUPPLY PIPING: COPPER PIPE TYPE 'L' WITH BRONZE OR WROUGHT COPPER SOLDER JOINT FITTINGS, ASTM.B88–78.

. CONDENSATE PIPING: AS HEREIN BEFORE SPECIFIED FOR SANITARY SOIL, WASTE AND VENT PIPING. ALTERNATE:

A. SANITARY SOIL/ STORM DRAINAGE BELOW GROUND: SCHEDULE 40 SOLID PLASTIC PVC PIPE ASTM D1785.

3. JOINTS AND METHODS OF CONNECTION: A. CAST IRON BELL AND SPIGOT PIPE: COMPRESSION GASKET. INSTALL PER MANUFACTURER'S RECOMMENDATION. GASKET AND PIPE BY SAME MANUFACTURER. B. CAST IRON NO-HUB PIPE: MAKE JOINTS WITH NEOPRENE RUBBER SLEEVE AND STAINLESS STEEL RING CLAMP PER MANUFACTURER'S RECOMMENDATIONS. GASKET AND PIPE BY SAME MANUFACTURER.

. DWV COPPER PIPE: JOINT WITH 95-5 TIN-ANTIMONY SOLDER, INSTALL PER MANUFACTURER'S RECOMMENDATIONS.

TYPE 'L' COPPER TUBE: JOIN WITH 95–5 TIN–ANTIMONY SOLDER, INSTALL PER MANUFACTURER'S RECOMMENDATIONS. E. STEEL PIPE:

a. THREADED JOINTS: AFTER CUTTING AND BEFORE THREADING, REAM ALL PIPE AND REMOVE BURRS. MAKE JOINTS WITH JOINT COMPOUND APPLIED TO MALE THREADS ONLY.

b. FLANGED JOINTS: STANDARD WEIGHT, 150 P.S.I. STEEL, WITH APPROVED RED RUBBER GASKET OR NEOPRENE RUBBER GASKET, INSTALL AS PER MANUFACTURER'S RECOMMENDATIONS.

. SCHEDULE 40 PVC MOLDED PREFORMED FITTINGS, PVC-DWV, SOCKET SOLVENT CEMENT, ASTM D-2467

4. UNIONS AND FLANGES:

A. COPPER PIPE: BRONZE UNIONS FOR 2 INCHES AND SMALLER. FOR 2-1/2 INCHES AND LARGER USE BRONZE FLANGED CONNECTIONS 150 POUND CLASS. B. DIELECTRIC UNIONS OR FLANGES: UNIONS SHALL MEET DIMENSIONAL REQUIREMENTS AND TENSILE STRENGTH OF PIPE UNIONS IN ACCORDANCE WITH FED. SPEC. WW-U-531E. UNIONS OR FLANGES SHALL BE SUITABLE FOR REQUIRED OPERATING PRESSURES AND TEMPERATURE CONDITIONS. UNIONS SHALL HAVE METAL CONNECTIONS ON BOTH ENDS. ENDS SHALL BE THREADED OR SOLDERED TO MATCH ADJACENT PIPING. METAL PARTS OF UNION OR FLANGED SHALL BE SEPAREATED TO PREVENT CURRENT FLOW BETWEEN DISSIMILAR METALS. EPCO DIELECTRIC PIPE FITTINGS OR EQUIVALENT.

5. ESCUTCHEONS: CHROME PLATED OR STAINLESS STEEL WITH SET SCREWS FOR HOLDING SECURELY IN PLACE. USE ESCUTCHEONS ON PIPES PASSING THROUGH WALLS, FLOORS AND CEILINGS OF FINISHED AREAS. 6. PIPE INSULATION:

A. ALL CONDENSATE LINES SHALL BE INSULATED WITH 3/4" FIRE RETARDANT ARMAFLEX INSULATION WITH A MAXIMUM OF 25/50 FLAME SPREAD AND SMOKE DEVELOPED RESPECTIVELY.

3. ALL HOT WATER LINES SHALL BE INSULATED WITH 1" FIRE RETARDANT ARMAFLEX INSULATION WITH A MAXIMUM OF 25/50 FLAME SPREAD AND SMOKE DEVELOPED RESPECTIVELY. . ALL PLUMBING PIPES AT THE STAGE AND SEATING AREAS SHALL BE INSULATED WITH 1" FIRE RETARDANT ARMAFLEX INSULATION WITH A MAXIMUM OF 25/50 FLAME SPREAD AND SMOKE DEVELOPED RESPECTIVELY.

		SAN	SANITARY DRAIN
		V	SANITARY VENT LINE
	SD	SD	STORM DRAIN
	CD	CD	CONDENSATE DRAIN LINE
	—— P&T ——	PTR	PRESSURE AND TEMPERATURE RELIEF LINE
	G	G	GAS LINE
,		CW	COLD WATER LINE
	—— ICW——	ICW	IRRIGATION COLD WATER LINE
		HW	HOT WATER LINE
		HWR	HOT WATER RECIRCULATING LINE
		BV	FULL PORT–BONZE/BRASS TEFLON SEATED BALL VALVE
		CV	CHECK VALVE
c			BALANCING VALVE
		VIV	VALVE IN RISER
		HB	HOSE BIBB W/ VACUUM BREAKER
		AC	AIR CHAMBER
	₽	SA	SHOCK ARRESTOR (P.D.I. SIZE 'A' TYPICAL UNLESS NOTED OTHERWISE.)
		CO	CLEAN-OUT PLUG
		WCO	WALL CLEAN-OUT
	•	CNTE	CONNECT TO EXISTING
		FD	FLOOR DRAIN
		RD	ROOF DRAIN
	۲	ORD	EMERGENCY OVERFLOW ROOF DRAIN
		VTR AP FOS FOV CO CTG FDH FHC FE FE/CO H CIP FE/C H FHV CIG FHV CIG FHV CIG FHV CIG FE/CO CIG CIG FHC FE/CO CIG FHC FIC FIC FIC FOR FOR FOR FOR FOR FOR FOR FOR FOR FOR	VENT THRU ROOF ACCESS PANEL FUEL OIL SUPPLY FUEL OIL RETURN FUEL OIL VENT CLEAN OUT WALL CLEAN OUT FLOOR CLEAN OUT CLEAN OUT TO GRADE FIRE DEPT. CONN. (SIAMESE) FIRE HYDRANT FIRE HOSE CABINET FIRE VALVE CABINET W/ HFV FIRE EXTINGUISHER CAB. W/ FE FIRE EXTINGUISHER CAB. W/ FE FIRE EXT./CARBON DIOXIDE WATER HEATER UNDER GROUND DUCTILE IRON PIPE CORRUGATED METAL PIPE CAST IRON PIPE TRAP PRIMER (RESEALER) AIR CONDITIONER THERMOMETER FIRE HOSE VALVE AIR HANDLING UNIT CEILING UNDERGROUND RAIN WATER LEADER

	,	UNRI	NG FI	XIUR	E CONNECTION SCH	EDULE
SYMBOL	DESCRIPTION	DRAIN	COLD WATER	HOT WATER	MANUFACTURER/MODEL	TRIM
P-1	WATER CLOSET	4"	1/2"		AMERICAN STANDARD "CADET" 3 FLOWISE RIGHT HEIGHT #2835.128.020 VITREOUS CHINA, LOW CONSUMPTION, 1.28 GPF, ELONGATED SIPHON JET FLUSH ACTION 16–1/2" RIM HEIGHT.	CLOSE-COUPLED TANK, CHROME FINISH TRIP LEVER CENTOCO 820STS.001 HEAVY DUTY TOILET SEAT. FOR ELONGATED BOWL OPEN FRONT SEAT. SUPPLY: MCGUIRE BV172 TOILET SUPPLY, CHROME FINISH POLISHED BRASS WITH ESCUTCHEON AND STAINLESS STEEL BRAIDED RISER. FLOOR FLANGE WITH ALL BRASS BOLTS AND WITH RUBBER GASKET.
P-1H	WATER CLOSET (HANDICAP)	4"	1/2"		AMERICAN STANDARD "CADET" 3 FLOWISE RIGHT HEIGHT #2835.128.020 VITREOUS CHINA, LOW CONSUMPTION, 1.28 GPF, ELONGATED SIPHON JET FLUSH ACTION 16-1/2" RIM HEIGHT.	CLOSE-COUPLED TANK, CHROME FINISH TRIP LEVER CENTOCO 820STS.001 HEAVY DUTY TOILET SEAT. FOR ELONGATED BOWL OPEN FRONT SEAT. SUPPLY: MCGUIRE BV172 TOILET SUPPLY, CHROME FINISH POLISHED BRASS WITH ESCUTCHEON AND STAINLESS STEEL BRAIDED RISER. FLOOR FLANGE WITH ALL BRASS BOLTS AND WITH RUBBER GASKET.
P-2	LAVATORY	1 1/4"	1/2"	1/2"	AMERICAN STANDARD "DECLYNE "#0321.075 FOR CONCEALED ARMS SUPPORTS, WALL HUNG, 4" CENTERS, VITREOUS CHINA, REAR OVERFLOW, SOAP DEPRESSION, FAUCET LEDGE. CARRIER: WATTS TCA-411 SINGLE CARRIER	FAUCET: AMERICAN STANDARD MODEL 8115F, 4" CENTER, SINGLE LEVER FAUCET, POLISHED CHROME FINISH, SPEED CONNECT POP-UP DRAIN. DRAIN: AMERICAN STANDARD POP-UP DRAIN AND TAILPIECE DRAIN: McGUIRE #8872C POLISHED CHROME FINISHED BRASS P-TRAP WITH CLEAN OUT PLUG AND ESCUTCHEON. SUPPLY: MCGUIRE # BV170 FAUCET SUPPLY, CHROME FINISH POLISHED BRASS WITH ESCUTCHEON AND FLEXIBLE COPPER RISER.
P-2H	LAVATORY-ADA FOR ADA HEIGHT REFERS TO ARCHITECTURAL DRAWINGS	1 1/4"	1/2"	1/2"	AMERICAN STANDARD "DECLYNE "#0321.075 FOR CONCEALED ARMS SUPPORTS, WALL HUNG, 4" CENTERS, VITREOUS CHINA, REAR OVERFLOW, SOAP DEPRESSION, FAUCET LEDGE. CARRIER: WATTS TCA-411 SINGLE CARRIER	FAUCET: AMERICAN STANDARD MODEL 8115F, 4" CENTER, SINGLE LEVER FAUCET, POLISHED CHROME FINISH, SPEED CONNECT POP-UP DRAIN, ADA COMPLIANT. DRAIN: AMERICAN STANDARD POP-UP DRAIN AND TAILPIECE DRAIN: MCGUIRE #155 WCC OFFSET OPEN GRID DRAIN DRAIN:McGUIRE #8872C POLISHED CHROME FINISHED BRASS P-TRAP WITH CLEAN OUT PLUG AND ESCUTCHEON. SUPPLY: MCGUIRE # BV170 FAUCET SUPPLY, CHROME FINISH POLISHED BRASS WITH ESCUTCHEON AND FLEXIBLE COPPER RISER. INSULATION: TPW2000WC PROWRAP VANDAL RESISTANT SANITARY COVERING, FLEXIBLE SEAMLESS MOLDED CLOSED-CELL PVC RESIN, FORMULATED WITH ANTI-MICROBIAL ADDITIVE. (ADA ONLY)
P-3	SHOWER	2"	1/2"	1/2"		FAUCET: AMERICAN STANDARD #T385.501/R120SS, PRESSURE BALANCING MIXING VALVE, BRASS BODY, WASHERLESS CERAMIC DRIP-FREE DISC VALVE CARTRIDGE, INTEGRAL HOT LIMIT STOP, SCREW DRIVERS STOPS, METAL WALL ESCUTCHEON, METAL LEVER HANDLE, 1.5 GPM SHOWER HEAD. DRAIN: WATTS#FD-100-A-2" FLOOR DRAIN OUTLET.
P-3H	SHOWER (HANDICAP)	2"	1/2"	1/2"		FAUCET: AMERICAN STANDARD #T385.500/R120SS, PRESSURE BALANCING MIXING VALVE, BRASS BODY, WASHERLESS CERAMIC DRIP-FREE DISC VALVE CARTRIDGE, INTEGRAL HOT LIMIT STOP, SCREW DRIVERS STOPS, METAL WALL ESCUTCHEON, METAL LEVER HANDLE, AMERICAN STANDARD 1662.604 WATER-SAVING SPRAY HAND SHOWER 1.5 GPM CHROME PLATED HAND SHOWER WITH FLEXIBLE METAL HOSE, 1660.400 IN-LINE VACUUM BREAKER, WALL SUPPLY, AND 36" SLIDE BAR. DRAIN: WATTS#FD-100-A-2" FLOOR DRAIN OUTLET.
P-4	SINK (SINGLE COMP.)	1 1/2"	1/2"	1/2"	ELKAY MODEL PSRQ1918 TOP MOUNT SINK NICKEL BEARING STAINLESS STEEL, GAUGE 20, 3 HOLES FAUCET, 19" X 18" X 7 1/8" OVERALL SIZE, SATIN FINISH, FULLY UNDERCOATED, 3 1/2" DRAIN OPENING	FAUCET: ELKAY LK1000CR, SINGLE LEVER FAUCET, 3 HOLES REQUIRED, CERAMIC DISC CARTRIDGE, OVERALL HEIGHT 7 1/2", SPOUT REACH 8" DRAIN: ELKAY #LK-35 BASKET STRAINER, CHROME PLATED CAST BRASS WITH TAILPIECE. MACGUIRE# #8912 POLISHED CHROME PLATED CAST BRASS P-TRAP WITH CLEANOUT PLUG AND ESCUTCHEON. MCGUIRE#BV170 FAUCET SUPPLIES, CHROME FINISH, COMMERCIAL DUTY 1/4 TURN BALL VALVE ANGLE STOP.
P-4H	SINK-ADA (SINGLE COMP.)	1 1/2"	1/2"	1/2"	ELKAY MODEL PSRADQ191955L SELF-RIMMING SINK NICKEL BEARING STAINLESS STEEL, GAUGE 20, 3 HOLES FAUCET, 19 1/2" X 19" X 5 1/2" OVERALL SIZE, SATIN FINISH, FULLY UNDERCOATED, 3 1/2" DRAIN OPENING.	FAUCET: ELKAY LK1000CR, SINGLE LEVER FAUCET, 3 HOLES REQUIRED, CERAMIC DISC CARTRIDGE, OVERALL HEIGHT 7 1/2", SPOUT REACH 8" DRAIN: ELKAY #LK-35 BASKET STRAINER, CHROME PLATED CAST BRASS WITH TAILPIECE. MACGUIRE# #8912 POLISHED CHROME PLATED CAST BRASS P-TRAP WITH CLEANOUT PLUG AND ESCUTCHEON. MCGUIRE#BV170 FAUCET SUPPLIES, CHROME FINISH, COMMERCIAL DUTY 1/4 TURN BALL VALVE ANGLE STOP.INSULATION: TPW2000WC PROWRAP VANDAL RESISTANT SANITARY COVERING, FLEXIBLE SEAMLESS MOLDED CLOSED-CELL PVC RESIN, FORMULATED WITH ANTI-MICROBIAL ADDITIVE.
P-5	CLOTHES WASHER	3"	1/2"	1/2"		ACORN HOSE VALVE#8131—CR STRAIGHT NOSE WITH VACUUM BREAKER OATEY # 38928 CENTER DRAIN WASHING MACHINE BOX.
WH-1	WATER HAMMER ARRESTORS		1/2"	1/2"		WATTS PDI CERTIFIED. PRECHARGED DRAWN COPPER
WCO	WALL CLEANOUT	2"				WATTS LINE CLEANOUT #CO-450-RD
FCO	GRADE CLEANOUT	4"				WATTS ACCESS HOUSING #CO-300-MF
HB/VB	HOSE BIBB	1/2"				WOODFORD ANTI-SIPHON WALL FAUCET MODEL 24PC POLISHED CHROME

		WATE	IR HE	ATER	SCHEDU	LE	
MARK	CAP. GAL.	HEATING SOURCE	ELEMENTS	KW. OR BTUH	VOLTAGE	EF	REMARKS
EWH-1 UNITS # 1,2,3,4	20	ELECTRICAL	SINGLE	2.5 KW	120 V, 1PH, 60HZ	0.95	LOCHINVAR MODEL JRCO20FS

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1
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SHEET NO.

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ROBERT BETANCOURT P.E. (MECHANICAL) LICENSE NO. 34788 "In my professional judgement and to the best of my knowledge and belief, these plans and specifications comply with applicable Building Codes." DATE: SEPTEMBER 15, 2014 REVISED: 12-13-13 BLDG. DEPT. COMMENTS 2 04-23-14 BLDG. DEPT. COMMENTS AD DRAWING NAME:

PLUMBING NOTES SPECS., LEGEND, & SCHEDULES

DRAWING TITLE:

MIAMI, FL

CITY OF MIAMI LIFE QUEST RENOVATIONS 14950 NE 11TH AVENUE

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GARTEK ENGINEERING CORP.

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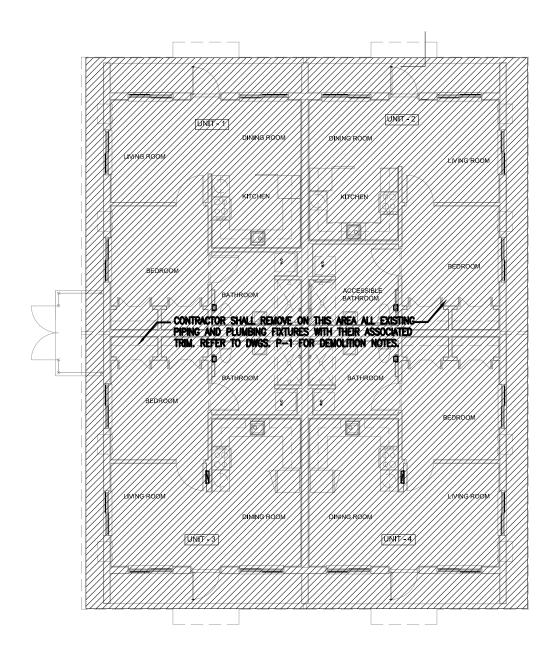
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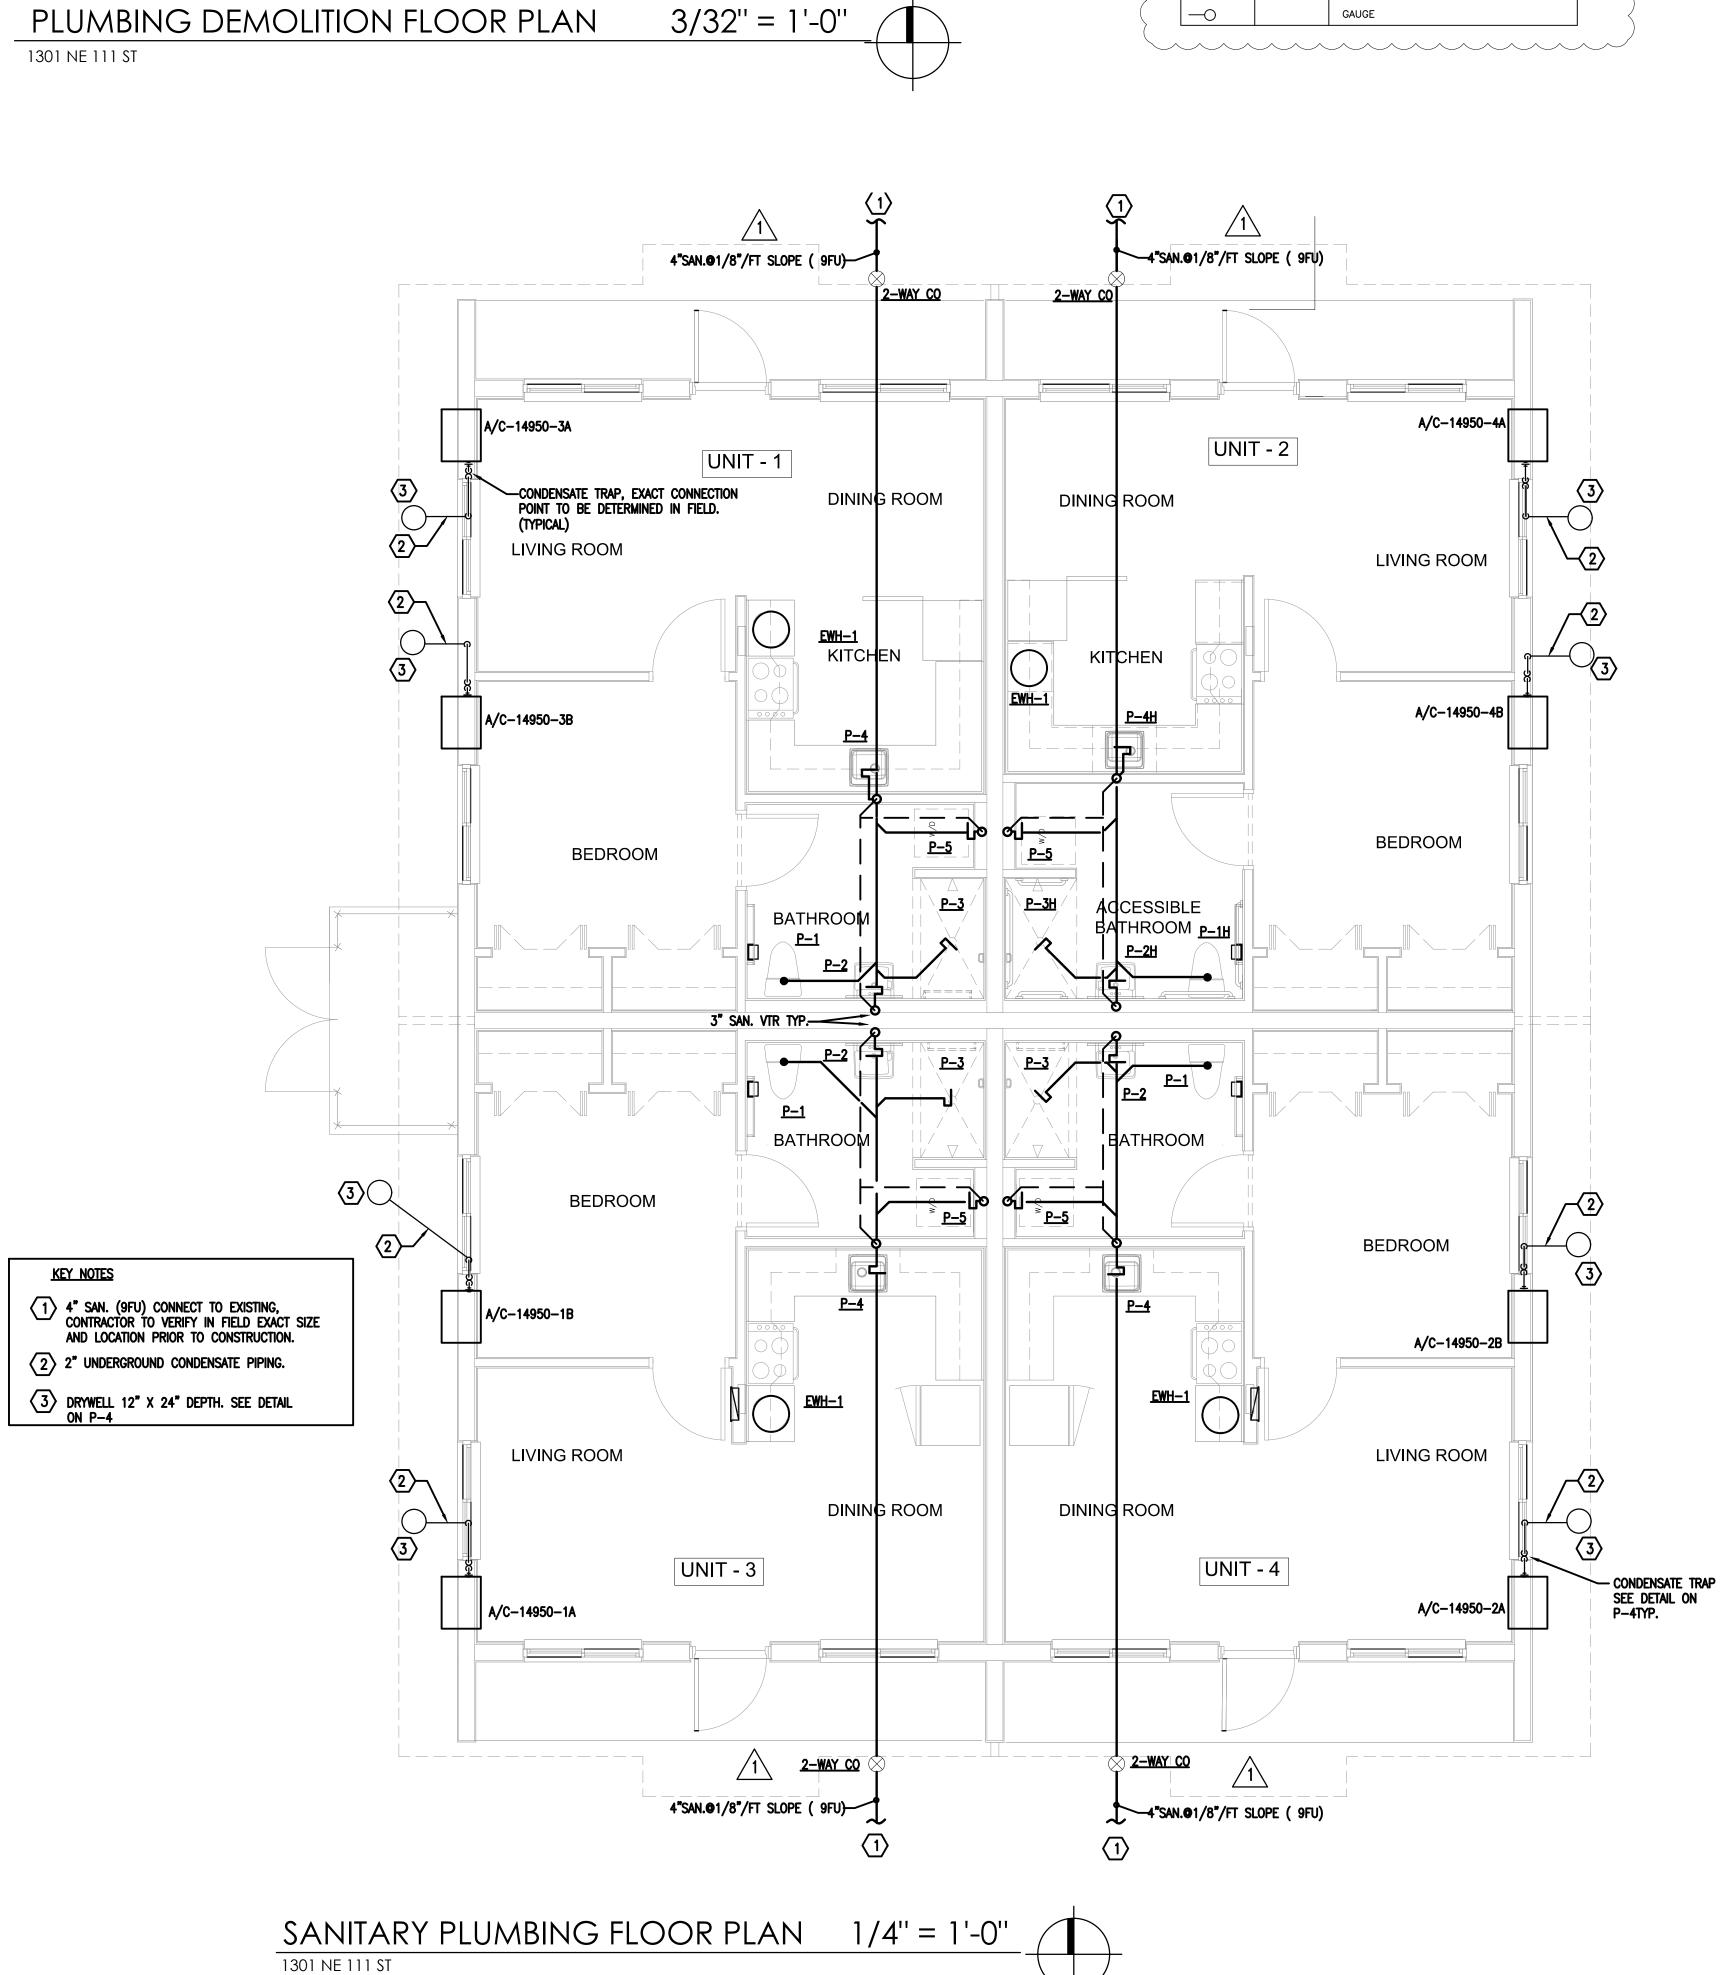
Gartek Project No. 2867


7210 SOUTHWEST 39TH TERRACE MIAMI, FLORIDA 33155

MECHANICAL, ELECTRICAL, PLUMBING ENGINEER:


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FIR	E PRO	DTECTION LEGEND
SYMBOL	ABBREV.	DESCRIPTION
		FIRE MAIN
_		CONCEALED PENDENT SPRINKLER HEAD
—0—		UPRIGHT SPRINKLER HEAD
◀		SIDEWALL SPRINKLER HEAD
-	CH.V.	CHECK VALVE
—0		GAUGE
	CH.V.	CONCEALED PENDENT SPRINKLER HEAD UPRIGHT SPRINKLER HEAD SIDEWALL SPRINKLER HEAD CHECK VALVE



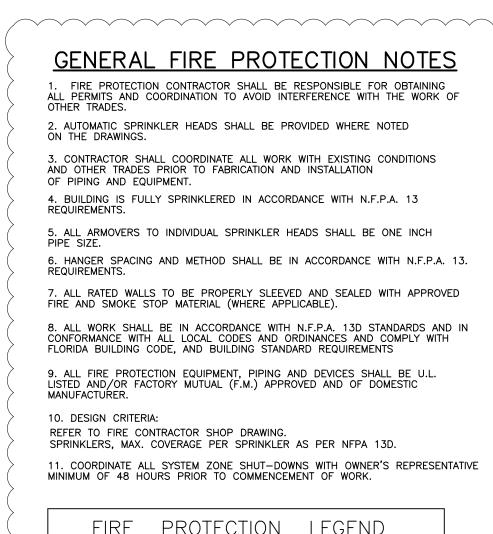

SHEET	NO.

"In my prof	LICEI essional judgement and	COURT P.E. (MECHANICAL) NSE NO. 34788 d to the best of my knowledge and belief, these ith applicable Building Codes."
DATE:	SEPTEM	IBER 15, 2014
REVISED:		
	10-20-13	BLDG. DEPT. COMMENTS
2	7-8-14	BDC
3	8-18-14	BDC-FIRE PROTECTION REQUIREMENT
CAD DRA	AWING NAME:	

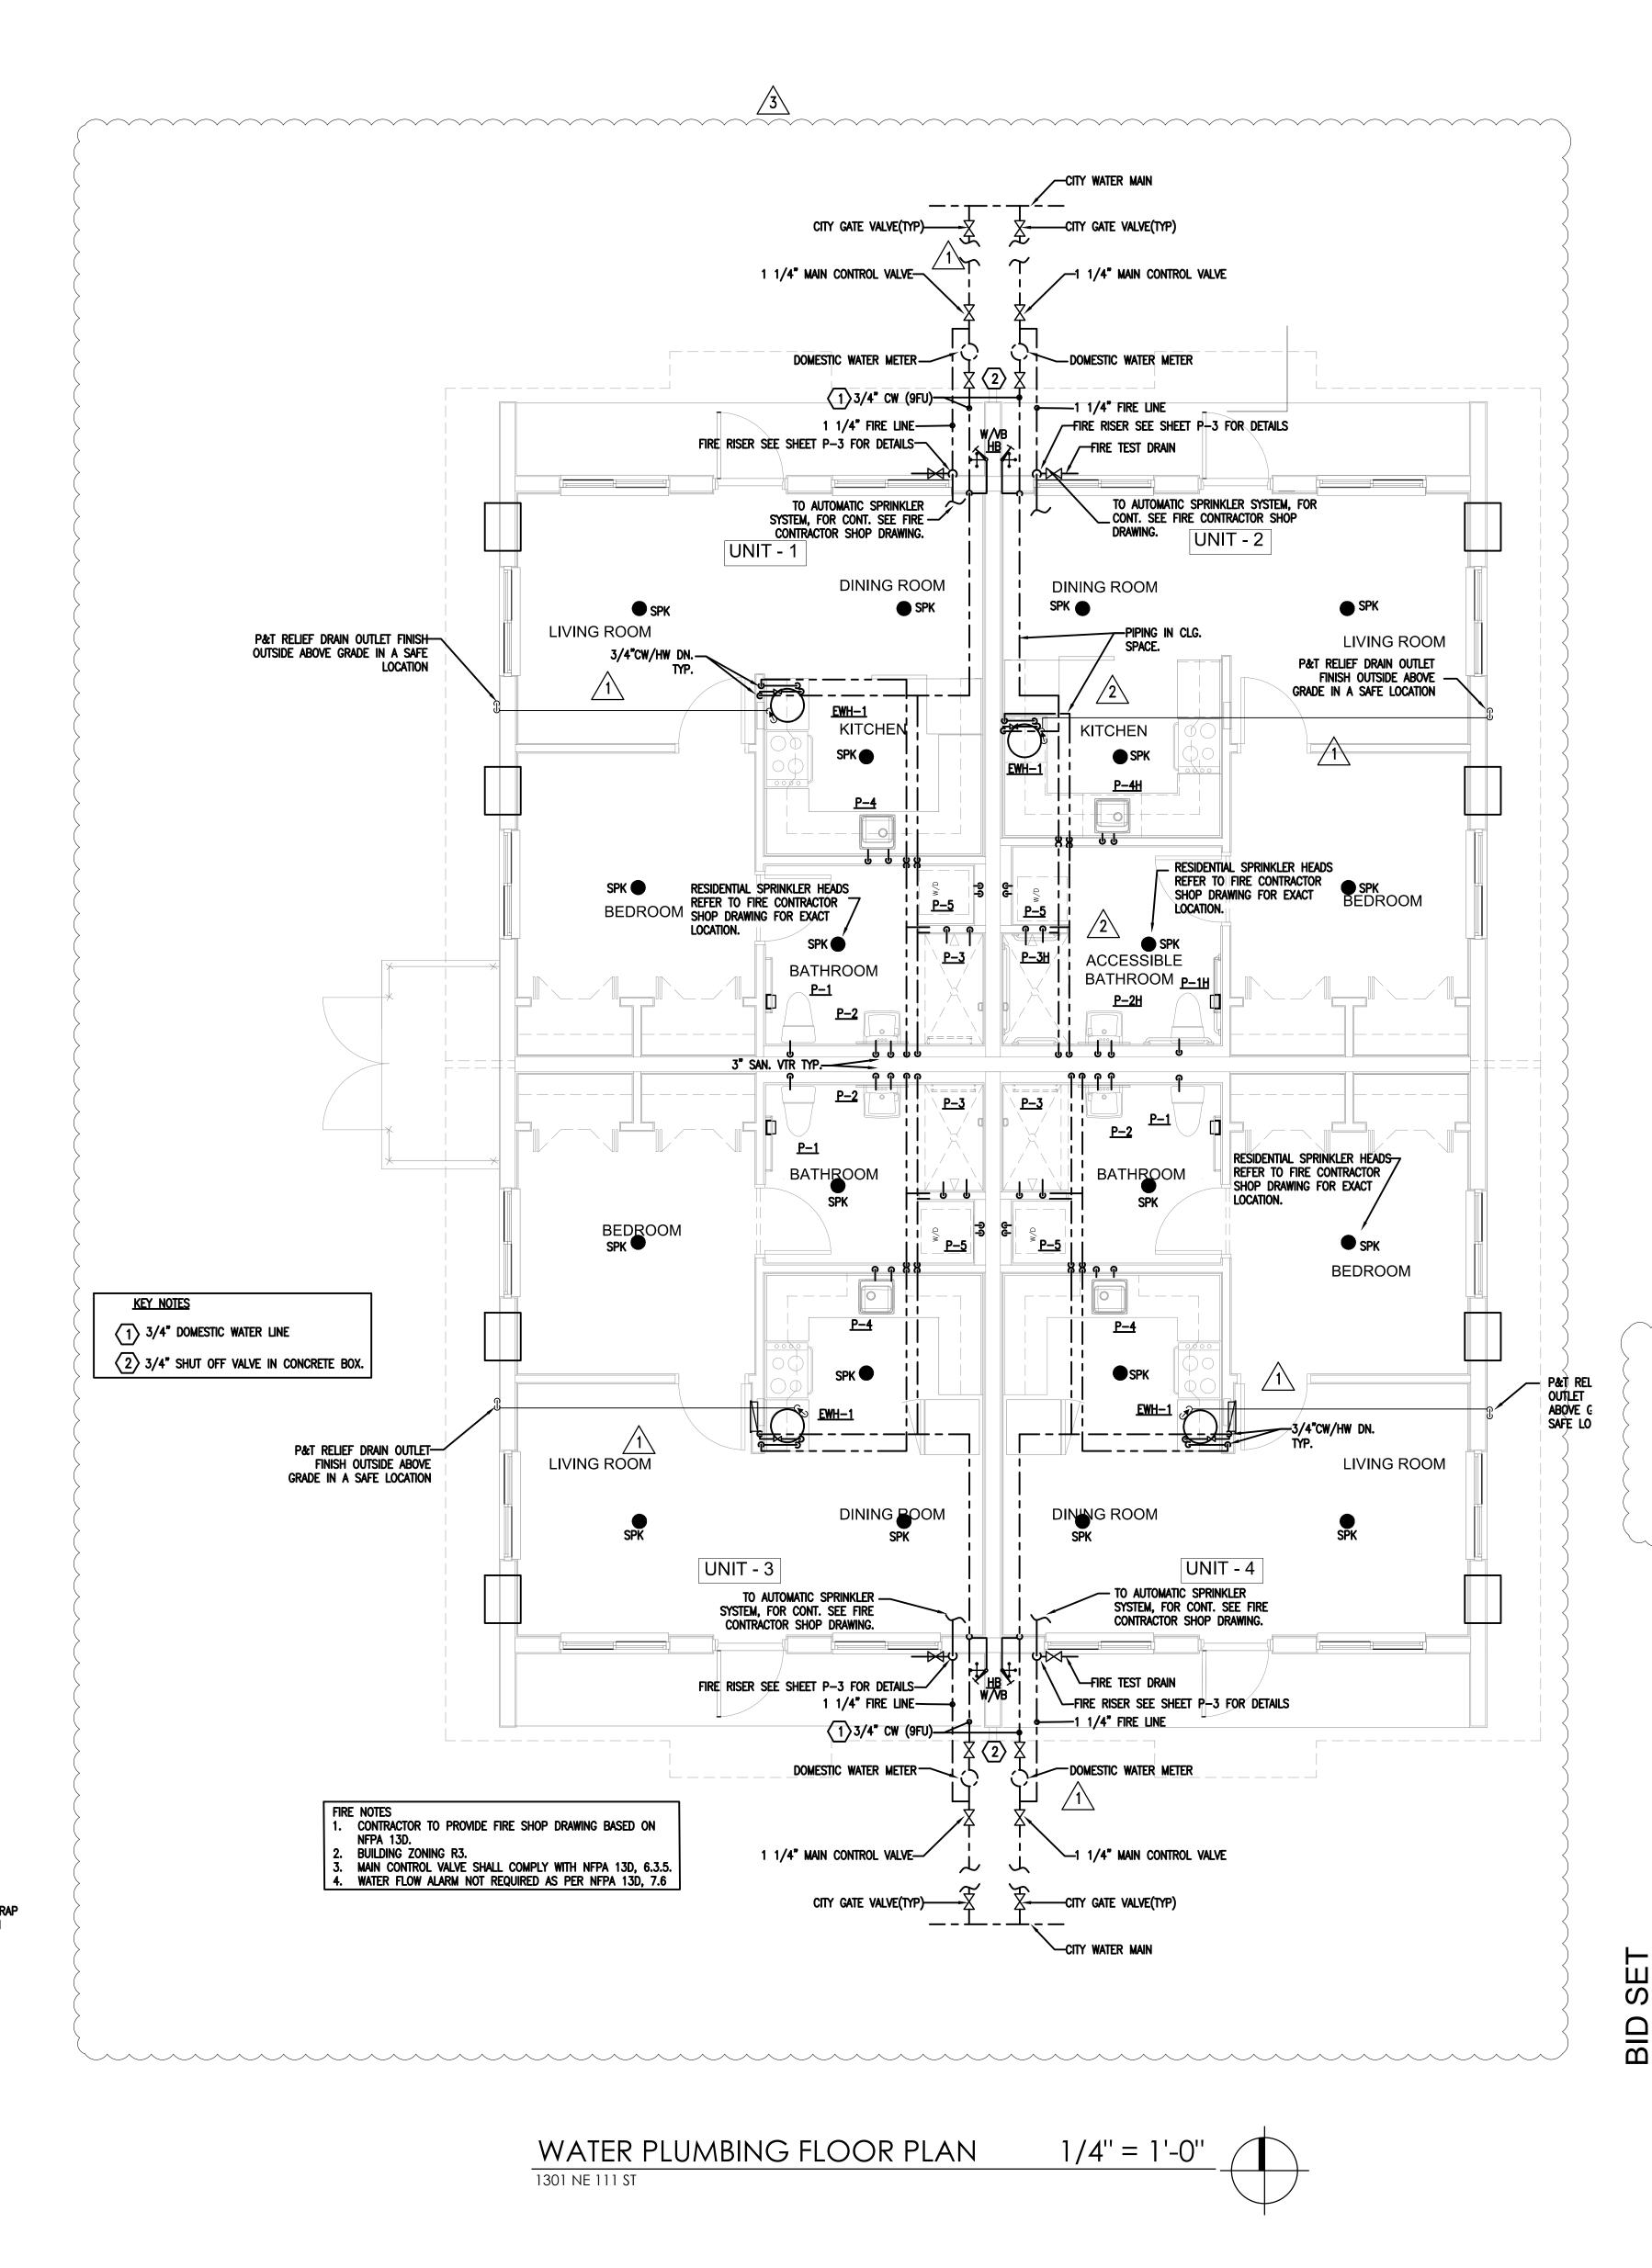"In my profe	DBERT BETANCOURT P.E. (MECHANICAL) LICENSE NO. 34788 ssional judgement and to the best of my knowledge and belief, these becifications comply with applicable Building Codes."
DATE:	SEPTEMBER 15, 2014
REVISED:	

MIAMI, FL
DRAWING TITLE:
PLUMBING FLOOR PLAN & FIRE PROTECTION

CITY OF MIAMI LIFE QUEST RENOVATIONS 14950 NE 11TH AVENUE

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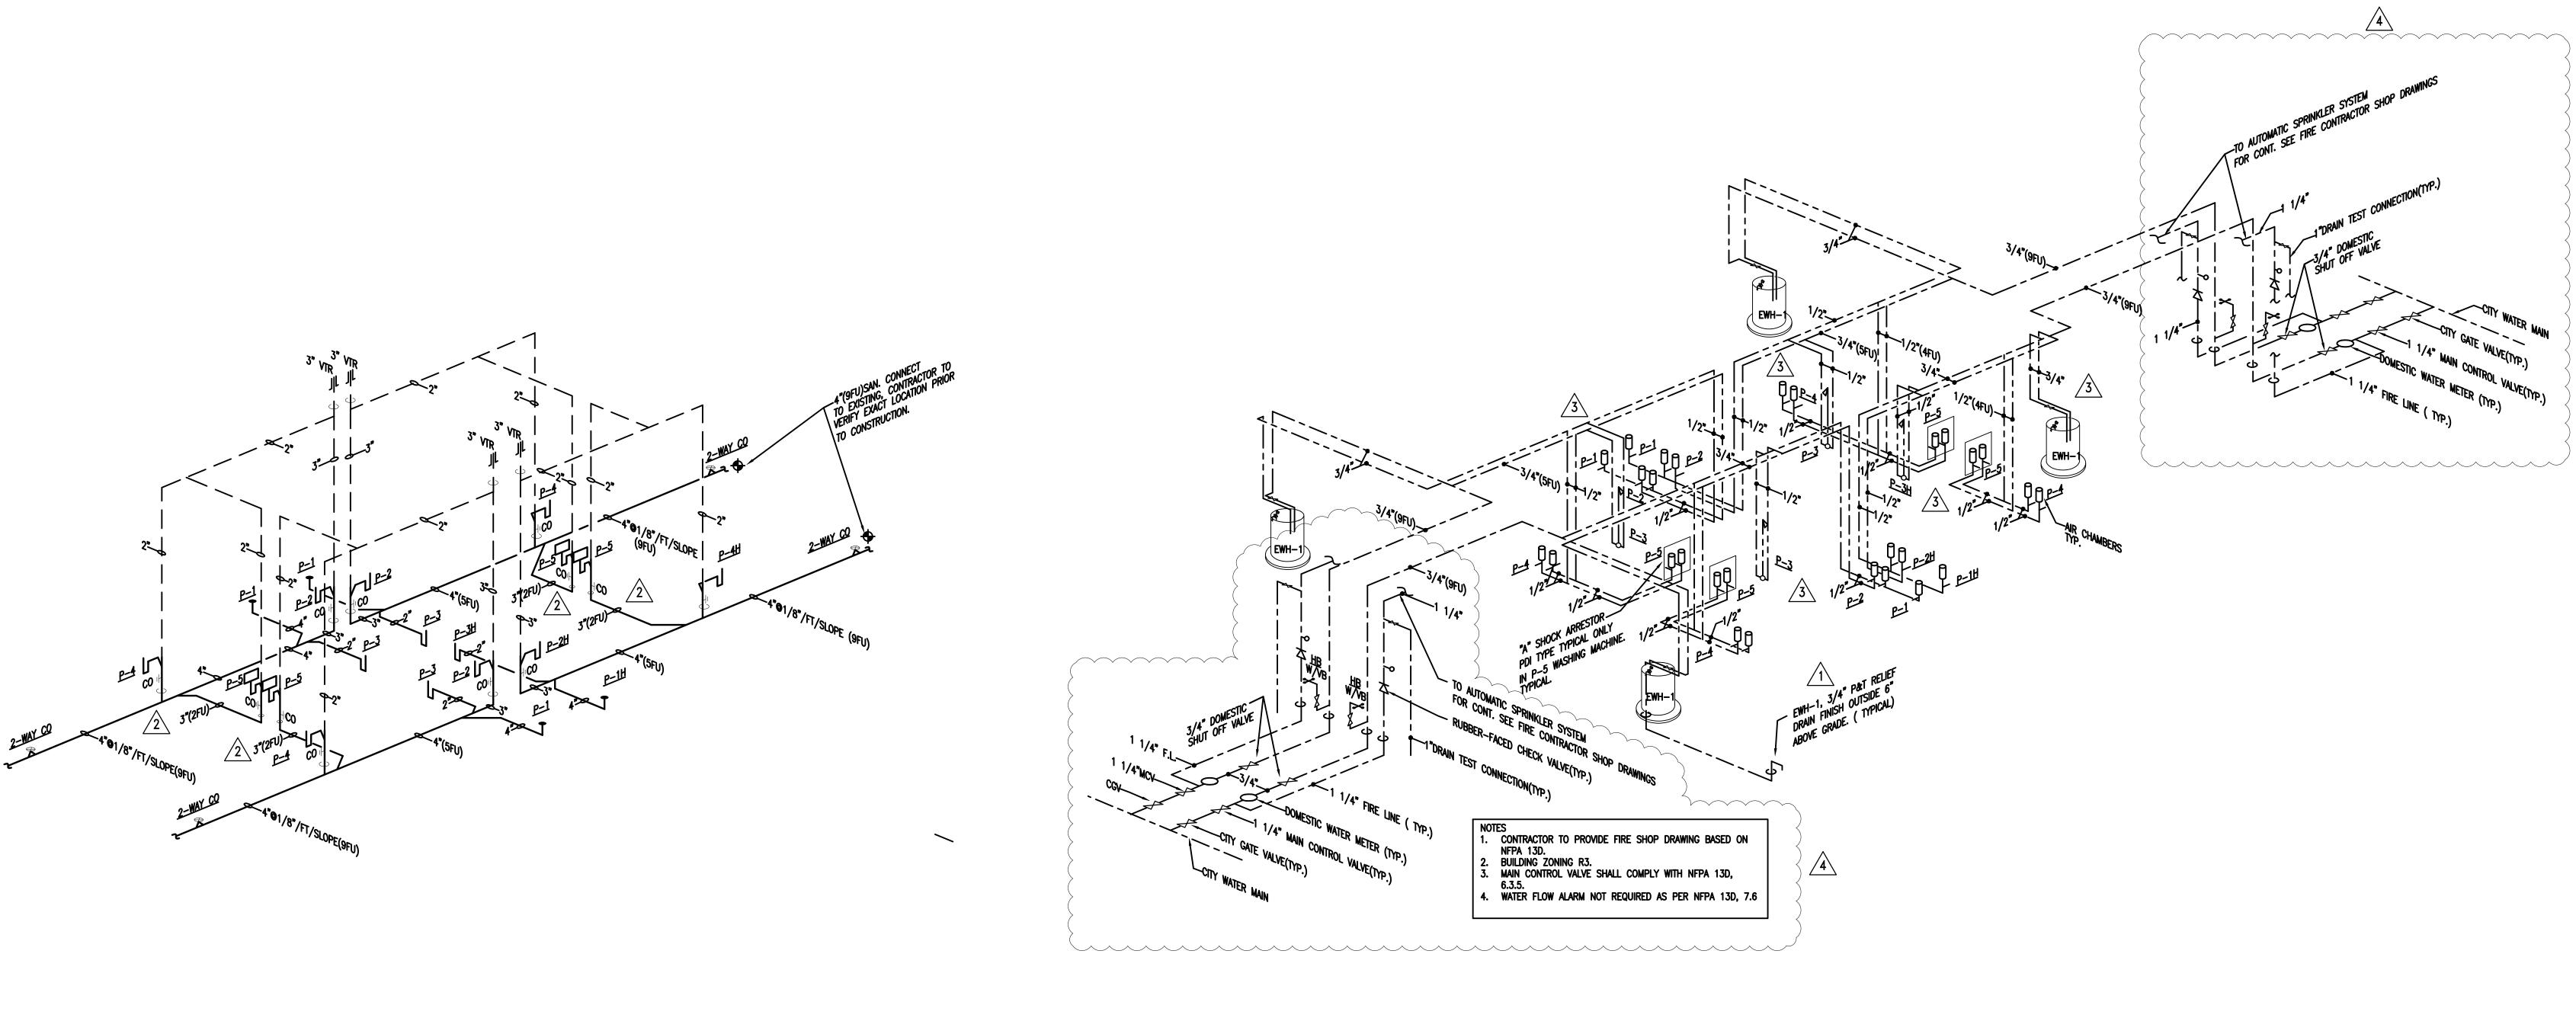
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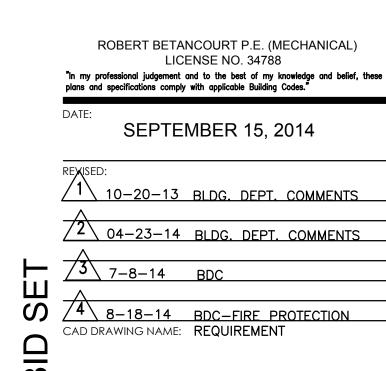
Sanitary riser NTS

WATER RISER

NTS









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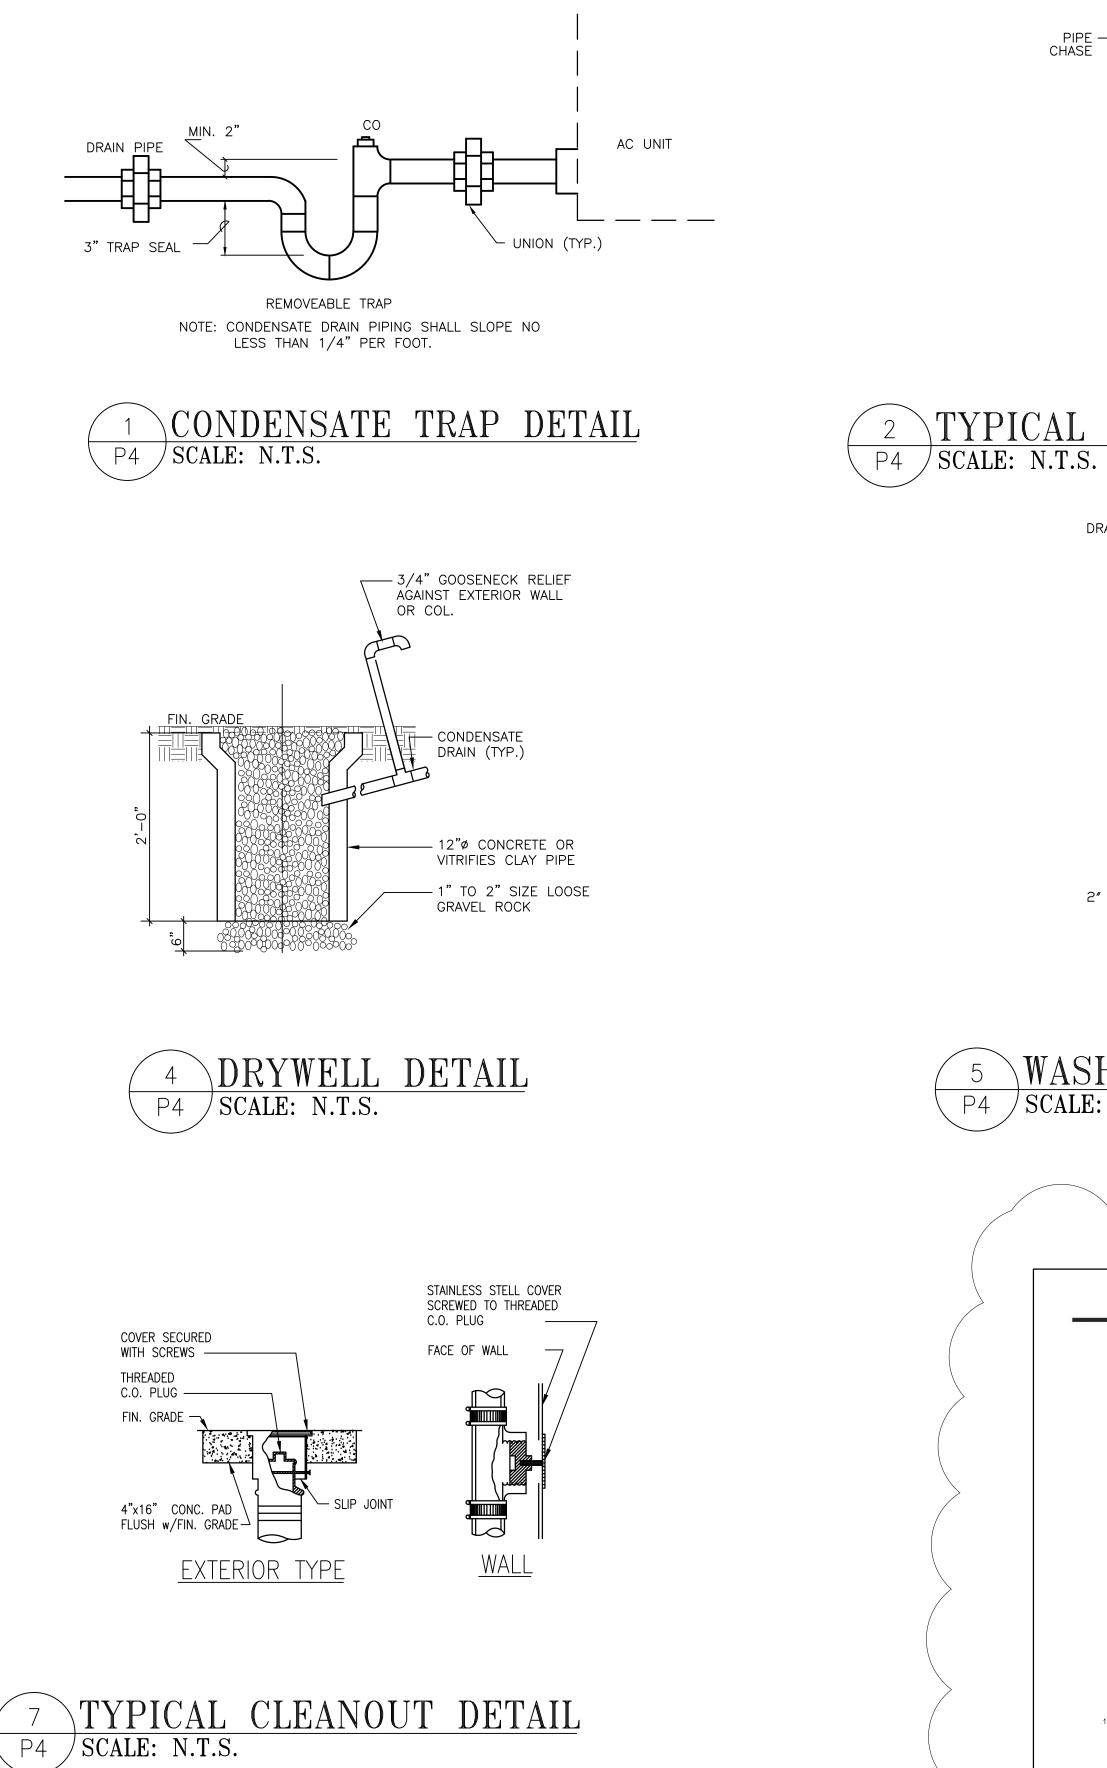
GARTEK ENGINEERING CORP. 7210 SOUTHWEST 39TH TERRACE


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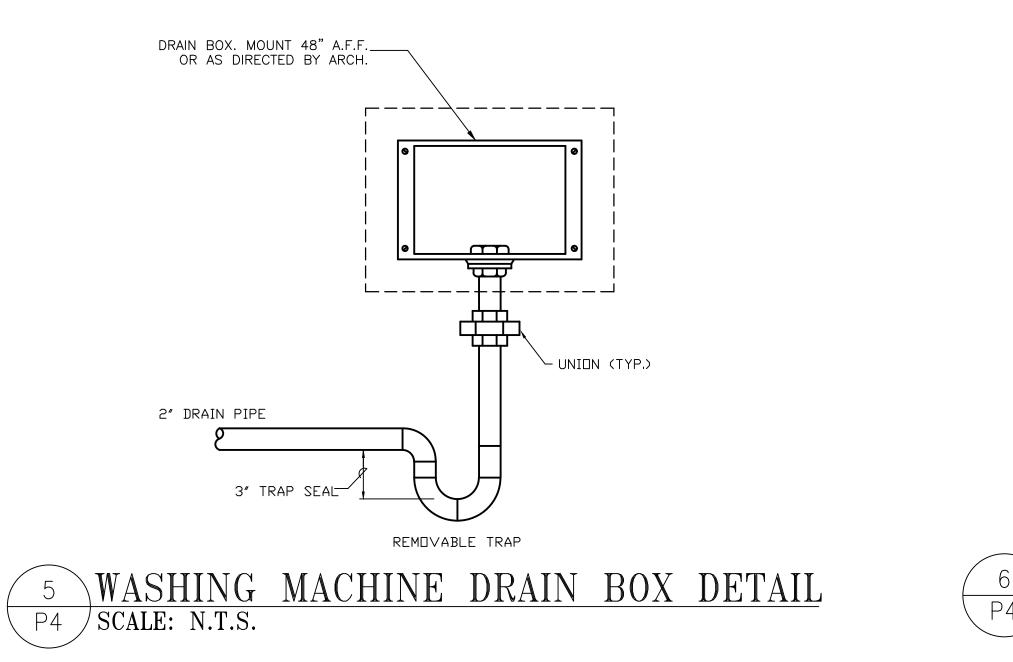
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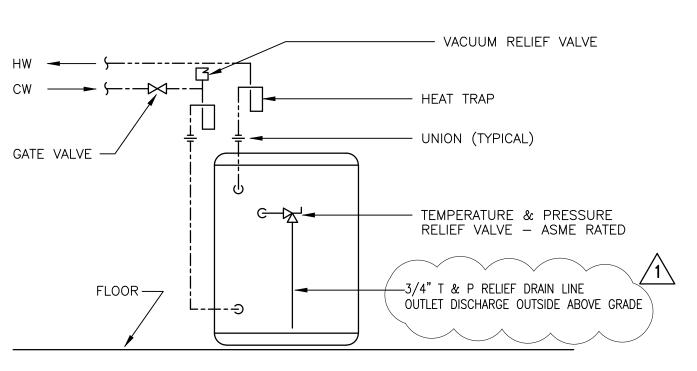





2 TYPICAL LAVATORY MOUNTING DETAIL



<u>TREMCO</u>						Tk	7	$\widehat{\mathcal{M}}$
System No. C. AL 2/45			Conduit+ – Nom 3 in. Code (NFPA 70).	(76 mm) diam (or smaller) Schedul	e 40 PVC condu	it installed	l in accon
System No. C-AJ-2615 August 13, 2008			i diene Styrene (ABS) F sed (process or supply)				le 40 solid	or cellula
F Ratings – 2 and 3 Hr (See Item 4B) T Ratings – 0, ¼, 2, and 2-3/4 Hr (See Item 4B) (UL/cUL)			inyl Chloride (CPVC) I cess or supply) piping s		. (76 mm) diam (or :	smaller) FLOWG	UARD GOL	.D® SDR1
			inyl Chloride (CPVC) I supply) piping systems		(76 mm) diam (or :	smaller) BLAZEN	ASTER® S	DR13.5 C
	A. Pac	king Material ·	top system shall consis – (Optional) – Polyeth	ylene backer roo	firmly packed into			
	mat	erial (Item 4B)						
	as s surf both	becified in Tab ace of floor at sides of the v e below.	y Material* – Sealant ble below. In hollow-co the thickness specifier vall or flush with eithe IC – TREMstop IA+	re floors, fill ma I in the Table be	terial to be applied low. For wall assen	within annulus nblies, fill mate	flush with rial may b	n top and e applied
Sealant may be applied flush with <u>SECTIONA-A</u> either surface of floor or wall or with both surfaces of wall.	Through- Penetrant Type	Max Diam of Penetrant In (mm)	Max Min/max Diam Annular Opng Space In. In (mm) (mm)	Steel Sleeve	Min. Fill Mt Thick (floor or both sides of wall)	Min. Fill Mtl Thick (wall, applied to one side	F Rating hr	T Rating hr
			,,		In (mm)	only) In (mm)		
	A,D	2 (51)	4 (102) ½ / 1-3/ (6/35		1-1/2 (38)	2 (51)		
	B,C,F,G	2 (51)	4 (102) ½ / 1-3/1 (6/35		1-1/2 (38)	2 (51)	2	2
SECTION A-A	B,C,F,G	2 (51)	4 (102) ½ / 1-3/0 (6/35		1-1/2 (38)	2 (51)	2	0
 Floor or Wall Assembly – Min 4-1/2 in. (114 mm) thick reinforced lightweight or normal weight (100-150 pcf or 1600-2400 kg/m³) concrete floor or min 5 in. (127 mm) thick reinforced lightweight or normal weight (100-150 pcf or 1600-2400 kg/m³) concrete wall. 	A,D	2 (51)	4 (102) ½ / 1-3/8 (6/35		1-1/2 (38)	2 (51)	3	0+
Wall may also be constructed of any UL Classified Concrete Blocks* . Floor may also be constructed of any 6 in. (152 mm) thick UL Classified hollow core Precast Concrete Units . Max diam of opening 5 in. (152 mm). See Concrete Blocks (CAZT) and Precast Concrete Units* (CFTV) categories in the Fire Resistance Directory for names of	B,C,F,G	2 (51)	4 (102) ½ / 1-3/8 (6/35		1-1/2 (38)	2 (51)	3	2-3/4
 Steel Sleeve – (Optional. See Table in Item 4B) - Nom 4 in. (102 mm) diam (or smaller) No. 30 GA (0.016 in. or 0.41 mm thick) galv 	A,B,C,D,F,G	3 (76)	5 (152) ½ / (13/25		2-1/2 (64)	3-1/2 (89)	2	0
sheet steel and having a min 2 in. (51 mm) lap along the longitudinal seam. Sleeve installed by coiling the sheet steel to a diam smaller than the through opening, inserting the coil through the opening and releasing the coil to let it uncoil against the circular cutouts in the floor or wall. Sleeve also may be constructed of nominal 5 in. diameter (or smaller) Schedule 10 (or heavier) steel pipe	E	2 (51)	4 (102) ½ / (13/25		2 (51)	2 (51)	2	0
 cast or grouted into floor or wall. Length of the sleeve to be equal to the thickness of the floor or wall. The ends of the steel sleeve shall be flush with each surface of the floor or wall. Through Penetrants – One nonmetallic pipe to be installed either concentrically or eccentrically within the firestop system. The annular space between pipe and sleeve (Item 2) or opening shall be in accordance with the requirements in the table below. Pipe to be rigidly supported on both sides of floor or wall assembly. The following types and sizes of nonmetallic pipes may be used: A. Polyvinyl Chloride (PVC) Pipe – Nom 3 in. (76 mm) diam (or smaller) Schedule 40 solid-core PVC pipe for use in closed (process or supply) or vented (drain, waste or vent) piping system. B. Polyvinyl Chloride (PVC) Pipe – Nom. 3 in. (76 mm) diam (or smaller) Schedule 40 cellular core PVC pipe for use in closed (process or supply) or vented (drain, waste or vent) piping system. C. Chlorinated Polyvinyl Chloride (CPVC) Pipe – Nom 3 in. (76 mm) diam (or smaller) SDR13.5 CPVC pipe for use in closed (process or supply) piping systems. 	*Bearing the UL Cla	ssification Mar	alant is applied flush w *k the Online Certification 8 Underwriters Laborat				oratories I	Inc.
www.tremcosealants.com			www	220 Wickste	een Road, Beachwood eed Avenue, Toronto, C obson Avenue, Ashlar	N M4H 1G7 // Ph	one: 216.2 one: 416.4	92.5000 // 21.3300 //
P4 SCALE	<u>E ST(</u> : n.t.s		PING	D]	ETAI	LS		
	DPPING REFEREN FIRE RATED WA ED.				^			
		\wedge					/	

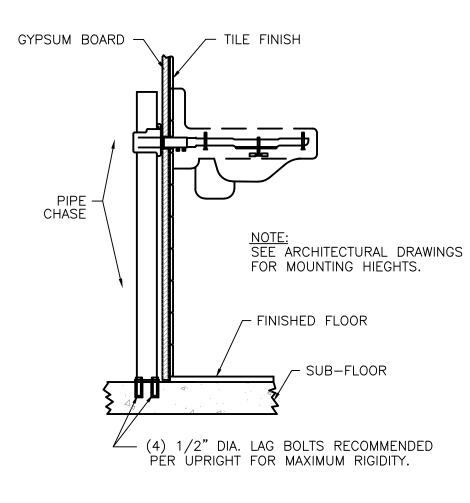

<u>3 ELECTRIC WATER HEATER DETAIL</u>

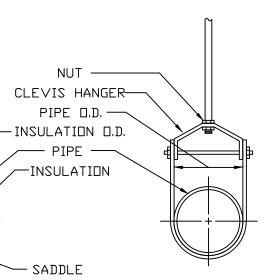

GATE VALVE

P4 / SCALE: N.T.S.

FLOOR —

- PIPE


└──GALV, SHIELD

PIPE

W/ INSULATION

PIPE W/DUT INSULATION

6 <u>CLEVIS TYPE PIPE HANGER DETAIL</u> P4 SCALE: N.T.S.

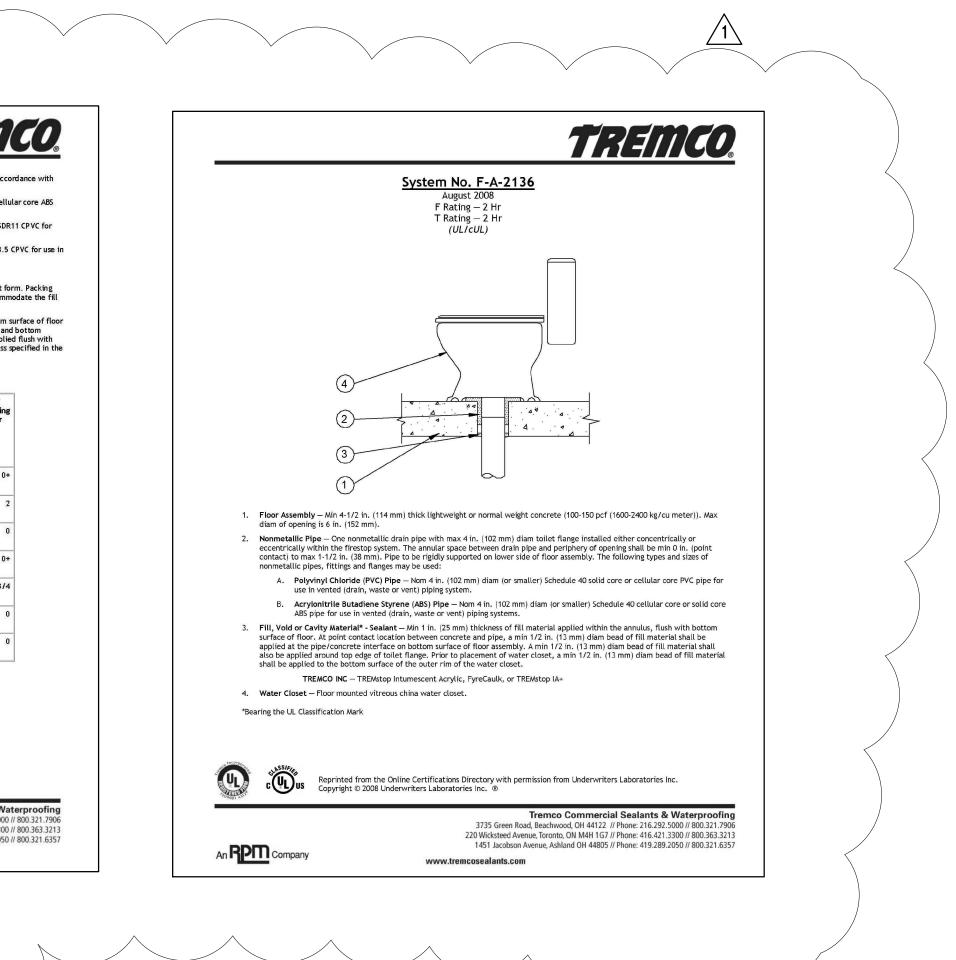



"In my p	ROBERT BETANCOURT P.E. (MECHANICAL) LICENSE NO. 34788 professional judgement and to the best of my knowledge and belief, these d specifications comply with applicable Building Codes."
DATE:	SEPTEMBER 15, 2014
	D: 10–20–13 BLDG. DEPT. COMMENTS
CAD D	RAWING NAME:
SHEET I	чО.

PLUMBING DETAILS

DRAWING TITLE:

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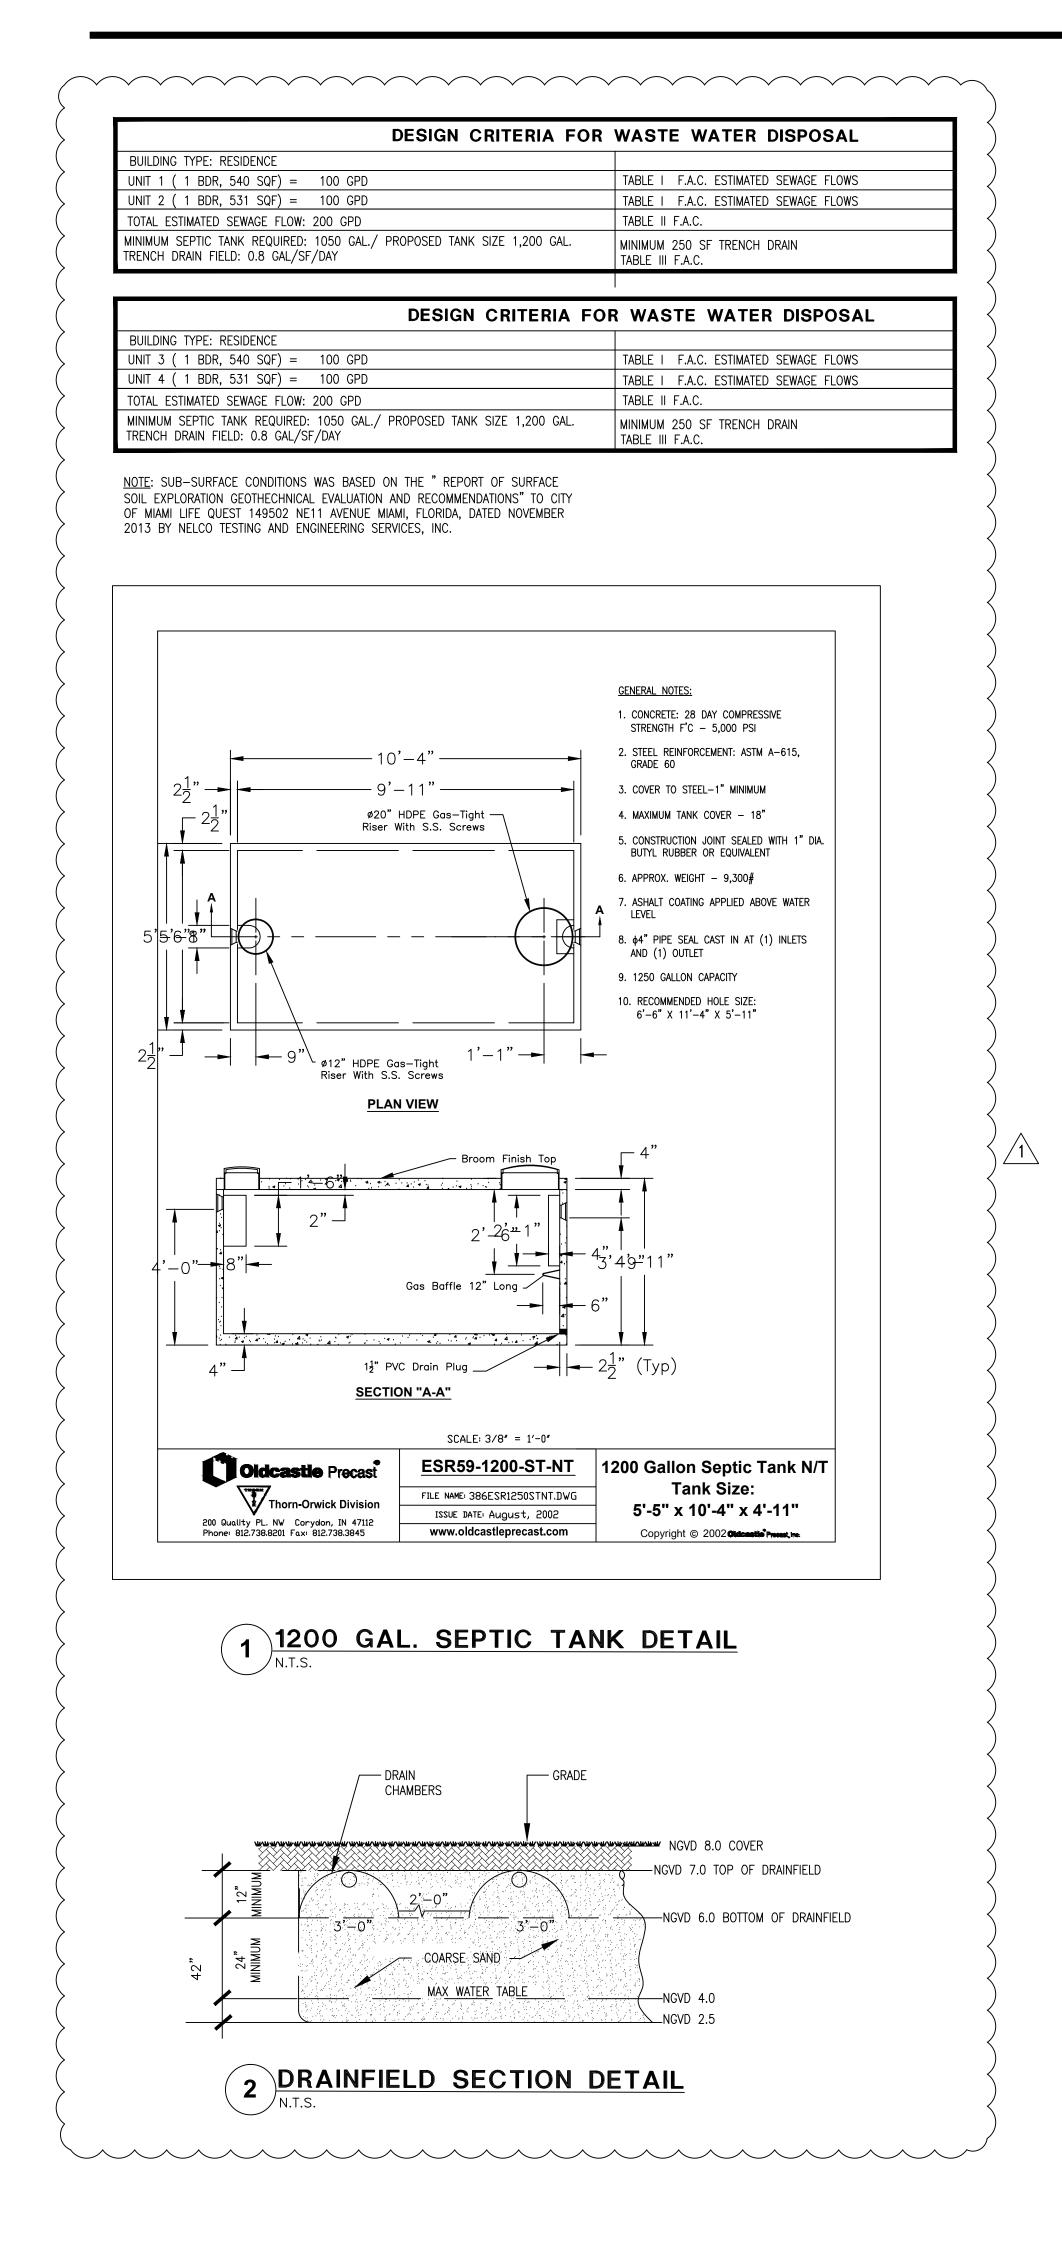
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MIAMI, FLORIDA 33155

CONSULTANTS:

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	PLUN	IBING LEGEND	PLUMBING GENERAL NOTES	PLUMBING SPECIFIC
	– SAN	SANITARY DRAIN	1. UNLESS OTHERWISE SPECIFIED ON THIS DRAWING CONTRACTOR SHALL REFER TO	1. GENERAL:
SD	– SD	STORM DRAIN	ORIGINAL LANDLORD SPECIFICATIONS FOR ALL APPLICABLE REQUIREMENTS, NOTES, DETAILS,	MATERIAL SHALL BE NEW, UNUSED
CD	– CD	CONDENSATE DRAIN LINE	CONSTRUCTION'S STANDARDS, ETC., COORDINATE WITH LANDLORD REQUIREMENTS PRIOR TO ORDERING AND/OR INSTALLATION OF ANY EQUIPMENT AND ACCESSORIES SHOWN.	FREE FROM DEFECTS IN WORKMAN PUBLICATIONS IN FORCE AT TIME
	– cw	COLD WATER LINE	2. THE CONTRACTOR SHALL FURNISH ALL LABOR, MATERIAL AND EQUIPMENT NECESSARY	2. PIPE AND FITTINGS: (TO SEP
1\$ 1	− BV	FULL PORT–BONZE/BRASS TEFLON SEATED BALL VALVE	FOR THE INSTALLATION OF A COMPLETE SEPTIC TANK AND DRAIN FIELD SYSTEM IN ACCORDANCE WITH THIS DRAWING, THE APPLICABLE EDITION OF CHAPTER 64E-6, FLORIDA ADMINISTRATIVE CODE, STANDARDS FOR ON SITE SEWAGE TREATMENT AND	A. SANITARY SOIL/DRAINAGE BELO PVC PIPE ASTM D1785.
	– VIV	VALVE IN RISER	DISPOSAL SYSTEMS.	B. DISPOSAL SYSTEM PIPING AS F
‡ .↓ ⊗	НВ со	HOSE BIBB W/ VACUUM BREAKER TWO WAY CO	3. THE CONTRACTOR SHALL PAY ALL COST OF PERMIT, INSPECTIONS AND OTHER COSTS INCIDENTAL TO THE COMPLETION AND TESTING OF THIS WORK. UPON FINAL INSPECTION, A CERTIFICATE FROM THE LOCAL STATE INSPECTION AUTHORITY SHALL BE FURNISHED TO	DRAINFIELD: PE PLASTIC PERFOR CONNECTIONS: SEE PLUMB. SPEC
<u> </u>	FCO	FLOOR CLEAN OUT	THE OWNER.	3. JOINTS AND METHODS OF CO
•	CTG UG CNTE	CLEAN OUT TO GRADE UNDER GROUND CONNECT TO EXISTING	4. EXISTING PIPES SERVING AREAS NOT COVERED BY THIS CONTRACT BUT IN SERVICE AT THIS TIME SHALL NOT BE INTERRUPTED EXCEPT AS A TEMPORARY INTERRUPTION COORDINATED WITH THE OWNER AND LANDLORD.	A. SCHEDULE 40 PVC MOLDED F SOLVENT CEMENT, ASTM D-2467
			5. CONTRACTOR SHALL VERIFY ALL SPACE CONDITIONS AND DIMENSIONS AT JOB SITE PRIOR TO FABRICATION AND INSTALLATION OF MATERIALS, PIPING AND EQUIPMENT.	
			6. ALL MATERIALS AND EQUIPMENT SHALL BE NEW AND MUST BE FURNISHED SO AS TO PREVENT ANY DELAY IN THE PROGRESS OF THE WORK.	
			 7. CONTRACTOR SHALL SUBMIT EQUIPMENT & PLUMBING FIXTURES SHOP DRAWINGS. SHOP DRAWINGS SHALL BE COORDINATED BY CONTRACTOR WITH ALL TRADES INCLUDING STRUCTURAL, LIGHTING. ARCHITECTURAL LATEST LAYOUTS, ETC. CONTRACTOR SHALL NOT PROCEED TO ORDER AND/OR INSTALL EQUIPMENT AND ACCESSORIES UNLESS SHOP DRAWING REVIEW PROCESS HAS BEEN COMPLETED AND REVIEWED BY THE ENGINEER OF RECORD (EoR) AND APPROVED BY THE OWNER REPRESENTATIVES. THE DRAWINGS ARE NOT TO BE SCALED. UNLESS SPECIFIC DIMENSIONS ARE SHOWN, THE ARCHITECTURAL AND/OR STRUCTURAL DRAWINGS, AND SITE CONDITIONS SHALL GOVERN EXACT LOCATION OF PLUMBING EQUIPMENT AND APPURTENANCES. MANUFACTURERS USED AS THE BASIS OF DESIGN ARE LISTED ON THE DRAWING'S SCHEDULES, ANY OTHERS MUST MEET OR EXCEED ALL SPECIFIED REQUIREMENTS. ANY SUBSTITUTIONS (WHERE ALLOWED BY "OR EQUAL" ON THESE DOCUMENTS) MUST BE ACCOMPANY BY A DETAIL COST AND EQUALITY COMPARISON OF ALL ITEMS INCLUDING ANY COST DIFFERENCES AND MUST BE SUBMITTED FOR EOR REVIEW TEN (10) WORKING DAYS PRIOR TO BIDS. IF "OR EQUAL" IS NOT LISTED AFTER THE MANUFACTURER'S NAME ON THESE DOCUMENTS, THE LISTED MANUFACTURER SHALL BE SUBMITTED, NO EXCEPTIONS ARE ALLOWED. NAMING ACCEPTABLE MANUFACTURER SHALL BE SUBMITTED, NO EXCEPTIONS ARE ALLOWED. NAMING ACCEPTABLE MANUFACTURER SHALL BE SUBMITTED, NO THESE DRAWINGS OR LISTED HEREIN. EOR IS SOLEMNLY RESPONSIBLE TO MAKE FINAL EQUALITY RECOMMENDATION TO THE OWNER. 8. PLUMBING CONTRACTOR SHALL GUARANTEE ALL WORK FREE OF DEFECTS IN MATERIALS 	
			AND WORKMANSHIP FOR A PERIOD OF ONE YEAR FROM DATE OF ACCEPTANCE. 9. COORDINATE SCHEDULING OF ALL REQUIRED INSPECTIONS WITH APPROPRIATE REGULATORY BODIES.	
			10. DRAINAGE SYSTEM DESIGN TO THE SPECTIC TANK INLET IS BASED ON 1/8" PER FOOT MINIMUM FALL FOR PIPES 3" OR LARGER AND 1/4" PER FOOT MINIMUM FALL FOR PIPES 2" OR SMALLER, ANY DEVIATIONS SHALL BE APPROVED BY ARCHITECT/ENGINEER.	

FLORIDA ADMINISTRATIVE CODE 64E-6.011 ABANDONMENT OF SYSTEMS.

SYSTEM IS DISCONTINUED FOLLOWING CONNECTION TO A SANITARY SEWER, FOLLOWING CONDEMNATION OR DEMOLITION OR REMOVAL OR DESTRUCTION, OF A BUILDING OR PROPERTY, OR DISCONTINUING THE USE OF A SEPTIC TANK AND REPLACEMENT WITH ANOTHER SEPTIC TANK, THE SYSTEM SHALL BE ABANDONED WITHIN 90 DAYS AND ANY FURTHER USE OF THE SYSTEM FOR ANY PURPOSE SHALL BE PROHIBITED. HOWEVER, IF THE DEPARTMENT OF ENVIRONMENTAL PROTECTION OR ITS DESIGNEE APPROVES THE USE OF THE RETENTION TANK WHERE THE TANK IS TO BECOME AN INTEGRAL PART OF A SANITARY SEWER SYSTEM OR STORMWATER MANAGEMENT SYSTEM, THE SEPTIC TANK NEED NOT BE ABANDONED.

(2) THE FOLLOWING ACTIONS SHALL BE TAKEN, IN THE ORDER LISTED, TO ABANDON AN ONSITE SEWAGE TREATMENT AND DISPOSAL SYSTEM: (A) PROPERTY OWNER OR AGENT SHALL APPLY FOR A PERMIT FROM THE DEPARTMENT TO ABANDON THE EXISTING ONSITE SEWAGE SYSTEM AND SUBMIT THE REQUIRED FEE. UPON RECEIVING A PERMIT: (B) THE TANK SHALL BE PUMPED OUT.

(C) THE BOTTOM OF THE TANK SHALL BE OPENED OR RUPTURED, OR THE ENTIRE TANK COLLAPSED SO AS TO PREVENT THE TANK FROM RETAINING WATER, AND

(D) THE TANK SHALL BE FILLED WITH CLEAN SAND OR OTHER SUITABLE MATERIAL, AND COMPLETELY COVERED WITH SOIL. (E) AN INSPECTION OF THE SYSTEM ABANDONMENT SHALL BE CONDUCTED BY THE DEPARTMENT OR BY THE LOCAL UTILITY OR PLUMBING AUTHORITY PERFORMING THE SYSTEM ABANDONMENT.

(3) THE PERMITTING PROVISIONS OF PARAGRAPH 64E–6.011(2)(A), F.A.C., ARE NOT REQUIRED IF A LOCAL UTILITY OR LOCAL PLUMBING AUTHORITY PERFORMS A SYSTEM ABANDONMENT PROGRAM WHICH REQUIRES THE COMPLETION OF THOSE STEPS LISTED IN PARAGRAPHS 64E–6.011(2)(B), (C), (D), AND (E), F.A.C. IF THE SYSTEM ABANDONMENT IS PERFORMED BY A LOCAL UTILITY OR LOCAL PLUMBING AUTHORITY, THE LOCAL UTILITY OR LOCAL PLUMBING AUTHORITY PERFORMING THE ABANDONMENT PROGRAM SHALL MAINTAIN A LOG OF ALL INSPECTIONS PERFORMED AND SHALL FORWARD THE LOG TO THE COUNTY HEALTH DEPARTMENT ON A MONTHLY BASIS.

(4) A SEPTIC TANK SERVING A SINGLE FAMILY RESIDENCE MAY, AT THE OWNER'S DISCRETION, BE CONVERTED INTO A CISTERN PURSUANT TO THE FOLLOWING PROCEDURES: (A) THE APPLICANT SHALL OBTAIN A SYSTEM ABANDONMENT PERMIT FROM THE

COUNTY HEALTH DEPARTMENT. (B) THE PERMIT APPLICATION SHALL SPECIFY THE INTENDED USE OF THE ABANDONED SEPTIC TANK. (C) THE ACTIVITIES RELATED TO ABANDONING THE ONSITE SEWAGE TREATMENT AND DISPOSAL SYSTEM SHALL NOT CREATE A SANITARY NUISANCE. (D) THE SEPTIC TANK SHALL BE DISCONNECTED FROM THE DRAINFIELD AND

FROM THE BUILDING SEWER PIPE. (E) ALL WORK TO DISCONNECT, CLEAN AND SANITIZE THE SEPTIC TANK SHALL BE CONDUCTED BY A REGISTERED SEPTIC TANK CONTRACTOR OR A STATE-LICENSED PLUMBER OR BY THE OWNER OF THE OWNER-OCCUPIED SINGLE

(1) WHENEVER THE USE OF AN ONSITE SEWAGE TREATMENT AND DISPOSAL FAMILY RESIDENCE BEING SERVED BY THE SEPTIC TANK. (F) ALL SEPTAGE, WASH WATER, AND OTHER LIQUIDS REMOVED FROM THE TANK SHALL BE REMOVED AND HANDLED AS SEPTAGE (RULE 64E-6.010, F.A.C.) BY A DOH-LICENSED SEPTAGE DISPOSAL SERVICE AND DISPOSED OF AT A DEP-REGULATED WASTEWATER TREATMENT FACILITY. (G) THE HEALTH DEPARTMENT SHALL INSPECT THE TANK ONCE IT IS DISCONNECTED, EMPTIED, CLEANED, DISINFECTED AND FILLED WITH WATER. THE INSPECTION SHALL DETERMINE WHETHER ALL OF THE FOLLOWING CONDITIONS HAVE BEEN MET:

> 1. THE TANK HAS BEEN DISCONNECTED FROM THE DRAINFIELD AND THE BUILDING SEWER. 2. THE TANK IS FULL OF WATER WITHIN 12 INCHES OF THE TOP OF THE TANK.

3. THE CLARITY OF THE WATER IS SUCH THAT A SECCHI DISK IS VISIBLE AT THE BOTTOM OF THE TANK. 4. THE PH OF THE WATER IN THE TANK IS BETWEEN 6.0 AND 8.0. 5. THE FREE CHLORINE RESIDUAL OF THE WATER IN THE TANK IS \leq 1.0 PPM.

6. THE TOTAL COLIFORM COUNT IS \leq 1000 PER 100 ML. 7. THE FECAL COLIFORM COUNT IS \leq 200 PER 100 ML.

8. NO SANITARY NUISANCE CONDITION EXISTS ON THE PROPERTY RELATED TO THE ABANDONMENT ACTIVITIES.

(H) ONE INSPECTION IS INCLUDED IN THE ABANDONMENT PERMIT FEE. THE APPLICANT SHALL PAY A REINSPECTION FEE FOR ANY ADDITIONAL INSPECTION VISITS NECESSARY UNTIL ALL OF THE CRITERIA IN SUBPARAGRAPHS 64E-6.011(4)(G)1. THROUGH 8. F.A.C., ARE MET AND FINAL APPROVAL OF THE ABANDONMENT IS GRANTED BY THE COUNTY HEALTH DEPARTMENT. (I) THE APPLICANT SHALL BE RESPONSIBLE FOR ALL REQUIRED LABORATORY FEES. ALL SAMPLING SHALL BE CONDUCTED BY COUNTY HEALTH DEPARTMENT

STAFF DURING THE FINAL INSPECTION. (J) THE SEPTIC TANK SHALL BE CONVERTED AND INSPECTED WITHIN 90 DAYS AFTER CONNECTION OF THE BUILDING PLUMBING TO THE SANITARY SEWER.

(K) THE TANK SHALL NOT BE CONNECTED TO ANY IRRIGATION COMPONENTS NOR SHALL THE WATER USED FOR IRRIGATION PURPOSES UNTIL FINAL APPROVAL OF THE ABANDONMENT HAS BEEN GRANTED BY THE COUNTY HEALTH DEPARTMENT.

(L) UPON FINAL APPROVAL OF THE ABANDONMENT, USE OF THE TANK OR THE DRAINFIELD FOR SEWAGE STORAGE, TREATMENT OR DISPOSAL IS PROHIBITED AND CONSTITUTES A NUISANCE INJURIOUS TO HEALTH AS DEFINED BY SECTION 386.041, F.S.

(M) UPON FINAL APPROVAL OF THE ABANDONMENT, THE WATER COLLECTED IN THE TANK SHALL BE UTILIZED FOR NON-POTABLE, IRRIGATION PURPOSES ONLY.

RULEMAKING AUTHORITY 381.0065, 489.553, 489.557 FS. LAW IMPLEMENTED 381.0065, 381.00655, 381.0066, PART I 386 FS. HISTORY-NEW 12-22-82, AMENDED 2-5-85, FORMERLY 10D-6.53, AMENDED 3-17-92, 1-3-95, FORMERLY 10D-6.053, AMENDED 6-18-03, 6-25-09.

FICATION

JSED, BEST OF THEIR RESPECTIVE KINDS AND (MANSHIP; IN CONFORMANCE WITH THE LATEST IE OF BIDDING. SEPTIC TANK INLET)

BELOW GROUND: SCHEDULE 40 SOLID PLASTIC

FOLLOWS: ORATED FIELD TUBING 4" DIAMETER. SANITARY PIPING & PECS

CONNECTION: PREFORMED FITTINGS, PVC-DWV, SOCKET

SEAL ROBERT BETANCOURT P.E. (MECHANI LICENSE NO. 34788 In my professional judgement and to the best of my knowledge and plans and specifications comply with applicable Building Codes." DATE: February 20, 2015 REVISED: 06-17-15 DOH. COMMENT CAD DRAWING NAME: SHEET NO.		SEPTIC TAN NOTES ANI DETAILS PLA	C
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CITY OF MIAMI LIFE QUEST RENOVATIONS 14950 NE 11TH AVEN

MIAMI, FL


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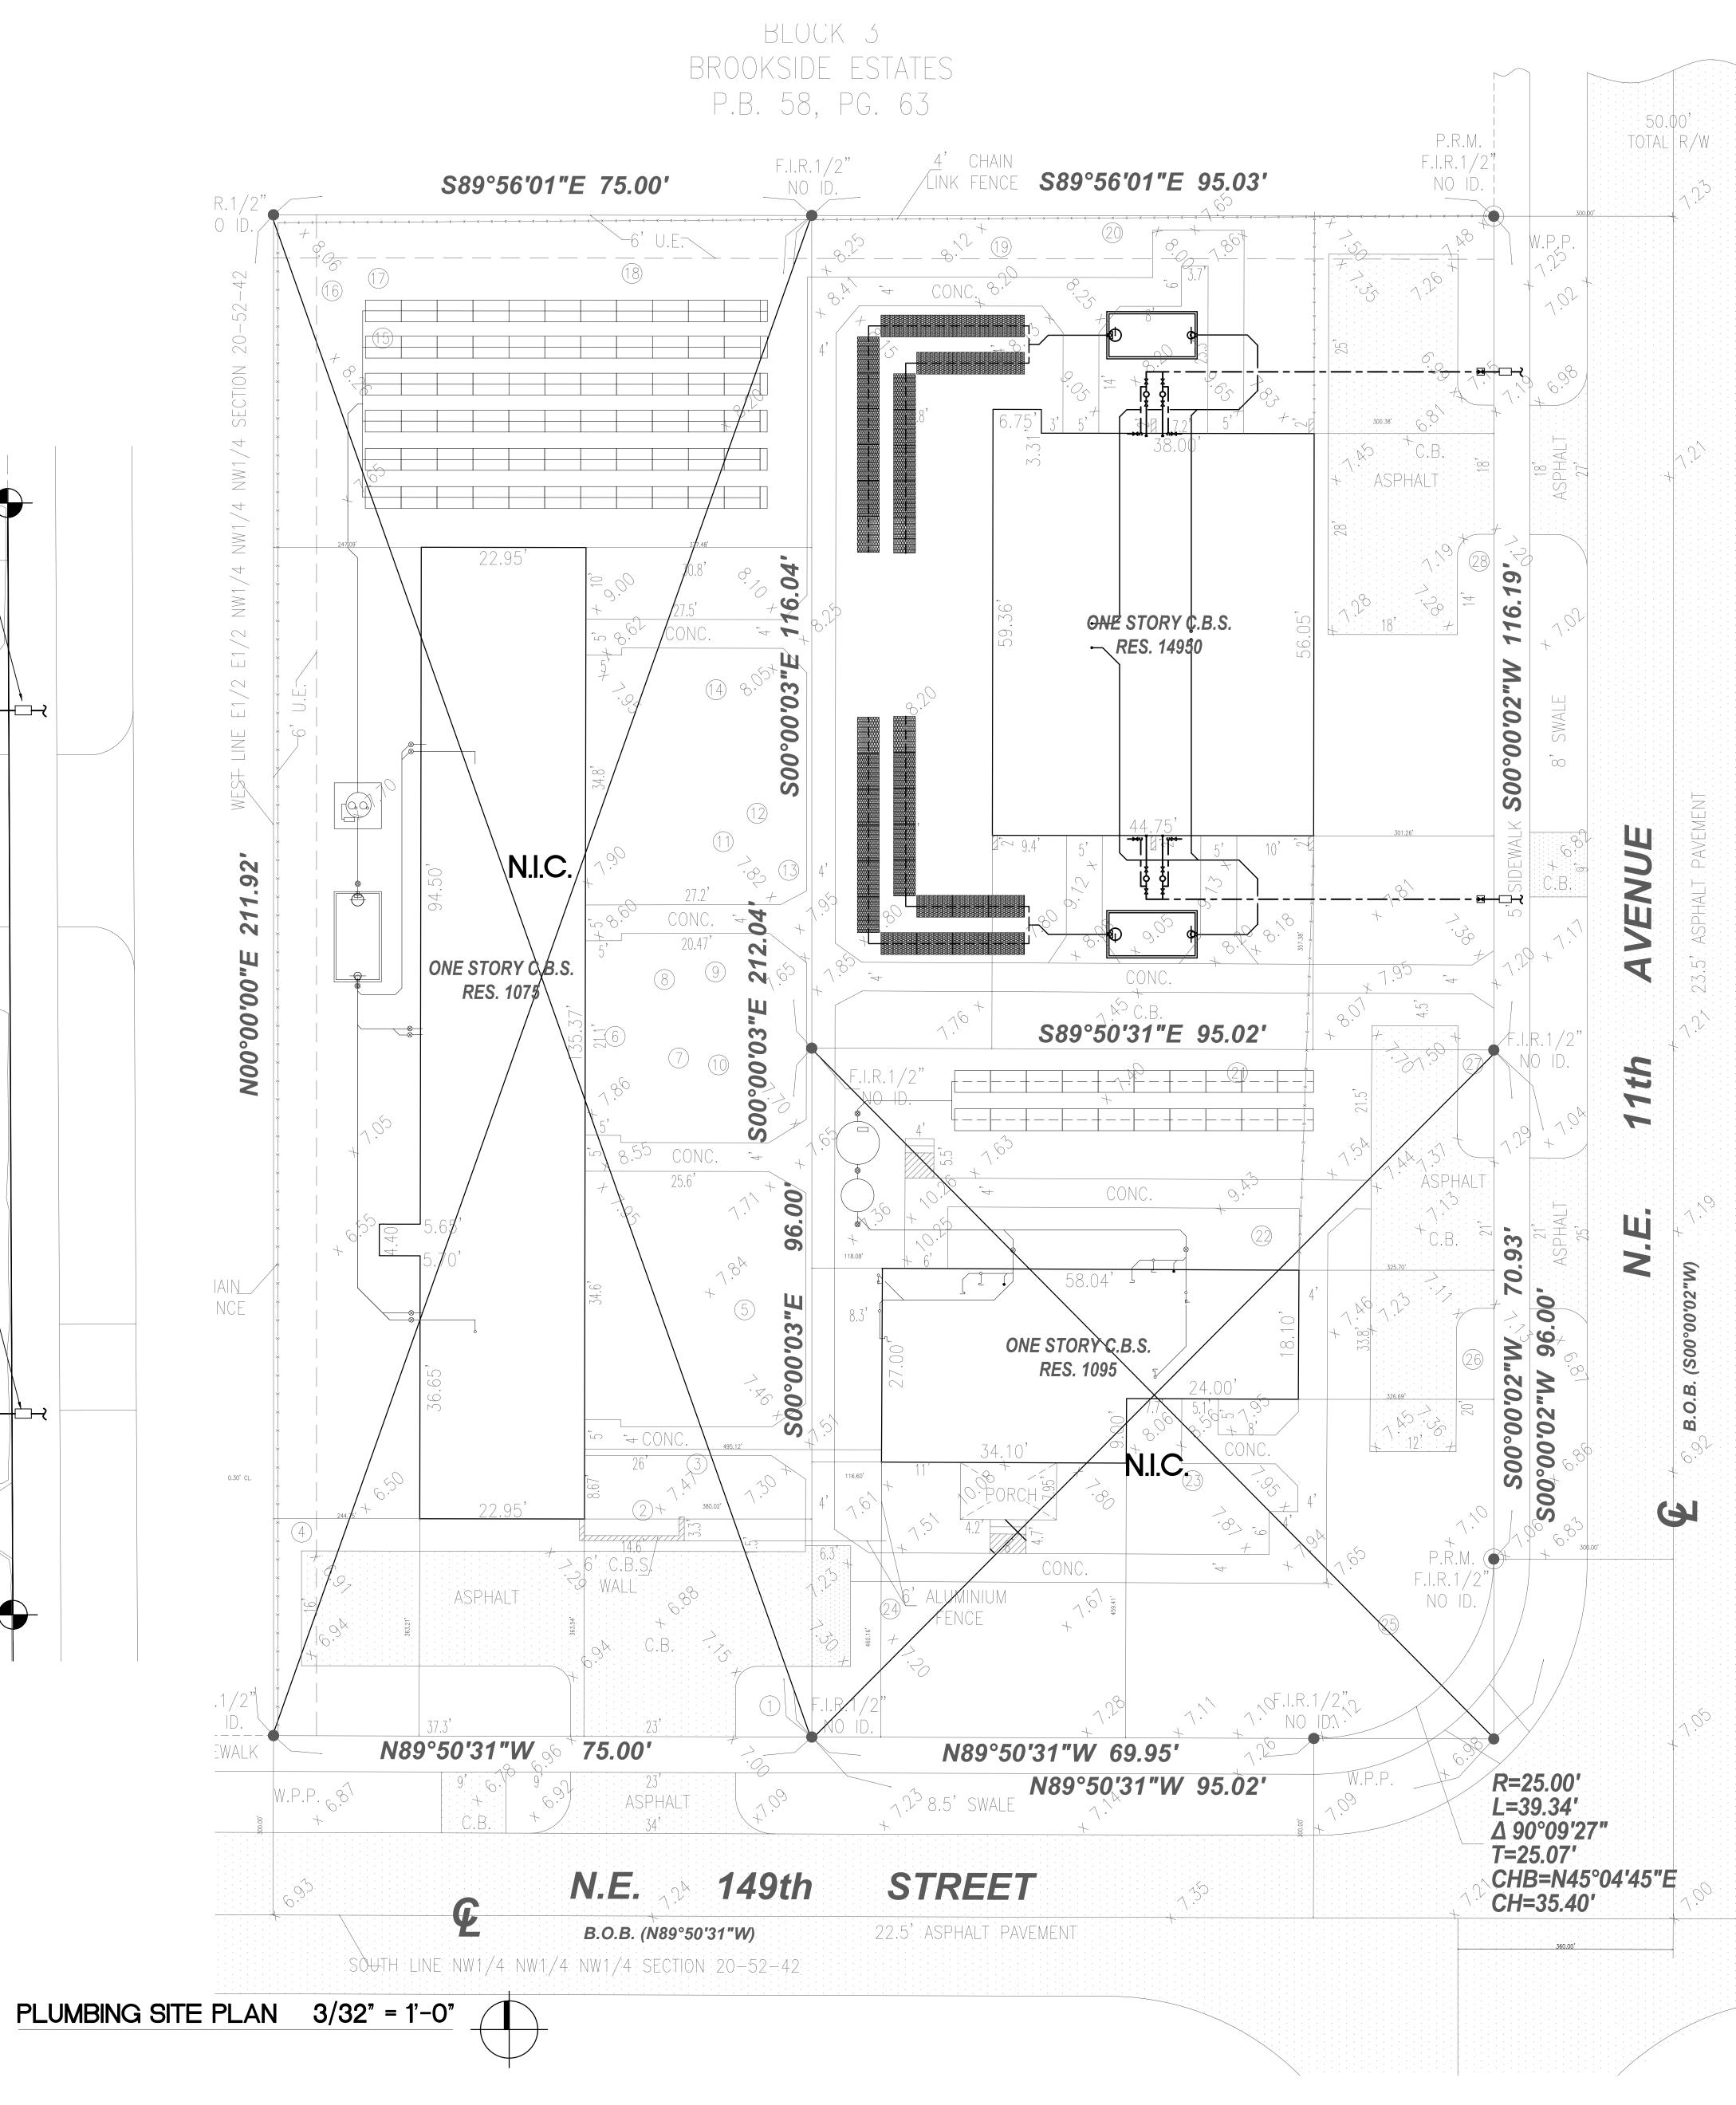
MECHANICAL, ELECTRICAL, PLUMBING ENGINEER: GARTEK ENGINEERING CORP. 7210 SOUTHWEST 39TH TERRACE MIAMI, FLORIDA 33155 TEL: (305) 266-8997 FAX: (305) 264-9496 Certificate of Authorization #3144 www.gartek-engineering.com Gartek Project No. 2867.03 This document and the information it contains is the exclusive property of Engineering and may not be reproduced or used for other purpose other t the specific project for which it was prepared without the explicit consent c


CONSULTANTS:

Gartek Engineering





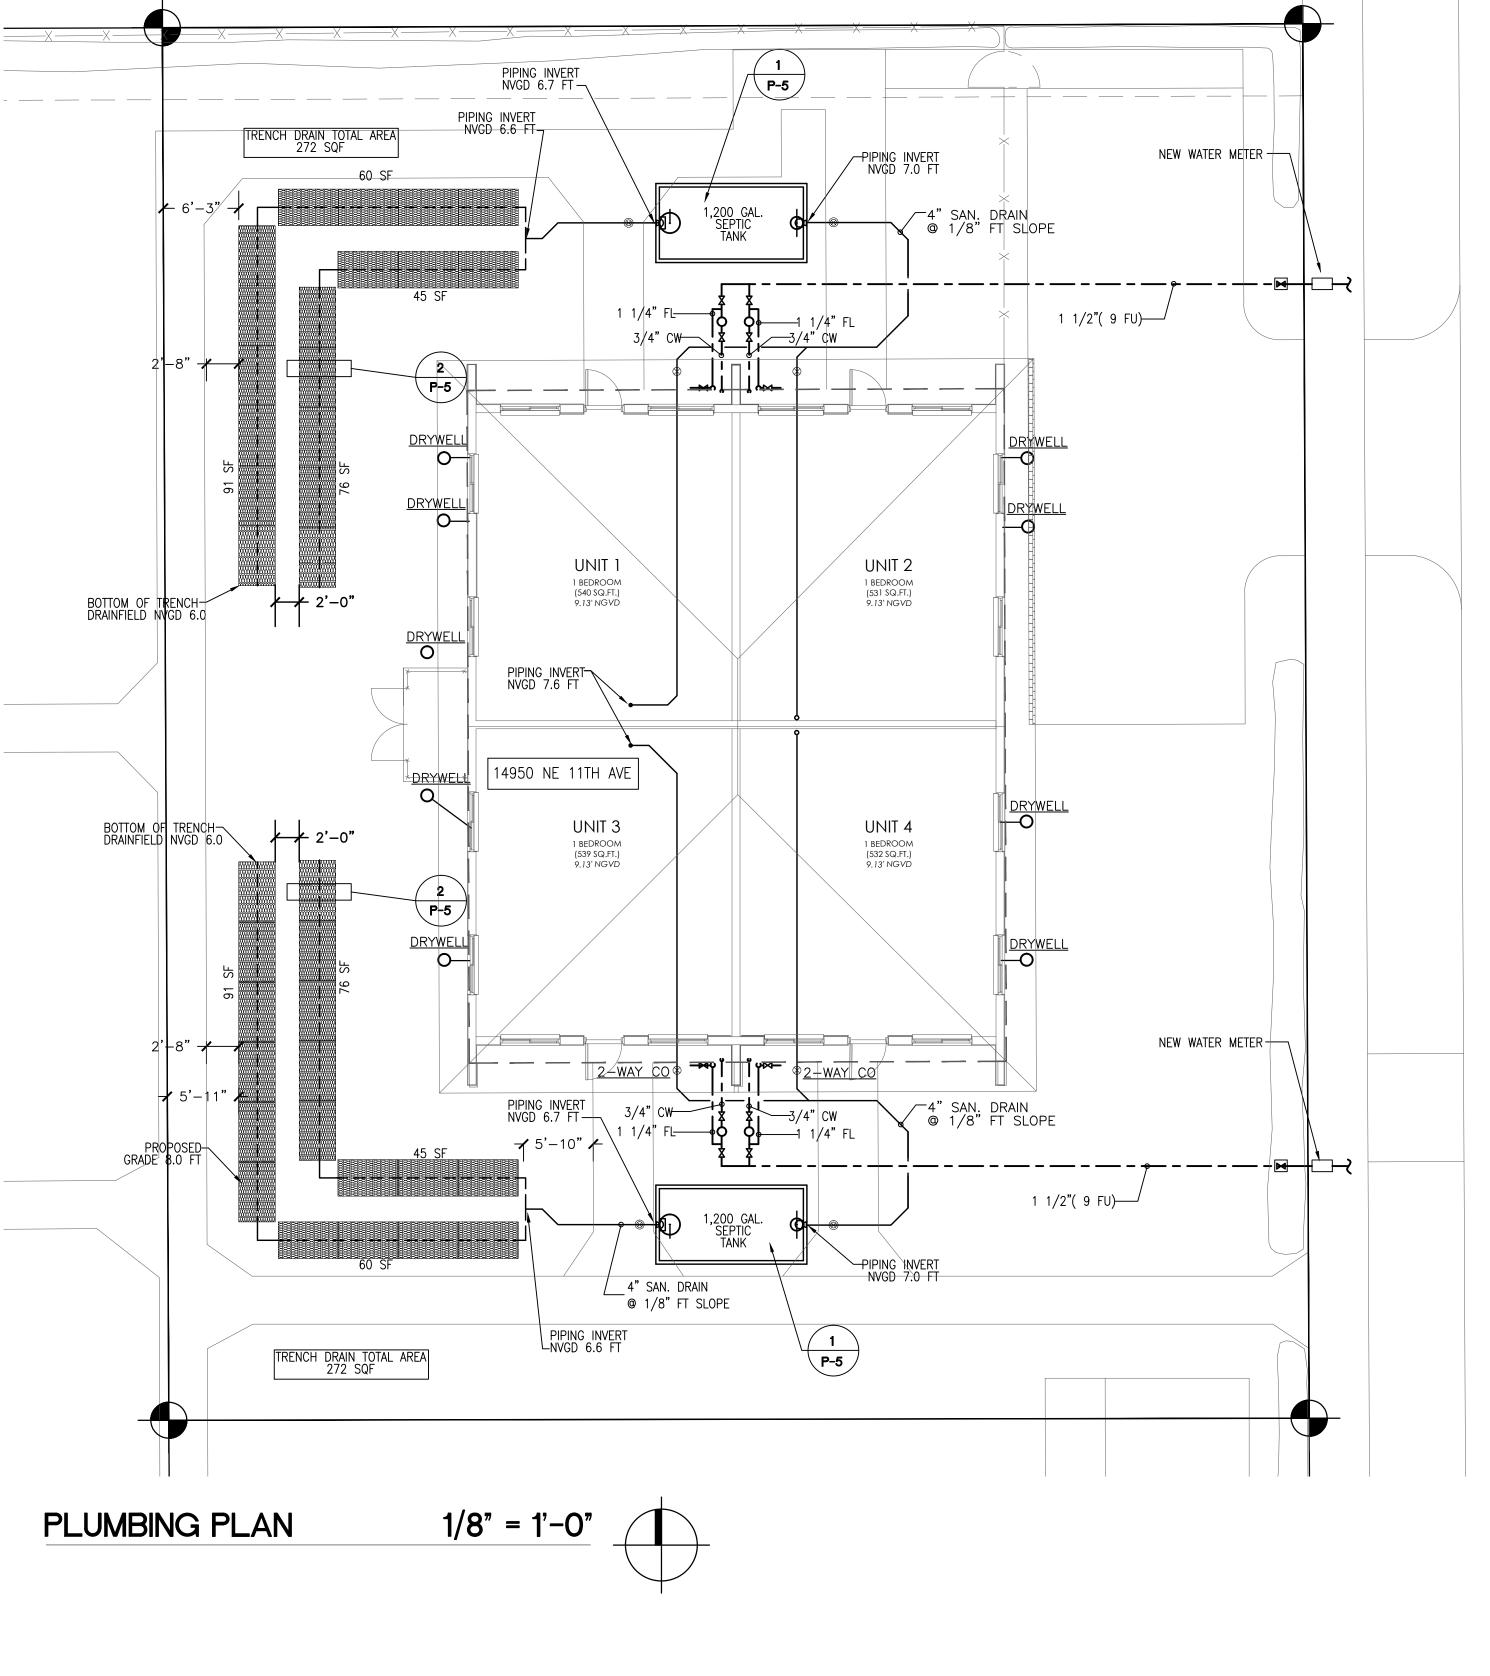

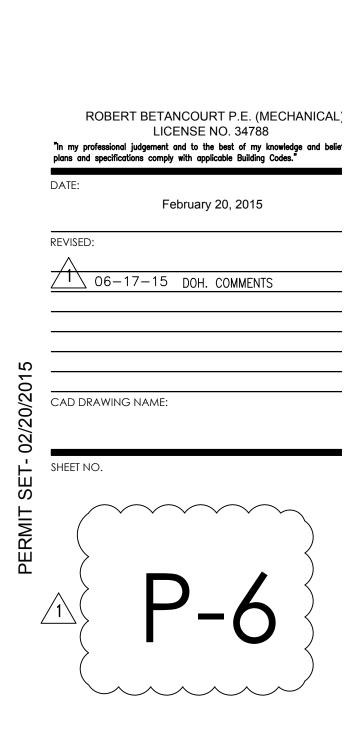

SEPTIC TANK SITE PLUMBING PLAN

MIAMI, FL

DRAWING TITLE

CITY OF MIAMI LIFE QUEST RENOVATIONS 14950 NE 11TH AVEN

MECHANICAL, ELECTRICAL, PLUMBING ENGINEER: GARTEK ENGINEERING CORP. 7210 SOUTHWEST 39TH TERRACE MIAMI, FLORIDA 33155 TEL: (305) 266-8997 FAX: (305) 264-9496 Certificate of Authorization #3144 www.gartek-engineering.com Gartek Project No. 2867.03

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CONSULTANTS:

A L L E G U E ARCHITECTURE PLANN ARCHITECTURE PLANN INTERIOR DESIG CONSTRUCTION MANAGEN 901 PONCE DE LEON BLVD., SUITE CORAL GABLES, FLORIDA 33 (305) 461 4001 (FAX) 461 6002 E-MAIL alleguez@bellsouth AA C O O 2 7 4 6

- 1. THE WORK THAT IS TO BE DONE UNDER THIS HEADING INCLUDES THE FURNISHING OF ALL LABOR, MATERIALS AND EQUIPMENT PERMITS, FEES, INSPECTIONS, TEST, INSURANCE, ETC., REQUIRED FOR THE COMPLETION OF THE AIR CONDITIONING HEATING AND VENTILATION SYSTEMS SHOWN ON DRAWINGS OR LISTED BELOW.
- 2. THE DRAWINGS ARE GENERALLY DIAGRAMMATIC. THEY DO NOT SHOW EVERY BEND, OFF-SET, ELBOW OR OTHER FITTINGS WHICH MAY BE REQUIRED FOR THE INSTALLATION IN THE SPACE ALLOCATED, OR FOR COORDINATION WITH OTHER TRADES.
- 3. DRAWINGS ARE NOT TO BE SCALED. UNLESS SPECIFIC DIMENSIONS ARE SHOWN, THE ARCHITECTURAL AND/OR STRUCTURAL DRAWINGS, AND SITE CONDITIONS SHALL GOVERN EXACT LOCATION OF MECHANICAL EQUIPMENT AND APPURTENANCES.
- 4. INTENT:
- IT IS THE INTENT OF THE PLANS AND GENERAL NOTES TO PROVIDE A COMPLETE AND OPERATING INSTALLATION INCLUDING ALL NECESSARY ITEMS REQUIRED, EVEN THOUGHT ITEMS ARE NOT INDICATED ON THE DRAWINGS OR IN THE NOTES. WORK CONSIDER NECESSARY FOR THE COMPLETION OF THE WORK IN PROPER MANNER NOT SHOWN ON THE PLANS OR NOTES SHALL BE BROUGHT TO THE ATTENTION OF THE ARCHITECT/ENGINEER IN WRITING PRIOR TO BIDS OTHERWISE WORK SHALL NOT BE ADDITIONALLY CHARGED AFTER BID IS AWARDED.
 5. DEFINITIONS:
- A. PROVIDE MEANS TO FURNISH AND INSTALL.
- B.UNDER THIS SECTION MEANS IT IS THE RESPONSIBILITY OF THE CONTRACTOR AND IS TO BE DONE BY AND PAID FOR BY THE CONTRACTOR.
 C. BY THIS SECTION MEANS IT IS THE RESPONSIBILITY OF THE CONTRACTOR AND IS TO BE DONE BY AND PAID FOR BY THE CONTRACTOR.
- 6. INDOOR AIR QUALITY PRECAUTIONS:
- A. THE CONTRACTOR SHALL ALLOW FOR NECESSARY VENTILATION DURING CONSTRUCTION TO AVOID INDOOR AIR POLLUTION.
- B. THE CONTRACTOR SHALL PREPARE WRITTEN DIRECTION BY WHICH THE BUILDING OWNER OR ITS REPRESENTATIVE WILL BE ABLE TO OPERATE THE VENTILATION SYSTEMS AT ITS OPTIMAL LEVEL.
 7. OUTDOOR AIR QUALITY PRECAUTIONS:
- THE CONTRACTOR SHALL ALLOW FOR NECESSARY PRECAUTIONS DURING CONSTRUCTION AND THEREAFTER FOR THE INSTALLATION AND HANDLING OF REFRIGERANTS. THE CONTRACTOR SHALL PREPARE WRITTEN DIRECTIONS BY WHICH THE BUILDING OWNER OR ITS REPRESENTATIVE WILL BE ABLE TO HANDLE REFRIGERANT IN A SAFE AND APPROVED MANNER.
- 8. SUBMIT A COMPLETE "AS-BUILT" RECORD SET IN ELECTRONIC AUTOCAD DWG FILE'S FORM TO ARCHITECT/ ENGINEER FOR REVIEW PRIOR TO FINAL PAYMENT REQUISITION.
- 9. A. HVAC EQUIPMENT, AIR DISTRIBUTION, FANS MATERIALS, ETC., SHALL BE AS LISTED HEREIN AND/OR SHALL BE AS SCHEDULED ON THE DRAWINGS.
 B. MANUFACTURERS USE FOR THE BASIS OF DESIGN ARE LISTED ON THE DRAWING SCHEDULE, ANY OTHER MUST MEET OR EXCEED ALL SPECIFIED REQUIREMENTS. NAMING ACCEPTABLE MANUFACTURERS DOES NOT RELIEVE CONTRACTOR FROM COMPLIANCE WITH ALL DESIGN REQUIREMENTS SHOWN ON DRAWINGS OR LISTED HEREIN.
- 10. CUT ALL OPENINGS, CHASES, TRENCHES, ETC. REQUIRED TO ACCOMMODATE THE WORK UNDER THIS DIVISION AND REPAIR ALL WALLS, ROOF, ETC. DAMAGED BY SUCH CUTTINGS. ALL WORK DONE UNDER THIS HEADING MUST CONFORM IN EVERY RESPECT TO FINISH AND QUALITY OF MATERIALS AND WORKMANSHIP SPECIFIED UNDER APPROPRIATE SECTIONS FOR THIS BUILDING.
- 11. VERIFY ALL VOLTAGES WITH ELECTRICAL CONTRACTOR BEFORE ORDERING ANY EQUIPMENT.
- 12. SUBMIT SHOP DRAWINGS OF ALL MATERIALS, DUCTWORK AND EQUIPMENT FOR REVIEW BY ARCHITECT/ENGINEER PRIOR TO FABRICATION AND/OR INSTALLATION.
- 13. CONTRACTOR SHALL VERIFY SPACE CONDITIONS AND DIMENSIONS AND SHALL COORDINATE WORK WITH ALL OTHER TRADES AT JOB SITE PRIOR TO FABRICATION AND INSTALLATION OF DUCTWORK. THE CONTRACTOR SHALL BE RESPONSIBLE FOR THE FULL COORDINATION OF THIS WORK WITH THAT OF ALL OTHER TRADES.
- 14. OBTAIN FULL INFORMATION REGARDING PECULIARITIES AND LIMITATIONS OF SPACE AVAILABLE FOR INSTALLATION OF THE EQUIPMENT AND MATERIALS UNDER THIS CONTRACT, AND PROVIDE READY ACCESSIBILITY TO DAMPERS, VALVES AND OTHER APPARATUS, INCLUDING ANY PART OF SYSTEM REQUIRED TO BE REACHED FOR MAINTENANCE AND OPERATIONS.

15.DUCTWORK:

- A. TOILET AND DRYER EXHAUST DUCTWORK SHALL BE CONSTRUCTED OF SOLID ZINC COATED GALVANIZED SHEET METAL CONSTRUCTED IN ACCORDANCE WITH THE LATEST A.S.H.R.A.E. GUIDE AND S.M.A.C.N.A. RECOMMENDATIONS.
- D. ALL DUCT SIZES SHOWN ARE CLEAR INSIDE (AIRSIDE) DIMENSIONS.
- E. ALL DUCT ELBOWS SHALL BE FITTED WITH TURNING VANES (EXCEPT DRYER EXHAUST WHICH SHALL BE LONG SMOOTH ROUND ELBOW).16. INSULATION:
- A. PIPING CONDENSATE PIPING PIPING SHALL BE INSULATED WITH 3/4" FIRE RATED FLEXIBLE FOAM INSULATION. FINISH WHERE EXPOSED WITH 2 COATS OF WHITE LATEX PAINT AS PER THE MANUFACTURER'S INSTRUCTION.
- 17. FLAME AND SMOKE RATING: ALL INSULATION PRODUCTS USED INSIDE THE BUILDING SHALL HAVE A MAXIMUM FLAME SPREAD RATING OF 25 AND A MAXIMUM SMOKE GENERATION OF 50 IN ACCORDANCE WITH TESTS OUTLINED IN N.F.P.A. #255.

18. FILTERS:

- A. PROVIDE TWO SETS OF TEMPORARY FIBERGLASS THROWAWAY FILTERS OF THE SAME THICKNESS AS FINAL FILTERS FOR USE DURING CONSTRUCTION.
- B. PROVIDE TWO COMPLETE SETS OF FINAL FILTERS.
- 19. VIBRATION ISOLATORS:

A.CONDENSING UNITS SHALL BE MOUNTED ON 1" THICK NEOPRENE PADS, THRU-BOLTED TO HOT DIPPED GALVANIZED WELDED STEEL ANGLE.
20.CONTROLS:

A. ALL ELECTRIC WIRING AND CONDUIT SHALL BE PROVIDED BY THE ELECTRICAL CONTRACTOR.

B. WIRELESS THERMOSTAT SHALL BE HEAT-COOL PROGRAMMABLE WITH FAN AND SELECTOR SWITCHES.
21. ALL EQUIPMENT AND MATERIALS SHALL BE GUARANTEED FOR THE PERIOD OF ONE YEAR. COMPRESSORS SHALL CARRY 5 YEAR FACTORY GUARANTEE. FURNISH 90 DAYS FREE SERVICE.

22. ALL FAN DRIVES SHALL BE ADJUSTED TO DELIVER THE SPECIFIED CFM AGAINST THE ACTUAL STATIC PRESSURE OF THE INSTALLATION.

23. ALL WORK SHALL BE COORDINATED WITH THE WORK OF OTHER TRADES TO AVOID INTERFERENCE WITH PROGRESS OF CONSTRUCTION AND IN STRICT COMPLIANCE WITH ALL APPLICABLE CODES AND STANDARDS.

24. ALL OUTSIDE EQUIPMENT SHALL BE SECURED TO WITHSTAND 170 MPH HURRICANE FORCE WINDS.26. TESTING:

A. BALANCE AIR SYSTEM TO DELIVER SPECIFIED QUANTITIES AT EACH OUTLET WITHIN 10% USING
A.A.B.C. PROCEDURES AND TESTS. SUBMIT AIR BALANCE TEST RESULTS FOR REVIEW PRIOR TO FINAL INSPECTION AND ACCEPTANCE.
B. SUBMIT SHOP DRAWINGS OF ALL MATERIALS, DUCTWORK AND EQUIPMENT FOR REVIEW PRIOR INSTALLATION AND/OR FABRICATION.
C. ALL WORK SHALL BE DONE IN ACCORDANCE WITH THE LATEST EDITION OF THE STANDARD BUILDING CODE NFPA 90A, 90B AND ALL APPLICABLE LOCAL CODES AND ORDINANCES.
E. CONTRACTOR SHALL BE RESPONSIBLE TO TEST AND BALANCE THE SYSTEM TO ACHIEVE RATES AS SHOWN ON PLANS AND SCHEDULES. TEST/BALANCE RESULTS SHALL BE SUBMITTED TO ARCHITECT/ENGINEER FOR REVIEW PRIOR TO FINAL PAYMENT REQUISITION.

26. FANS (COOK IS THE BASIS OF DESIGN)

A. PROVIDE FANS AS SCHEDULED ON DRAWINGS

B. INSTALLATION

1. INSTALL FANS IN ACCORDANCE WITH MANUFACTURER'S RECOMMENDATIONS.

2. LOCATE EXHAUST FANS A MINIMUM OF 10'-0" (HORIZONTAL DISTANCE) AWAY FROM ANY OUTSIDE AIR INTAKE, OPERABLE WINDOW AND/OR DOOR.

3. PROVIDE CONTROL LOW VOLTAGE TRANSFORMERS, TEN MINUTE TIME-OFF DELAY RELAYS AND BACK DRAFT DAMPERS, SEAL ALL STRUCTURAL ROOF AND WALL OPENINGS AIR AND WATER TIGHT.
30. THRU THE WALL AIR CONDITIONERS (FRIEDRICH IS THE BASIS OF DESIGN)

- UNITS SHALL BE PROVIDED WITH: A. SEA COAST PROTECTION. (10,000 HOURS MINIMUM)
- B. WIRELESS REMOTE CONTROL, 3 SPEED FAN CONTROL AND PROGRAMMABLE TIMER, C. OUTSIDE AIR DUCT WITH DAMPER SET @ 30 CFM.
- D. INSECT BARRIER, WASHABLE ANTIMICROBIAL AIR FILTER. E. STEEL INNER WALL AND EXTRA DENSE INSULATION AND VIBRATION ISOLATION.
- F. INSTALL WALL SLEEVE SLOPED PER MFGR RECOMMENDATIONS. G. ENTRY-GARD ANTI-INTRUSTION PROTECTION.
- H. PROVIDE 5 YEARS WARRANTY ON COMPRESSORS BY MANUFACTURER AND ONE YEAR WARRANTY ON PARTS AND LABOR.
- I. SECURE A/C UNITS ON CONCRETE WALL TO WITHSTAND 170 MPH HURRICANE FORCE WINDS

AIR C	ONDITIONING	LEGEND
SYMBOL	DESCRIPTION	
A/C	THRU THE WALL AIR CONI	DITION UNIT
BTM.	BOTTOM	
COND.	CONDENSATE	
CONC.	CONCRETE	
CFM	CUBIC FEET PER MINUTE	
E.F.	EXHAUST FAN	
F.L.A.	FULL LOAD AMPS	
F.P.M.	FEET PER MINUTE	
H.P.	HORSEPOWER	
H.R.	HOUR	
IN.	INCH	
K.W.	KILOWATT	
LBS.	POUNDS	
MAX.	MAXIMUM	(
MVD	MANUAL VOLUME DAMPER	(OPPOSED BLADE)
NO.	NUMBER	
0/A	OUTSIDE AIR	
RPM.	REVOLUTIONS PER MINUTE	
R/A	RETURN AIR	
REF.	REFRIGERANT	
S/A	SUPPLY AIR	
TEMP.	TEMPERATURE	
"A"	AIR DISTRIBUTION DESIGNA	ATION
T	PROGRAMMABLE THERMOS	ТАТ
\square	EXHAUST OR RETURN AIR	DUCT SECTION
	OPPOSED BLADE MANUAL	· · · · · ·
-∕∕→ U.C.	1" UNDER CUT DOOR (AL AND BATHROOMS)	L BEDROOMS


HVAC DESIGN REQUIRES:	YES	NO
DUCT SMOKE DETECTOR		\times
FIRE DAMPER(S)		>>
SMOKE DAMPER(S)		\ge
FIRE RATED ENCLOSURE		\ge
FIRE RATED ROOF/FLOOR CEILING ASSEMBLY		$\left\langle \right\rangle$
FIRE STOPPING		\searrow
SMOKE CONTROL SUPPLY		\ge

BUILDING DATA (SEE ARCH DW	/GS)
WALL R VALUE	R-5
GLASS (ARGON/LOW E) U VALUE	U-0.97
GLASS (ARGON/LOW E) SHGC.	SHGC-0.37
ROOF R VALUE	R-30
NOTE:	


1. ALL R AND U VALUES ARE AS PROVIDED TO THIS ENGINEER BY THE ARCHITECT.

V	ENTILATION FAN SCHEDU	LE
UN	IT DESIGNATION	EF-1
AR	EA SERVED	SEE PLAN
0P	ERATING WEIGHT, LBS.	18
LO	CATION	CEILING
Fa	N TYPE	CEILING MNTD.
	TOTAL AIR, CFM DRIVE TYPE	50 DIRECT
	FAN WHEEL TYPE	CENTRIFUGAL
	FAN TIP SPEED, FPM MAX. FAN SPEED, RPM	1125
AN	TOTAL STATIC PRESSURE, IN OF H20	0.125
	FAN MOTOR WATTS	29 W
	FAN MOTOR STARTER TYPE STARTER FURNISHED BY	CONTRACTOR
	ELECTRICAL SERVICE AVAILABLE SONES	120/1ø/60
DE	SIGN MANUFACTURER	2.4 COOK – GEMINI
	SIGN MFGR. MODEL NUMBER	LITTLE GEM-I
	SERVICE SWITCH	YES
ľ	SMOKE DETECTORS	NO
<u>ה</u>	FIRE DAMPER	NO
CESSORIES	CONSTRUCTION	GALVANIZED STEEL
<u>ا</u> بَدِ	MULTIBLADE BACKDRAFT DAMPER	YES
	BIRDSCREEN	YES
	SOLID STATE SPEED CONTROL	NO
	THERMOSTAT CONTROL	NO
	FACTORY FABRICATED CURB MODEL No.	NO
	10 MIN. TIME OFF DELAY RELAY	YES

NOTES: 1– PROVIDE ALUMINUM EXHAUST GRILLE (TYP.) 2– ACCEPTABLE MANUFACTURERS COOK, GREENHECK OR PENN 3– EXHAUST FANS SHALL BE INTERLOCKED WITH CORRESPONDING LIGHT SWITCH (TYP.)

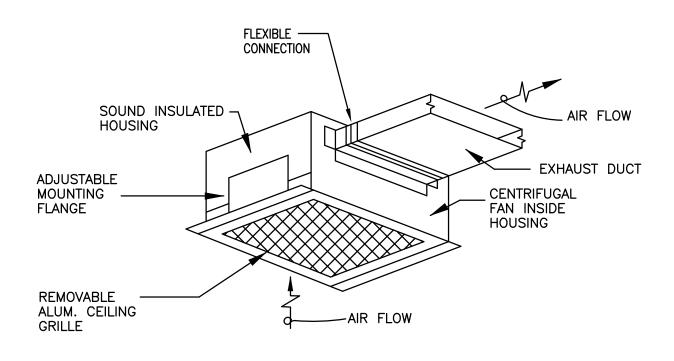

TYPICAL CEILING TYPE EXHAUST FAN DETAIL N.T.S.

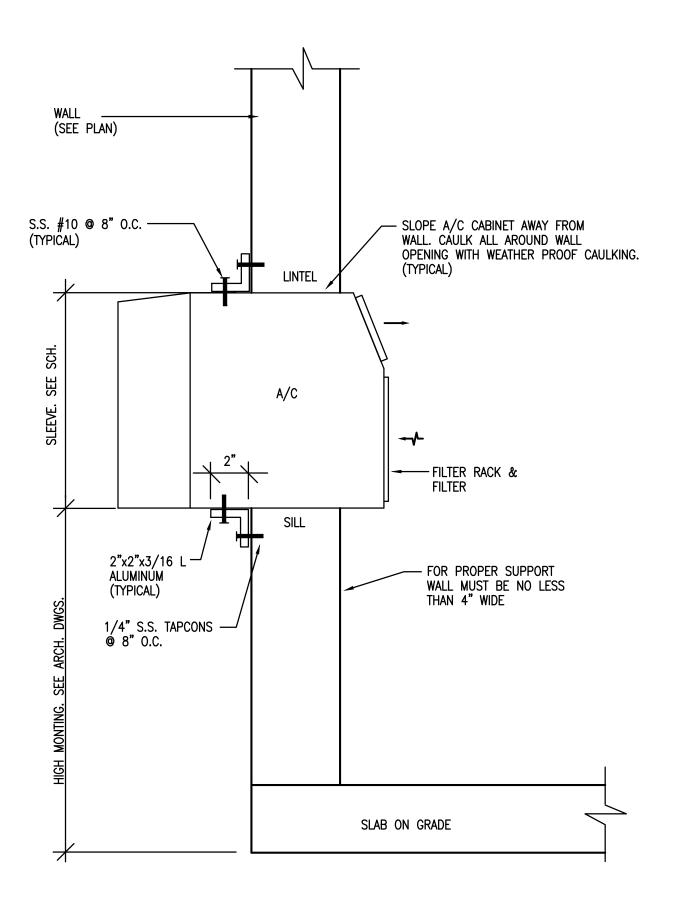

WINDOW TYPE UNIT MOUNTING DETAIL

NOTE:

INSTALL PER MANUFACTURER RECOMMENDATION
 CAULK / SEAL ALL AROUND THE SLEEVE (PENETRATION).
 PROVIDE ENTRY-GARD ANTI INSTRUCTION PROTECTION.

ROOM TYPE A/C UN	NIT SCHED	ULE
UNIT DESIGNATION	A/C-14950-1B A/C-14950-2B A/C-14950-3B A/C-14950-4B	A/C-14950-1A A/C-14950-2A A/C-14950-3A A/C-14950-4A
MOUNTING TYPE	THRU THE WALL	THRU THE WALL
AREA SERVED	SEE PLAN	SEE PLAN
DESIGN MANUFACTURER	FRIEDRICH	FRIEDRICH
UNIT TYPE	ELECTRIC HEATER	HEAT PUMP
DESIGN MFG. MODEL NO.	EQ08N11	YS12N33
AIR FLOW (CFM)	175	265
OUTSIDE AIR FLOW (CFM)	30	30
COOLONG CAPACITY BTU/HR.	7,600	11,500
AIR ENTERING EVAPORATOR	80/67	80/67
AIR LIVING EVAPORATOR ⁰ F DB/WB	56/-	56/-
ELECTRIC HEATING CAPACITY BTU/HR	4,000	-
HEAT PUMP CAPACITY BTU/HR	_	9,400
COP / HSPF	-	2.4/8.2
ELECTRICAL SERVICE AVAILABLE	115-1-60	230-1-60
UNIT TOTAL AMPS, F.L. COOL/HEAT	6.9 / 11.2	5.4/5.8
ENERGY EFFICIENCE RATIO (E.E.R.) MIN.	10.5	10.5
WEIGHT LBS.	84 LBS	136 LBS
SLEEVE	YES	YES
REFRIGERANT	R-410A	R-410A
DIMENSIONS (HxWxD)	-	16x26x29

<u>NOTES:</u>

1. ALL A/C UNITS SHALL BE PROVIDED WITH OUTSIDE AIR DAMPER, INSECT BARRIER, WASHABLE ANTIMICROBIAL AIR FILET, STEEL INNER WALL, EXTRA DENSE INSULATION AND VIBRATION ISOLATION FILTEN.

2. UNITS SHALL BE PROVIDED WITH 3 SPEED FAN CONTROL, PROGRAMMABLE TIMER AND WIRELESS REMOTE CONTROL.

3. ALL A/C UNIT SHALL BE PROVIDED WITH ENTRYGARD ANTI-INTRUSTION PROTECTION.



	ROBERT BETANCOURT P.E. (MECHANICAL) LICENSE NO. 34788 "In my professional judgement and to the best of my knowledge and belief, these plans and specifications comply with applicable Building Codes."
	DATE: SEPTEMBER 15, 2014
	REVISED:
SET	
D SI	CAD DRAWING NAME:
BIL	
	Sheet NO.

MECHANICAL NOTES 8 DETAILS

RENOVATIONS 14950 NE 11TH AVENI

MIAMI, FL

DRAWING TITLE:

CITY OF MIAMI LIFE QUEST RENOVATIONS 14950 NE 11TH AVENUE

MECHANICAL, ELECTRICAL, PLUMBING ENGINEER: GARTEK ENGINEERING CORP. 7210 SOUTHWEST 39TH TERRACE MIAMI, FLORIDA 33155 TEL: (305) 266-8997 FAX: (305) 264-9496 Certificate of Authorization #3144 www.gartek-engineering.com Gartek Project No. 2867 This document and the information it contains is the exclusive property of Gartek Engineering and may not be reproduced or used for other purpose other than the specific project for which it was prepared without the explicit consent of Cartek Engineering. STRUCTURAL ENGINEER:

BLISS & NYITRAY, INC.


800 DOUGLAS ROAD, SUITE 300

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CONSULTANTS:

A L L E G U E Z A L L E G U E Z ARCHITECTURE, INC. A R C H I T E C T U R E PLANNING INTERIOR DESIGN CONSTRUCTION MANAGEMENT SOI PONCE DE LEON BLVD., SUITE 202 CORAL GABLES, FLORIDA 33134 tel: 305.461.4001 fax: 305.461.6002 www.alleguezarchitecture.com



MECHANICAL FLOOR PLAN	1/4" = 1'-0"	
14950 NE 11 AVE.		$\mathbf{\nabla}$

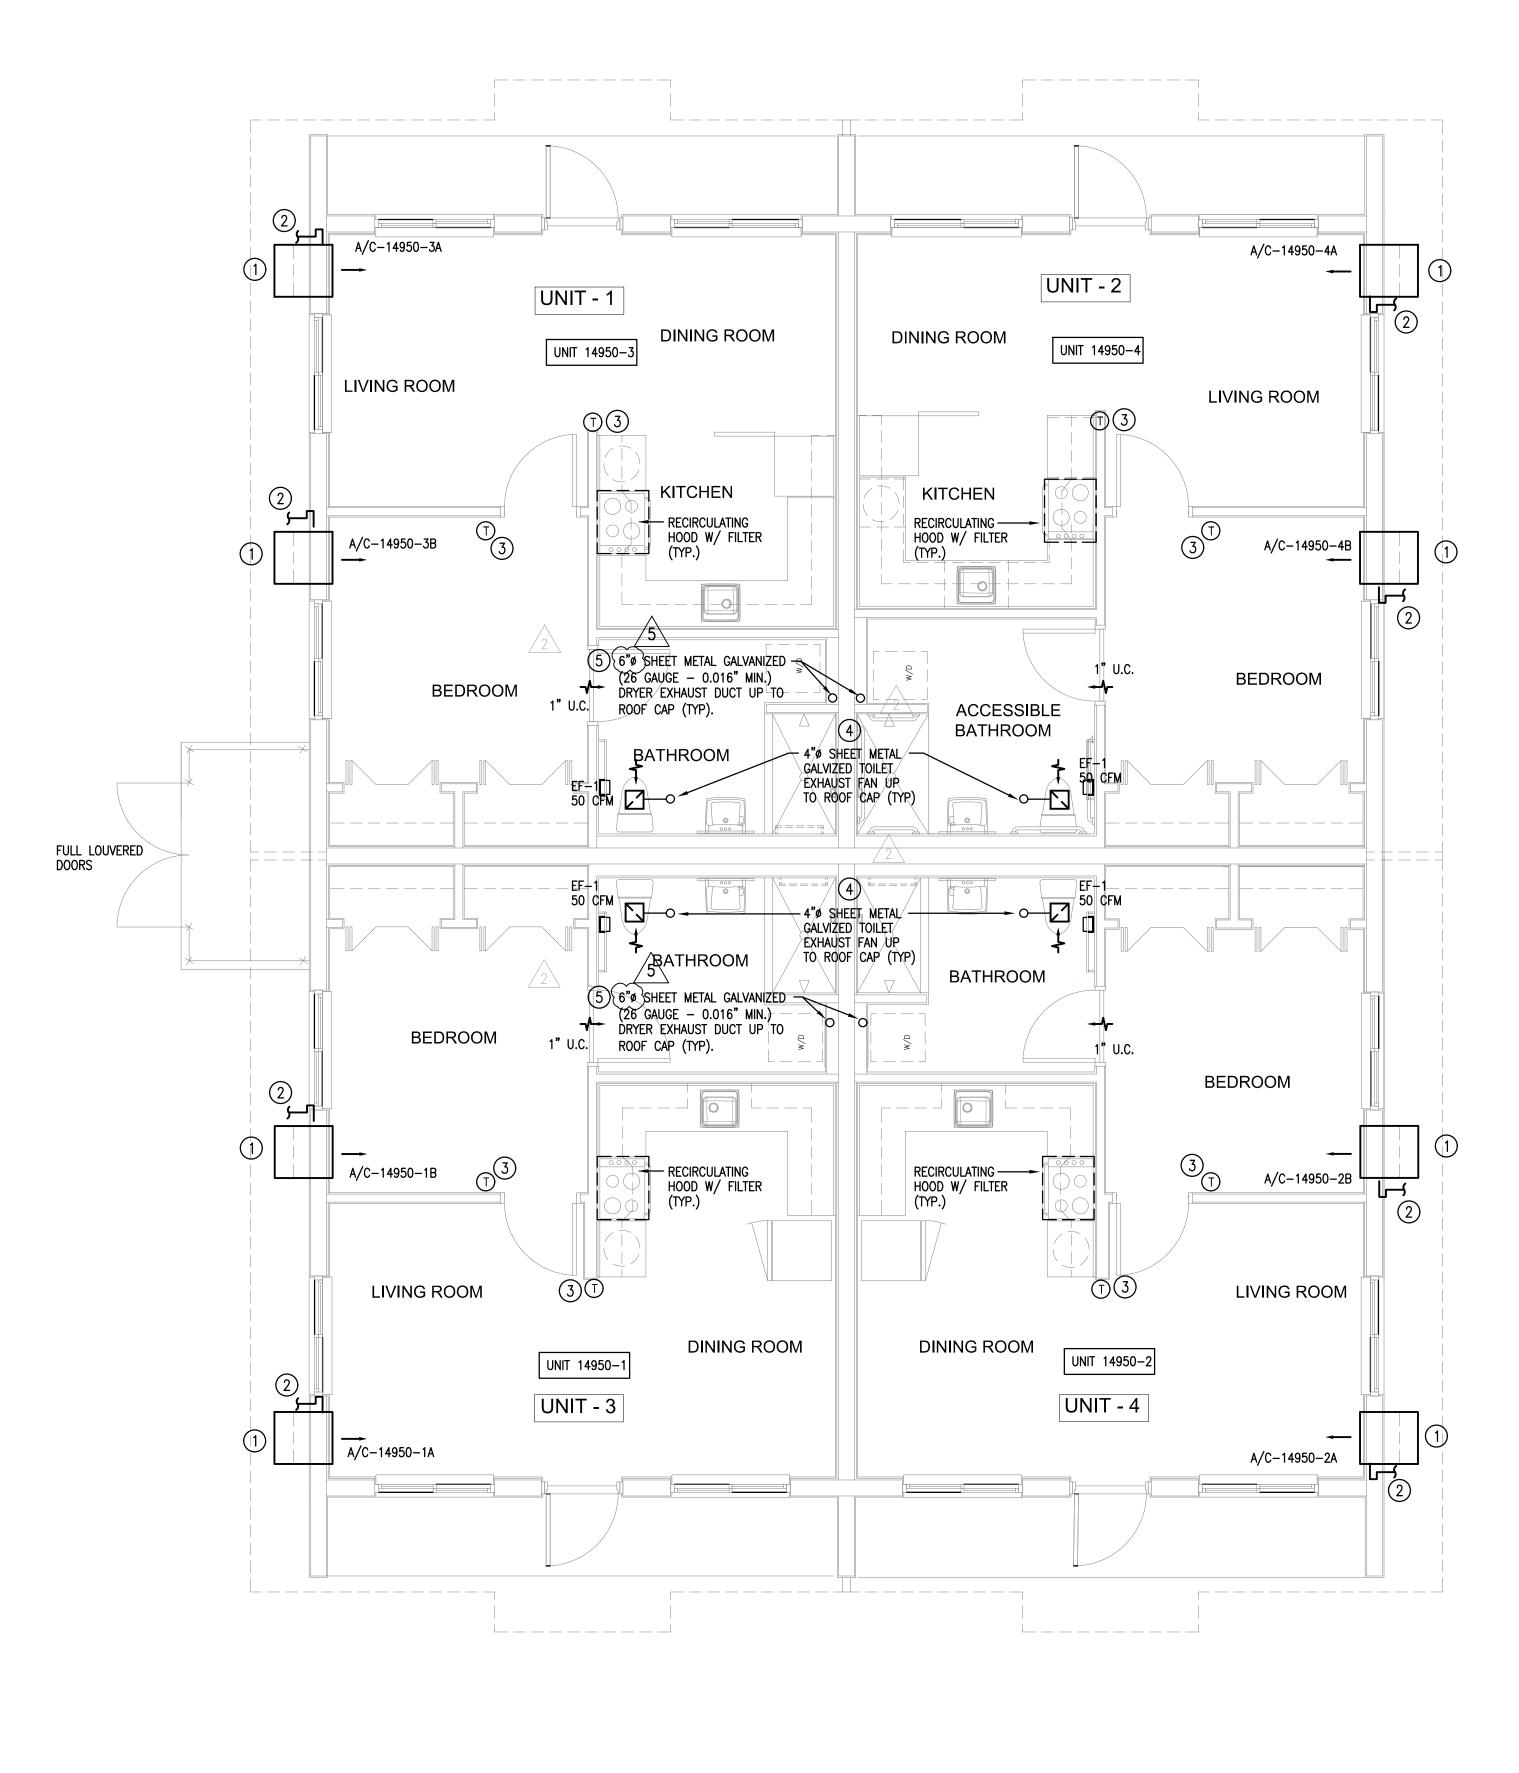NOTE: 1. THERMOSTAT SHALL BE INSTALLED AT MAX. 48" A.F.F. ON ALL ADA UNITS.

- 5 ALL DRYER EXHAUST DUCT SHALL BE PROVIDED WITH SHEET METAL GALVANIZED BACKDRAFT DAMPER. (TYPICAL)
- (4) BATHROOM EXHAUST SYSTEM ROOF CAP SHALL BE PROVIDED WITH A CORROSION RESISTANT SCREEN. (TYPICAL)
- (3) WIRELESS REMOTE THERMOSTAT, VERIFY EXACT LOCATION IN FIELD. (TYPICAL)
- 2 2"Ø INSULATED CD LINE W/ TRAP. FOR CONT. SEE PLUMBING DWGS. (TYPICAL)
- 1 NEW THRU THE WALL A/C UNIT HIGH MOUNTING. SEE ARCH DWGS. FOR EXACT LOCATION AND DWG M-1 FOR MOUNTING DETAIL. (TYPICAL)
- <u>CODED NOTES:</u> NEW THRU THE WALL A/C UNIT HIGH MOUNTING. SEE ARCH DWGS FOR EXACT LOCATION AND DWG M-1 FOR MOUNTING





DATE:

DATE:	SEPTEMBER 15, 2014
REVISED:	:
	10-20-13 BACKGROUND CHANGE
<u>/2</u> <u>/5</u>	12-13-13 BLDG. DEPT. COMMENTS 01-16-17 PLAN UPDATE
CAD DR.	AWING NAME:
SHEET NO	Э.

ROBERT BETANCOURT P.E. (MECHANICAL)

LICENSE NO. 34788 "In my professional judgement and to the best of my knowledge and belief, these plans and specifications comply with applicable Building Codes."

MECHANICAL FLOOR PLAN

DRAWING TITLE:

MIAMI, FL

CITY OF MIAMI LIFE QUEST RENOVATIONS 14950 NE 11TH AVENUE

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MECHANICAL, ELECTRICAL, PLUMBING ENGINEER:

GARTEK ENGINEERING CORP.

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Gartek Project No. 2867


7210 SOUTHWEST 39TH TERRACE

MIAMI, FLORIDA 33155

CONSULTANTS:

A L L E G U E Z A L L E G U E Z ARCHITECTURE, INC. A R C H I T E C T U R E PLANNING INTERIOR DESIGN CONSTRUCTION MANAGEMENT DI PONCE DE LEON BLVD., SUITE 202 CORAL GABLES, FLORIDA 33134 (E: 305.461.4001 fax: 305.461.6002 WWW.alleguezarchitecture.com

LUMIN	AIRE S	CHEDULE					
Symbol	Label	Catalog Number	Description	Lamp	Lumens	LLF	Watts
•	S1	LITHONIA LIGHTING KAD 250M SR3 POLE MTD. 20' A.G.	Area Luminaire, 250W MH, High Performance SR3 Reflector, Full Cutoff MEETS THE 'NIGHTTIME FRIENDLY' CRITERIA	ONE 250-WATT CLEAR BT-28 METAL HALIDE, HORIZONTAL POSITION.	22500	0.75	288

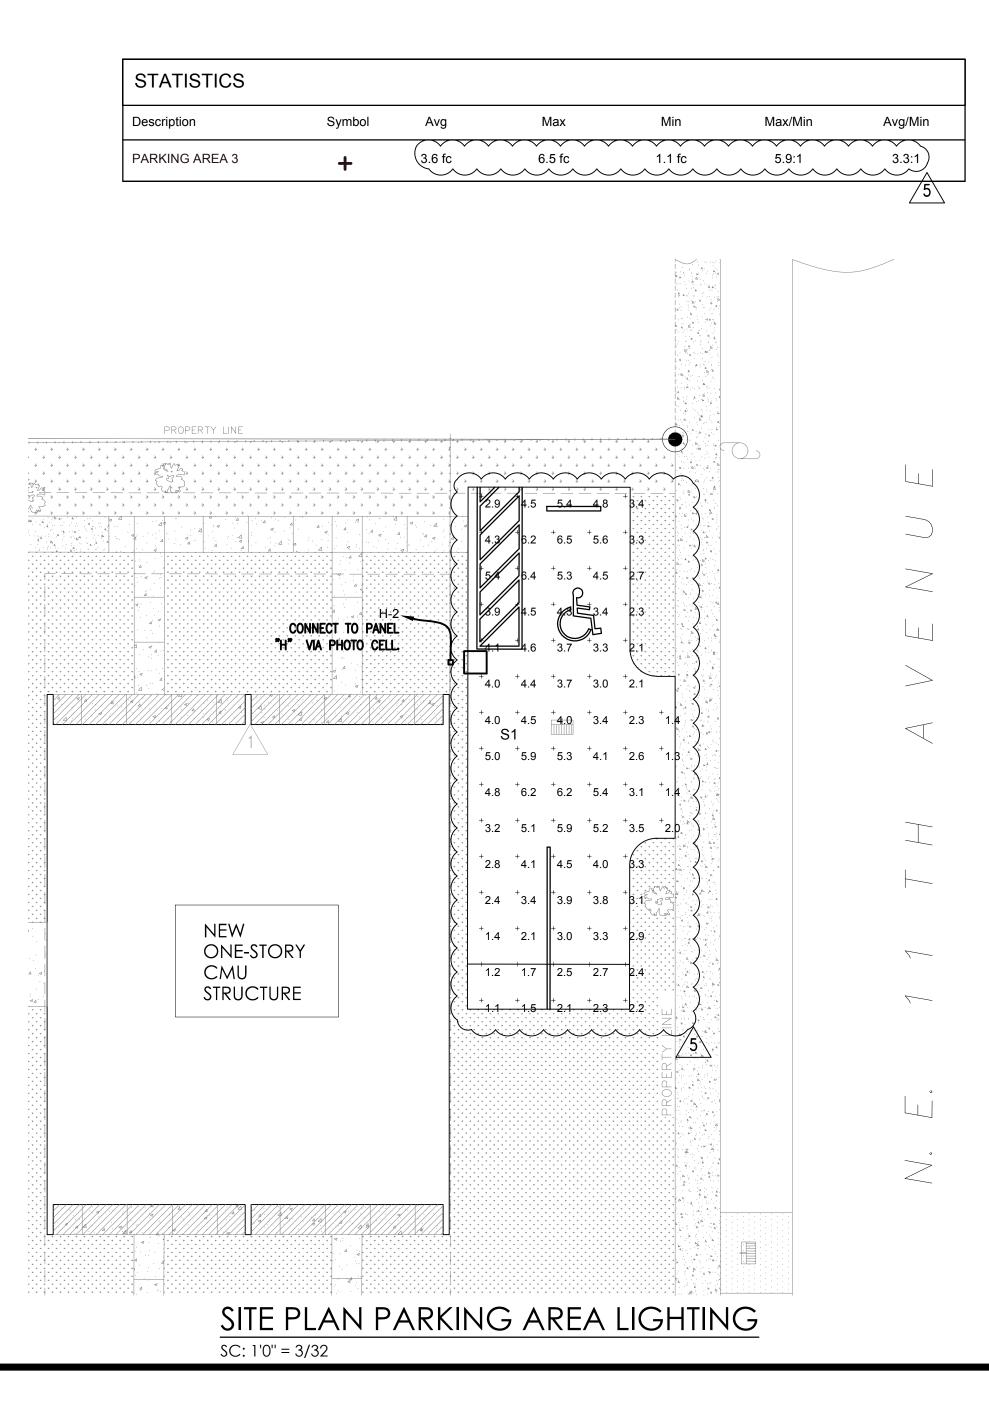

I. GENERAL REQUIREMENTS

A. DRAWINGS. THE DRAWINGS ARE TO BE CONSIDERED DIAGRAMMATIC, NOT NECESSARILY SHOWING IN DETAIL OR TO SCALE ALL OF THE MINOR ITEMS. UNLESS SPECIFIC DIMENSIONS ARE SHOWN, THE STRUCTURAL, ARCHITECTURAL, AND SITE CONDITIONS SHALL GOVERN THE EXACT LOCATIONS. CONTRACTOR SHALL FOLLOW DRAWINGS IN LAYING OUT WORK, CHECK DRAWINGS F ALL TRADES TO VERIFY SPACES IN WHICH WORK WILL BE INSTALLED. WHERE HEADROOM OF ALL INVITED STOLEN IN WHICH WORK WILL BE INSTALLED. WHERE HEADROOM OR SPACE CONDITIONS APPEAR INADEQUATE, CONTRACTOR SHALL, WITHOUT EXTRA CHARGE, MAKE FIELD MODIFICATION IN LAYOUT AS NEEDED TO PREVENT CONFLICT WITH WORK OF VARIOUS TRADES OR FOR PROPER EXECUTION OF THE WORK. SITE CONDITIONS SHALL GOVERN THE EXACT LOCATION OF ALL ELECTRICAL EQUIPMENT, DEVICES, WIRING, CONDUIT,

ONE COMPLETE SET OF DRAWINGS AND SPECIFICATIONS SHALL BE KEPT ON FILE AT THE SITE FOR THE SOLE USE OF MARKING AS-BUILT DATA. ALL CHANGES SHALL BE MARKED IN RED ON THESE PRINTS AS WORK PROGRESSES. PRIOR TO EACH REQUISITION FOR PAYMENT, AS-BUILT PRINTS SHALL BE BROUGHT UP TO DATE FOR ACCEPTANCE BY OWNER'S REPRESENTATIVE. THE COMPLETED SET OF AS-BUILT PRINTS SHALL BE DELIVERED TO THE ARCHITECT/ENGINEER PRIOR TO FINAL PAYMENT FOR INCORPORATION ONTO ORIGINALS.

RISERS ARE DIAGRAMMATIC AND DON'T INTEND TO SHOW EVERY BEND REQUIRED FOR THE INSTALLATION. **B. COORDINATION.** CONTRACTOR WILL BE REQUIRED TO FURNISH, INSTALL AND/OR CONNECT WITH APPROPRIATE SERVICES ALL ELECTRICAL ITEMS SHOWN ON ANY OF THE ARCHITECTURAL, PLUMBING, AIR CONDITIONING SPRINKLER, INTERIOR DESIGN AND ELECTRICAL DRAWINGS WITHOUT ADDITIONAL EXPENSE TO THE OWNER. IF DISCREPANCIES, CONFLICTS, INTERFERENCES OR OMISSIONS OCCUR BETWEEN DRAWINGS, NOTIFY IN WRITING THE

ARCHITECT/ENGINEER IN AMPLE TIME TO PERMIT REVISIONS BEFORE THE BIDS ARE

ELECTRICAL CONTRACTOR SHALL COORDINATE THE REQUIREMENTS OF PLUG AND CHORD TYPE EQUIPMENT WITH MANUFACTURER AND IS REQUIRED TO PROVIDE ELECTRICAL OUTLETS THAT WILL ACCEPT MANUFACTURER'S SUPPLIED PLUGS. SEE MECHANICAL DRAWINGS FOR ELECTRICAL REQUIREMENTS AND LOCATION OF A/C UNITS AND ALL OTHER MECHANICAL EQUIPMENT (SOLENOIDS, VAV'S, THERMOSTATS, PUMPS, FANS, SMOKE DETECTORS, DUCT HEATERS, ETC.) THE CONTRACTOR SHALL PROVIDE ALL BRANCH CIRCUIT AND CONTROL WIRING AS INDICATED OR REQUIRED AND IN CONFORMANCE WITH N.E.C.

ARTICLE 440 AND MANUFACTURE'S RECOMMENDATIONS. ALL PENETRATIONS SHALL BE MADE WEATHERPROOF DURING CONSTRUCTION AND AFTER FINAL INSTALLATION. A/C EQUIPMENT WIRING, BREAKERS, AND FUSES ARE BASED ON A/C EQUIPMENT SPECIFIED ON CONTRACT DRAWINGS. CONTRACTOR IS RESPONSIBLE FOR PROVIDING ALL WIRING, AND OVERCURRENT PROTECTION REQUIREMENTS IF EQUIPMENT USED IS DIFFERENT FROM THAT SPECIFIED. CONTRACTOR SHALL MAKE THESE CHANGES AT NO ADDITIONAL COST TO THE

C. PERMITS. THE CONTRACTOR SHALL SECURE AND PAY FOR ALL PERMITS, STATE SALES TAX, FEDERAL EXCISE TAX, ROYALTIES AND OTHER TAXES OR FEES AS REQUIRED FOR INSTALLATION OF A COMPLETE SYSTEM AS OUTLINED HEREIN AND AS SHOWN ON THE PLANS. THE CONTRACTOR SHALL SECURE ALL NECESSARY LICENSES AND INSURANCE. **D. BASIS FOR BIDS.** EQUIPMENT SPECIFIED SHALL BE ADHERED TO. HOWEVER, OWNER HAS FINAL DECISION ON THE TYPE AND QUALITY OF EQUIPMENT TO BE SUPPLIED.

WITHIN 30-DAYS AFTER THE CONTRACT HAS BEEN EXECUTED, A FORMAL REQUEST FOR THE SUBSTITUTION OF PRODUCTS IN PLACE OF THOSE SPECIFIED WILL BE CONSIDERED, UNDER THE FOLLOWING CONDITIONS: THE REQUEST IS ACCOMPANIED BY COMPLETE DATA ON THE PROPOSED SUBSTITUTION SUBSTANTIATING COMPLIANCE WITH THE CONTRACT DOCUMENTS INCLUDING PRODUCT IDENTIFICATION AND DESCRIPTION, PERFORMANCE AND TEST DATA, REFERENCES AND

SAMPLES WHERE APPLICABLE, AND AN ITEMIZED COMPARISON OF THE PROPOSED SUBSTITUTION WITH THE PRODUCTS SPECIFIED, WITH DATA RELATING TO CONTRACT TIME SCHEDULE, DESIGN AND AESTHETIC EFFECT WHERE APPLICABLE. THE REQUEST IS ACCOMPANIED BY ACCURATE COST DATA ON THE PROPOSED SUBSTITUTION IN COMPARISON WITH THE PRODUCT SPECIFIED, WHETHER OR NOT MODIFICATION OF THE CONTRACT SUM IS TO BE A CONSIDERATION. IF REDESIGN BY THE ARCHITECT OR HIS CONSULTANTS IS REQUIRED TO ACCOMMODATE AN ALTERNATE PRODUCT OR SYSTEM, ALL COSTS OF THIS REDESIGN SHALL BE BORNE BY THE CONTRACTOR REQUESTING THE CHANGE. IF ADDITIONAL WORK IS REQUIRED BY OTHER CONTRACTORS TO ACCOMMODATE AN ALTERNATE PRODUCT OR SYSTEM, ALL ADDITIONAL COSTS OF THIS WORK SHALL BE BORNE BY THE CONTRACTOR REQUESTING THE CHANGE.

REQUESTING THE CHANGE. THE REQUEST SHALL BE ACCEPTED OR REJECTED SOLELY AT THE DISCRETION OF THE OWNER WITH ARCHITECT'S OR ENGINEER'S WRITTEN APPROVAL. E. CODES & STANDARDS. THE WORK PERFORMED UNDER DIVISION 16 SHALL COMPLY WITH THE LATEST EDITION AND REQUIREMENTS OF THE FOLLOWING: THE LATEST EDITION AND REQUIREMENTS OF THE FOLLOWING: APPLICABLE LOCAL CODES AND ORDINANCES, NATIONAL ELECTRICAL CODE, AS AMENDED BY LOCAL CODE, ALL APPLICABLE FEDERAL AND STATE CODES, REGULATIONS AND STATUTES, APPLICABLE ENERGY CODE, OCCUPATIONAL SAFETY AND HEALTH ACT (OSHA), NATIONAL FIRE PROTECTION ASSOCIATION (NFPA), NATIONAL ELECTRICAL MANUFACTURERS ASSOCIATION (NEMA), UNDERWRITERS LABORATORIES, INC. (UL), AMERICAN NATIONAL STANDARDS INSTITUTE (ANSI), AMERICANS WITH DISAPLUTIES ACT (DA)

F. MATERIALS & EQUIPMENT. MATERIAL AND EQUIPMENT SHALL BE NEW, STANDARD, CURRENT PRODUCTS OF MANUFACTURERS REGULARLY ENGAGED IN THE PRODUCTION OF SUCH QUIPMENT, AND SHALL BE THE MANUFACTURER'S LATEST DESIGN LL MATERIALS SHALL BEAR THE LABEL OF THE UNDERWRITERS LABORATORY FOR THE INTENDED USE OR SHALL BE MATERIALS APPROVED BY THE CODE ENFORCING AUTHORITIES AND THE ARCHITECT. FOLLOW THE INSTALLATION DIRECTIONS AND RECOMMENDATIONS OF MATERIAL AND EQUIPMENT MANUFACTURERS.

DISABÌLITIÉS ACT (ADA).

ALL WORK SHALL BE PERFORMED BY WORKERS SKILLED IN THEIR RESPECTIVE TRADES AND ALL MATERIALS AND EQUIPMENT SHALL BE INSTALLED IN ACCORDANCE WITH MANUFACTURER'S RECOMMENDATIONS. ALL WORK SHALL BE EXECUTED IN A NEAT AND WORKMANLIKE MANNER. ISTALL FOUIPMENT INCLUDING SWITCHES CONTROLLERS FIXTURES AND TRANSFORMERS UCH THAT REMOVAL OR REPLACEMENT MAY BE READILY ACCOMPLISHED WITHOUT DAMAGE TO EQUIPMENT OR FASTENERS. IDENTIFY ALL EQUIPMENT, INCLUDING SAFETY SWITCHES, STARTERS, TRANSFORMERS, PANELS, TERMINAL BOXES, MOTORS, SPECIAL OUTLETS, RELAYS. IDENTIFICATION SHALL CORRESPOND TO THE TERMINOLOGY ON THE CONTRACT DOCUMENTS.

SUPPORTING DEVICES. DEVICES, INCLUDING ANCHORS, FASTENERS, HANGERS AND SUPPORTS, SHALL BE OF A TYPE DESIGNED OR FABRICATED FOR THE PURPOSE, AND SHALL ADEQUATELY AND SAFELY SECURE THE MATERIAL AND EQUIPMENT AND PRESENT A NEAT APPEARANCE. USE DEVICES WITH CORROSION RESISTANT CHARACTERISTICS FOR THE ATMOSPHERIC CONDITIONS IN WHICH THEY ARE INSTALLED.

H. RACEWAYS & BOXES. ROUTING OF RACEWAYS, INTERCONNECTING OUTLETS AND HOME-RUNS IS UP TO THE ELECTRICAL CONTRACTOR, BUT AFTER COMPLETION OF THE INSTALLATION, HE SHALL SUBMIT TO THE ENGINEER AS-BUILT DRAWINGS OF HIS WORK FOR FUTURE RECORD. DEVICE BOXES SHALL BE INSTALLED FLUSH, CONDUIT SHALL BE CONCEALED UNLESS OTHERWISE INDICATED. ALL CONDUCTORS SHALL BE IN CONDUIT. FOR UNDERGROUND/IN-SLAB LOCATIONS USE GALVANIZED RIGID STEEL (GRS) CONDUIT OR SCHEDULE 40 PVC CONDUIT WITH GROUND WIRE SIZED AS INDICATED OR REQUIRED BY N.E.C., STUB-UPS FROM UNDERGROUND/IN-SLAB PVC CONDUIT SHALL BE GRS. UNDERGROUND GRS SHALL BE COATED WITH TWO COATS OF BITUMASTIC #50 APPLIED WITHOUT THINNING. ALL SECTIONS OF METALLIC. CONDULT SYSTEM SHALL BE GROUNDED AND FLECTRICALLY SHALL BE COATED WITH TWO COATS OF BITOMASTIC #50 APPLIED WITHOUT THINNING. ALL SECTIONS OF METALLIC CONDUIT SYSTEM SHALL BE GROUNDED AND ELECTRICALLY CONTINUOUS. USE ELECTRICAL METALLIC TUBING (EMT) FOR INTERIOR CONCEALED WIRING AND ELSEWHERE AS PERMITTED BY THE N.E.C. USE SEALTITE FLEXIBLE METAL CONDUIT FOR FLEXIBLE CONNECTIONS IN ALL WET LOCATIONS. INSTALL A NYLON PULL-CORD IN ALL EMPTY RACEWAYS FOR FUTURE USE. SIZE ALL GUTTERS AND PULL-BOXES PER NEC 370 AND 374. ALL PULL AND JUNCTION BOXES SHALL REMAIN ACCESSIBLE AT ALL TIMES.

ALUMINUM CONDUIT WILL NOT BE PERMITTED. MINIMUM SIZE OUTLET BOX SHALL BE 4" SQUARE BY 1-1/2" DEEP UNLESS APPROVED OR INDICATED OTHERWISE. USE CAST METAL OUTLET BOXES WITH GASKETED COVERS FOR ALL EXTERIOR AND FOR ALL DAMP LOCATIONS. PROVIDE APPROVED FIRE STOPPING MATERIALS AT ALL CHASES TO PREVENT DRAFTS, AT PENETRATIONS INTO RATED SPACES, AND OTHER LOCATIONS AS REQUIRED BY CODES.

PROVIDE CABLE SUPPORTS IN ACCORDANCE WITH NEC ARTICLE 300. PROVIDE EXPANSION FITTINGS IN CONDUIT RUNS CROSSING EXPANSION JOINTS IN THE

STRUCTURE

I. CONDUCTORS. UNLESS OTHERWISE INDICATED, ALL CONDUCTORS ARE #12 IN 1/2" CONDUIT. ALL CONDUCTORS SHALL BE COPPER. ACCEPTABLE INSULATION TYPES ARE TW, THW, THHN, THWN, AND XHHW, WITH USES AS RESTRICTED BY THE NEC. AMPACITIES OF CONDUCTORS IS TO BE BASED ON ARTICLE 310 OF THE NEC WITH UL LIMITATIONS: 60 DEG. RATING FOR SIZES #14 THROUGH #1; 75 DEG. FOR #1/0 AND LARGER. CABLES 3/0 AND LARGER SHALL BE TERMINATED WITH DEFESTIVE CONNECTORS SHALL BE TERMINATED WITH PRESSURE CRIMP CONNECTORS. FOR 20 AMP BRANCH CIRCUITS GREATER THAN 100 FT. IN LENGTH, ONE WAY, UP TO 200 FT.

USE #10 WIRE; OVER 200 FT., USE #8 WIRE. INCREASE CONDUIT SIZE AS REQUIRED FOR THE LARGER CONDUCTORS. THIS SUPERSEDES WIRE SIZES CALLED FOR ON THE DRAWINGS. CONDUCTORS SIZE #10 AND SMALLER SHALL HAVE INSULATION COLORED FOR PHASES A, B, C, AND N RESPECTIVELY AS FOLLOWS FOR 3 PHASE SYSTEM:

120/240 VOLTS: BLACK, RED, BLUE AND WHITE


ALL CONDUCTORS OF THE SAME PHASE IN PARALLELED FEEDERS OR SERVICES SHALL BE SOLIDLY CONNECTED TOGETHER AT THEIR TERMINATION IN A WIREWAY OR SPLICE BOX. MAKE CONDUCTOR LENGTH FOR PARALLEL FEEDERS IDENTICAL. THE PHASE DESIGNATION OF ALL SECONDARY CONDUCTORS SHALL BE THE SAME AND SHALL BE INDICATED IN OR ON ALL 3 PHASE OUTLETS, TRANSFORMERS, PANELBOARDS, AND DISCONNECT SWITCHES, AND THEY SHALL BE CONNECTED WITH UNIFORM PHASE SEQUENCE. MAINTAIN A, B, C PHASE RELATION LEFT TO RIGHT WHEN VIEWED FROM THE FRONT. TAG ALL FEEDER CONDUCTORS AND IDENTIFY MAJOR CONDUITS IN OR AT WIREWAYS, PANELS, PULL BOXES, SWITCHBOARDS, MOTOR CONTROLLERS, CABINETS AND SIMILAR ITEMS TO ASSIST IN FUTURE CIRCUIT TRACING. CONDUCTOR TAGS SHALL BE NONCONDUCTIVE. IDENTIFICATION SHALL CORRESPOND TO THE CONTRACT DOCUMENTS.

COMMUNICATIONS, DATA, AND/OR WIRING WHICH IS NOT INSTALLED IN CONDUIT, AND WHICH IS ROUTED THROUGH ENVIRONMENTAL AIR SPACES, SHALL COMPLY WITH THE REQUIREMENTS OF NEC 300-22. PROVIDE TRAPEZE HANGER ASSEMBLY FOR PLENUM CABLES USING 3/8" DIAMETER HANGER ROD AND CHANNEL ASSEMBLY TO SUPPORT CABLE BUNDLES EVERY 4 FEET. ALL BUNDLES SHALL BE PROPERLY STRAPPED WITH SELF-LOCKING CABLE TIES. EXPOSED CABLES SHALL NOT LIE ON TOP OF CEILING TILES OR LUMINARIES.

J. GROUNDING.

AREA.

			LIGHTING FIXTURE SC	CHEDU	JLE				
ТҮРЕ	DESCRIPTION	MANUFACTURER	CATALOG NUMBER	QTY	LAMP	COLOR	VOLTS	MOUNTING	REMARKS
А	HALLWAY FIXTURES		FM22 ACLR LP	1	22WT9	3500	120	SURFACE	ENERGY STAR
В	RESTROOM FIXTURE	LITHONIA	FMLL7 8 30 WL			3000	120	FLUSH	ENERGY STAR
С	KITCHEN FIXTURE	LITHONIA	3348 2L32		F32T8	3500	120	SURFACE	ENERGY STAR
D	VANITY FIXTURE	LITHONIA	MWVB2 BZ DCNE1001			3000	120	SURFACE	ENERGY STAR
Е	EXTERIOR ENTRY FIXTURE	WAVE	217-WT	1	13W PL	2700	120	SURFACE	WET LOCATION
F	EXTERIOR SPOT LIGHTS	LITHONIA	OFTR 200Q 120 LP	2	100WQTZ	2700	120	SURFACE	WET LOCATION

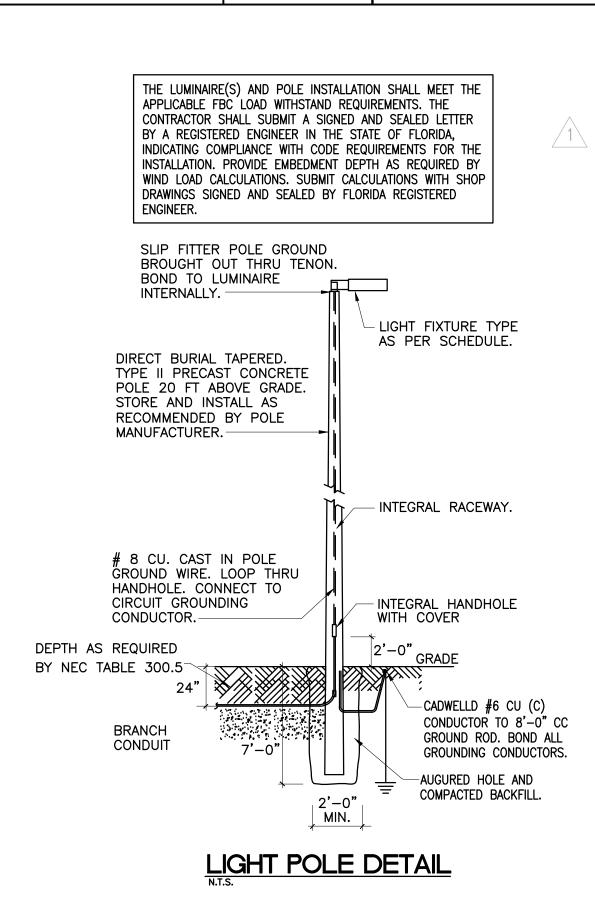



GENERAL ELECTRICAL NOTES

END-TO-END LIGHTING FIXTURES SHALL BE CONTINUOUSLY BONDED. GROUNDING CONTACTS OF RECEPTACLES SHALL BE CONNECTED TO A SOLIDLY GROUNDED CONDUIT SYSTEM OR TO A SYSTEM GROUNDING CONDUCTOR (NOT THE SYSTEM NEUTRAL) BY A STRANDED COPPER WIRE NOT SMALLER THAN #12 AWG OR SHALL BE GROUNDED IN SOME OTHER APPROVED MANNER; THE RESISTANCE BETWEEN THE CONTACTS AND SERVICE GROUND SHALL NOT EXCEED 3 OHMS. ALL CIRCUITS SHALL HAVE AN EQUIPMENT GROUNDING CONDUCTOR.

K. SAFETY SWITCHES/CIRCUIT BREAKER DISCONNECTS. SHALL BE HEAVY DUTY TYPE KD, FUSIBLE, OR NON-FUSIBLE, WITH POLES, AMPERE, VOLTAGE AND HORSEPOWER RATINGS INDICATED AND SHALL HAVE SOLID NEUTRALS. LUGS SHALL BE U.L. LISTED FOR COPPER-ALUMINUM.

ENCLOSURES FOR SAFETY SWITCHES SHALL BE NEMA-1, GENERAL PURPOSE, EXCEPT THAT SWITCHES INDICATED (WP) WEATHERPROOF, SHALL BE NEMA-3R ENCLOSURES WITH SUITABLE GASKETS AND BONDING MEANS.

SWITCHES AND DISCONNECT SHALL BE AS MANUFACTURED BY SQUARE "D", OR APPROVED CIRCUIT BREAKER DISCONNECTS MAY BE USED IN LIEU OF SAFETY SWITCHES PROVIDING THEY COMPLY WITH THE SAFETY SWITCH REQUIREMENTS AND ARE SUPPLIED WITHIN THEIR RATINGS AND A SCHEDULE IS SUBMITTED FOR APPROVAL.

L. MOLDED CASE CIRCUIT BREAKERS. CIRCUIT BREAKERS SHALL CONFORM TO APPLICABLE FEDERAL SPECIFICATIONS AND NEMA STANDARDS. CIRCUIT BREAKERS SHALL BE OF THE AMPERE RATING, VOLTAGE RATING, NUMBER OF POLES AND CLASS OR INTERRUPTING CAPACITY (I.C.) AS INDICATED. INTERRUPTING RATINGS ARE GIVEN IN ROOT MEAN SQUARE (RMS), SYMMETRICAL AMPERES BASED ON NEMA TEST PROCEDURES. LUGS AND TERMINALS SHALL BE U.L. APPROVED FOR COPPER-ALUMINUM. ACCESSORIES SHALL BE 120 VOLT.

A.I.C. OF BREAKER TO BE INSTALLED ON EXIST. PANELS SHALL MATCH EXIST. EACH CIRCUIT BREAKER SHALL HAVE A TRIP UNIT FOR EACH POLE WITH ELEMENTS PROVIDING INVERSE TIME DELAY UNDER OVERLOAD CONDITIONS AND INSTANTANEOUS MAGNETIC TRIP FOR SHORT CIRCUIT PROTECTION UNLESS INDICATED AS NON-AUTOMATIC. TRIP ELEMENTS SHALL OPERATE A COMMON TRIP BAR TO OPEN ALL ELEMENTS. BREAKERS USED FOR SWITCHING SHALL BE RATED FOR SWITCHING DUTY.

M. FUSES. FUSES SHALL CONFORM TO NEMA AND U.L. AND SHALL BE OF THE VOLTAGE, CLASS AND AMPERE RATING INDICATED. FUSES FOR MAIN DISCONNECT DEVICES SHALL BE HIGH INTERRUPTING CAPACITY, TIME DELAY, OR TYPE SUITABLE FOR DEVICE. PROVIDE ONE SPARE SET MOUNTED INSIDE THE CUBICLE, FOR EACH MAIN DEVICE.

FUSES FOR MOTORS AND ENCLOSED SWITCHES, NEMA CLASS K-5, UNLESS INDICATED OTHERWISE, DUAL ELEMENT, TIME DELAY. BUSSMAN - FUSETRON, FRN AND FRS, OR EQUAL. OTHER FUSES SHALL BE AS INDICATED.

N. WIRING DEVICES. DEVICES SHALL BE AS SPECIFIED IN CONTRACT DOCUMENTS. INSTALL PLATES AND COVERS ON ALL OUTLETS. INSTALL ALL DEVICES UNIFORMLY IN EACH PLATES SHALL BE ALIGNED VERTICALLY AND HORIZONTALLY AND ALL EDGES SHALL BE IN FIRM CONTACT WITH SURROUNDING WALL FINISH.

MOUNTING HEIGHTS (TO CENTER LINE OF BOX): GENERALLY MOUNT RECEPTACLES 18" AFF (ABOVE FINISHED FLOOR) UNLESS NOTED THERWISE.

MOUNT SWITCHES AND DIMMERS AT 48" AFF. MOUNT OUTLETS OVER MIRRORS 8" HIGHER THAN MIRROR. MOUNT OUTLETS OVER COUNTERS AND CENTERED IN THE BACK SPLASH WHERE IT OCCURS; RECEPTACLE SHALL BE HORIZONTAL.

ADJUST OUTLET HEIGHTS IN CERAMIC TILE WALLS TO BE ENTIRELY IN OR ENTIRELY OUT OF THE TILE. OUTLETS MAY BE HORIZONTAL TO MEET SPACE CONDITIONS. TEST EACH SOCKET OF EACH OUTLET WITH A DEVICE INTENDED FOR THE PURPOSE.

RESIDENCE NOTES:

- . COOLING AND HEATING LOADS ARE NOT CONCURRENT.
- 2. PROVIDE ALL FINAL CONNECTIONS TO ALL EQUIPMENT AND APPLIANCES. 3. PROVIDE ALL A/C CONTROL IN SEPARATE 1/2"C AS REQUIRED BY A/C DRAWINGS OR MANUFACTURER DIAGRAMS.
- 4. ALL LAVATORIES AND KITCHEN RECEPTACLES SHALL BE GFI TYPE.
- 5. EXTERIOR RECEPTACLES TO BE GFI AND WEATHER PROOF.
- 6. COORDINATE LOCATION OF ALL DISCONNECT SWITCHES WITH OTHER TRADES TO ALLOW N.E.C. REQUIREMENT CLEARANCE.
- CIRCUITS WIRING REQUIRED TO BE AS FOLLOWS: 120V-2 WIRE (L-N); 120/240V 3 WIRE (LL-N); 240V - 2 WIRE (LL). WHEN EQUIPMENT GROUND IS REQUIRED INCREASE CONDUIT SIZE AS REQUIRED.
- 8. ALL WIRING TO BE COPPER. THHN/THWN TYPE RUN IN CONDUIT.
- 9. ALL COUNTER RECEPTACLES AND SWITCHES TO BE MOUNTED + 48" MAXIMUM FINISHED FLOOR (TO BOTTOM OF PLATE). UNLESS OTHERWISE NOTED COORDINATE HEIGHT WITH ARCHITECT. 10. REFRIGERATOR RECEPTACLE TO BE MOUNTED + 48" A.F.F.
- 11. COORDINATE LOCATION OF AIR CONDITIONER (INDOOR UNIT) DISCONNECT SWITCH WITH A/C
- CONTRACTOR TO KEEP N.E.C. REQUIRED CLEARANCE.
- 12. MINIMUM WIRE SIZE SHALL BE #12 THHN/THWN . 13. CONDUCTORS #6 AWG AND LARGER SHALL BE THW.
- 14. ALL CONDUCTORS SHALL BE COPPER.
- 15. CONDUIT IN FINISHED AREAS SHALL BE CONCEALED.
- 16. CONDUIT IN UNFINISHED AREAS SHALL BE EXPOSED.
- 17. FUSES SHALL BE DUAL ELEMENT, TIME DELAY TYPE.
- 18. INSTALL NYLON PULL STRING IN ALL EMPTY CONDUITS FOR FUTURE USE.
- 19. ALL MATERIALS SHALL BE U.L. APPROVED.
- 20. WORKMANSHIP SHALL BE TO BEST COMMERCIAL PRACTICE.
- 21. INSTALLATION SHALL BE IN ACCORDANCE WITH LOCAL, STATE AND NATIONAL CODES.
- 22. RECESSED LIGHT FIXTURES OVER BATHTUB OR SHOWER SHALL BE COMPLETELY ENCLOSED AND VAPOR PROOF SUITABLE FOR WET LOCATIONS.
- 23. ALL LUMINARIES SHALL BE PROPERLY SUPPORTED IN ACCORDANCE WITH THE CEILING SYSTEM MANUFACTURER RECOMMENDATIONS AND LOCAL CODE REQUIREMENTS. 24. RISER AND DIAGRAMMATIC ONLY. THEY DO NOT SHOW EVERY BEND REQUIRED FOR THE
- INSTALLATION.
- 25. THIS DRAWING IS A GUIDE FOR THE INSTALLATION OF ELECTRICAL SERVICE. THE ELECTRICAL CONTRACTOR IS RESPONSIBLE TO PROVIDE A FUNCTIONING SYSTEM.
- 26. A/C EQUIPMENT WIRING. BREAKER AND FUSE SIZES ARE BASED ON A/C EQUIPMENT SPECIFIED ON CONTRACT DRAWINGS. CONTRACTOR IS RESPONSIBLE FOR PROVIDING ALL WIRING, BREAKER AND FUSES SIZES IN ACCORDANCE WITH A/C EQUIPMENT NAMEPLATE REQUIREMENTS IF DIFFERENT FROM THAT SPECIFIED ON DRAWINGS. AS WELL AS ANY FEEDER CHANGES BEING AFFECTED BY THIS CHANGE. CONTRACTOR SHALL MAKE ABOVE MENTIONED CHANGES AT NO EXTRA COST.
- 27. CONTRACTOR SHALL COORDINATE ALL HIS WORK WITH OTHER TRADES IN ORDER TO FURNISH AND INSTALL ALL CONTROL WIRING AND RACEWAYS ALL POWER CONTROL CIRCUITS WIRING AND RACEWAYS AS SHOWN ON THE AIR CONDITIONING DRAWINGS OR SPECIFICATIONS. IF AIR CONDITIONING DRAWINGS REFER TO MANUFACTURER'S WIRING DIAGRAMS. THE CONTRACTOR SHALL VERIFY WITH SAID MANUFACTURER ALL REQUIREMENTS AND INCLUDE ALL RELATED WORK IN HIS CONTRACT
- 28. SEE PANEL SCHEDULES FOR AFCI CIRCUIT REQUIREMENTS.
- 29. ALL RECEPTACLES SHALL BE TAMPER PROOF.
- SYMBOL LEGEND:
- DUPLEX RECEPTACLE OUTLET 15A, 125V, 3 WIRE MOUNTED @ 18" AFF SMALL APPLIANCE AND BATHROOM DUPLEX RECEPTACLES TO BE RATED FOR 20A, 125V, 3 WIRE, GROUND TYPE WALL MOUNTED TAMPER RESISTANT.
- SINGLE RECEPTACLE OUTLET, 20A, 125V, 3 WIRE, GROUNDING TYPE WALL MOUNTED TAMPER RESISTANT.
- WALL MOUNTED LIGHT FIXTURE
- O CEILING MOUNTED LIGHT FIXTURE (RECESSED) -O- PENDANT LIGHT FIXTURE





- ◀ TELEPHONE OUTLET MOUNTED AT 18" AFF
- SINGLE POLE SWITCH, 120V, 20A
- THREE-WAY SWITCH, 120V, 20A.
- SPECIAL PURPOSE OUTLET TO MATCH EQUIPMENT PLUG, 120/240V, 1ø, GROUNDING TYPE
- □ FUSED OR NON FUSED DISCONNECT SWITCH. FUSES AS PER EQUIPMENT MANUFACTURER.
- SMOKE DETECTOR (120V) TANDEM WIRED WITH SOUNDING BASE
- (J) JUNCTION BOX
- WP WEATHER PROOF GFI GROUND FAULT INTERRUPTER


48 HOURS BEFORE DIGGING CALL 811 OR 800-432-4770 UNDERGROUND UTILITIES NOTIFICATION CENTER

A MINIMUM OF 50% OF THE LAMPS IN PERMANENTLY INSTALLED LIGHTING FIXTURES SHALL BE HIGH-EFFICACY LAMPS AS PER ENERGY CODE (FBC) SECTION 404.1



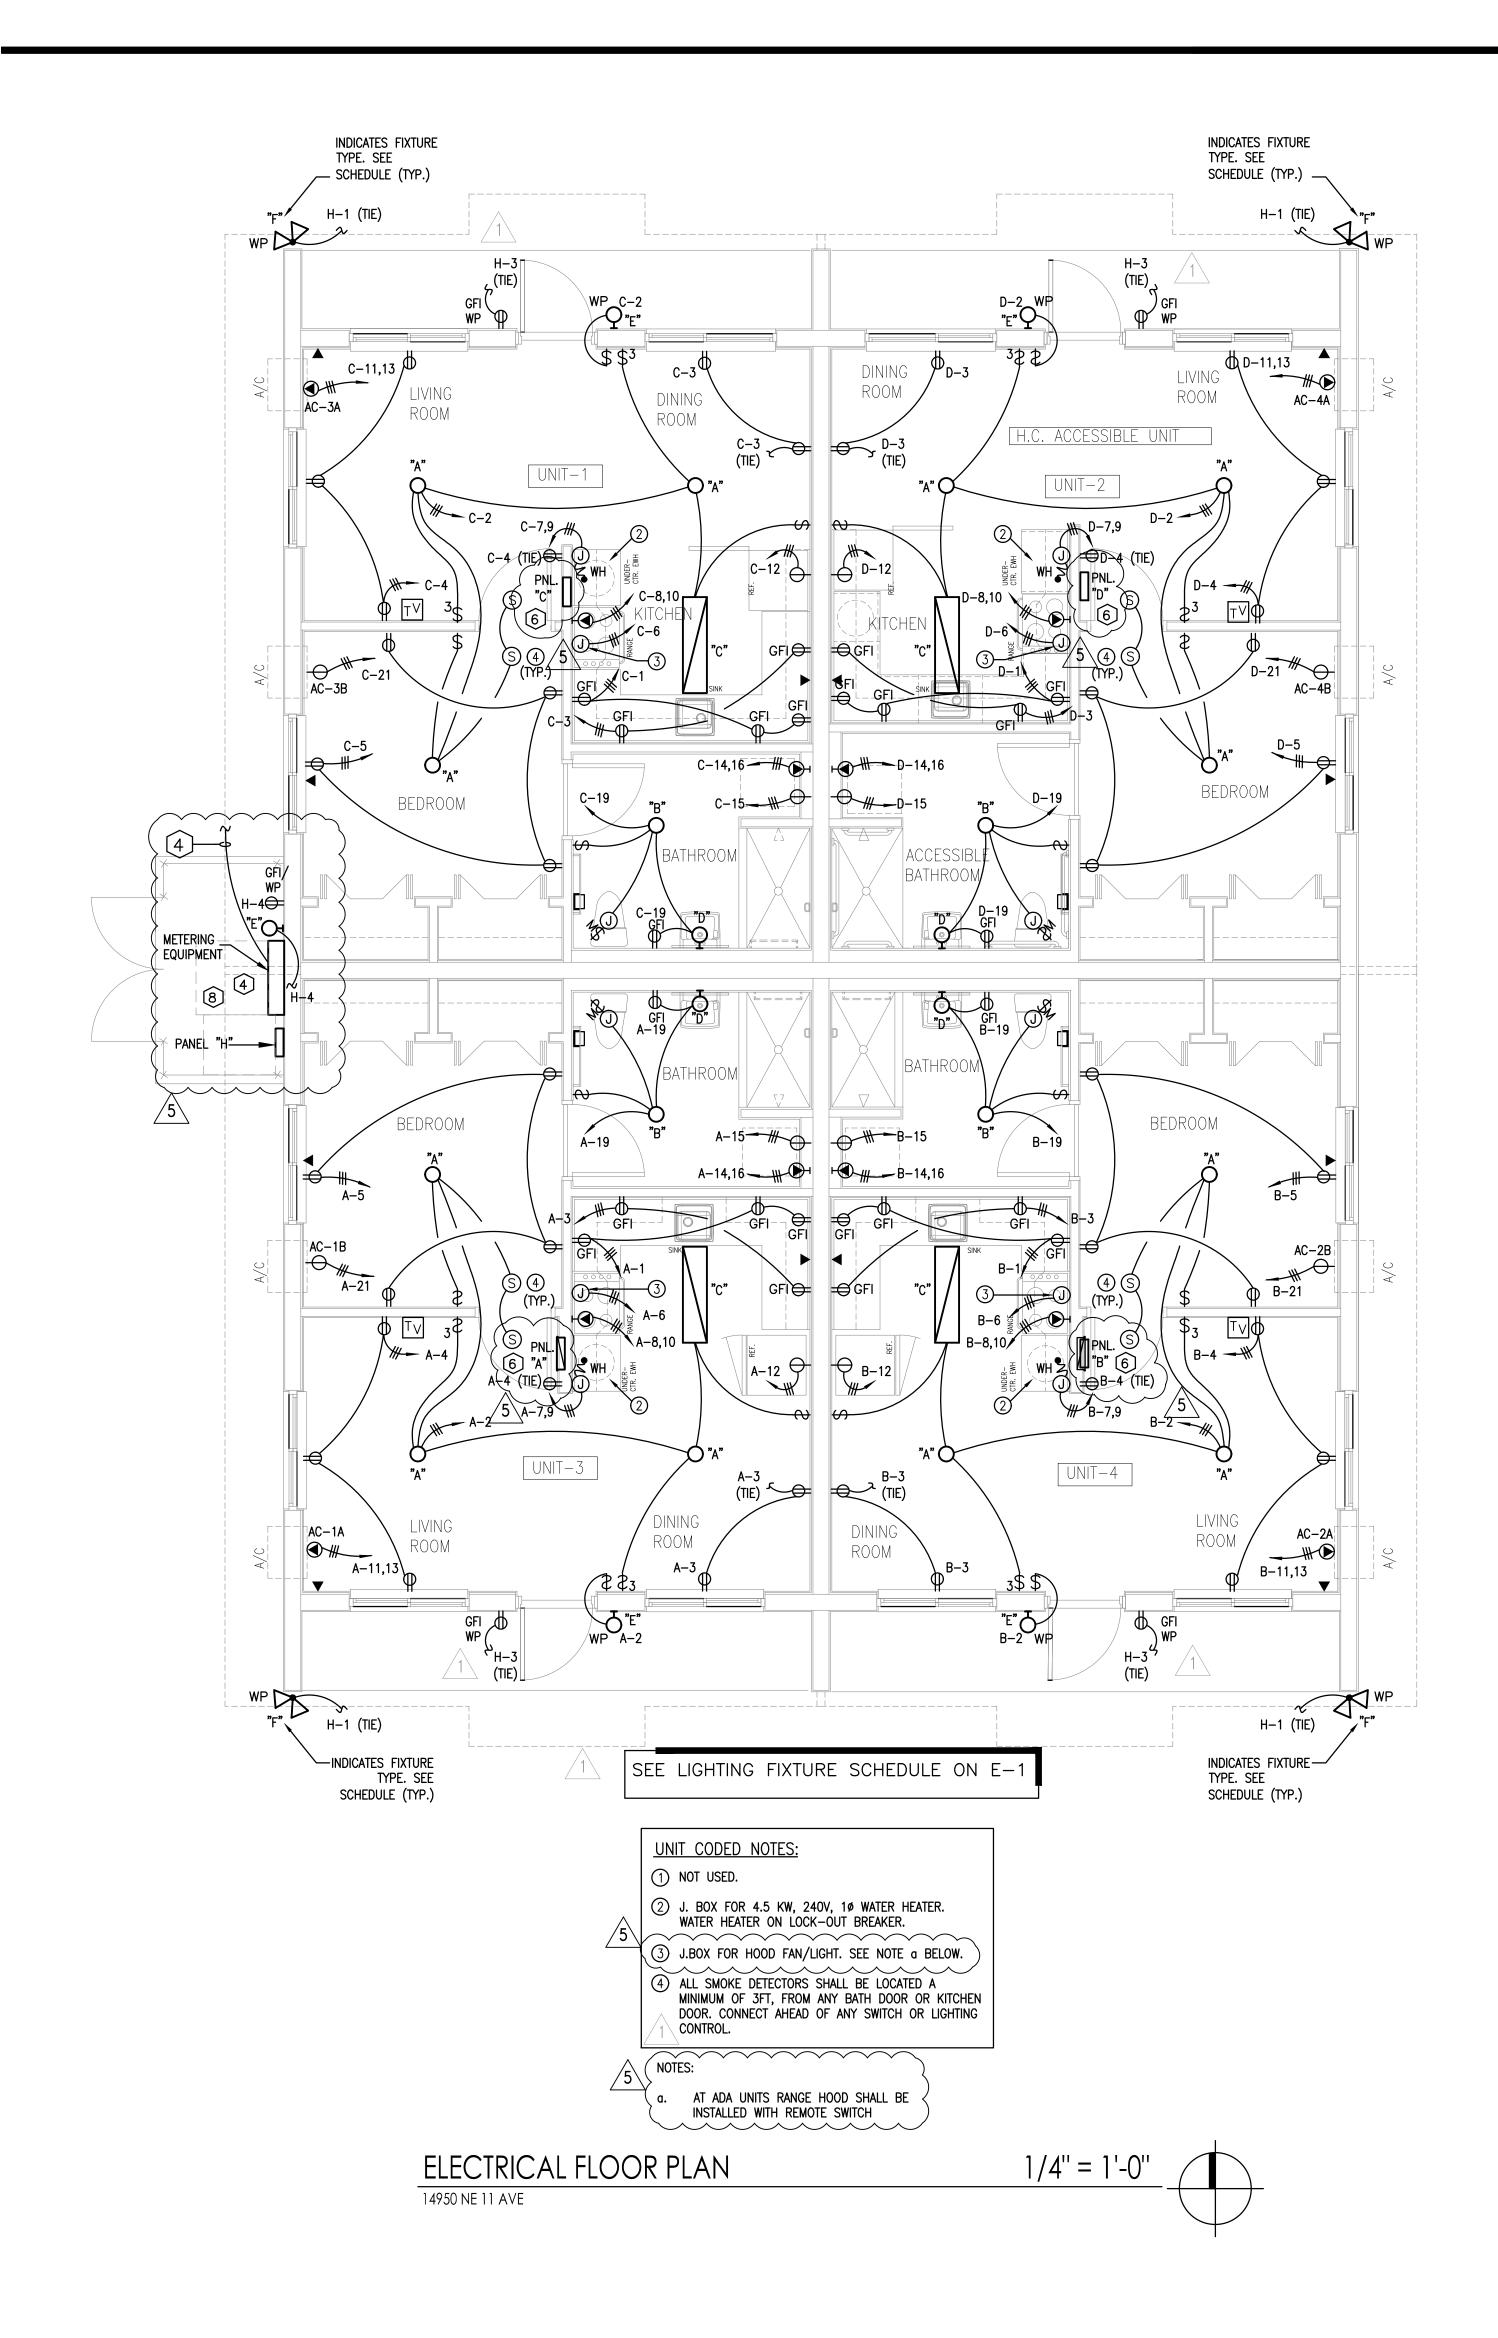

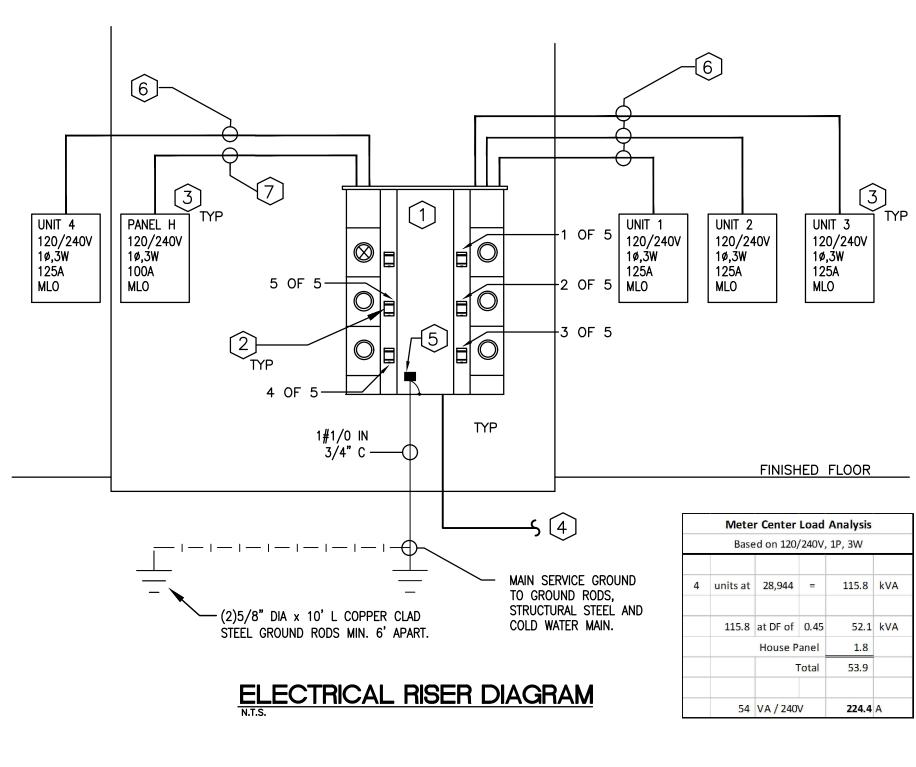

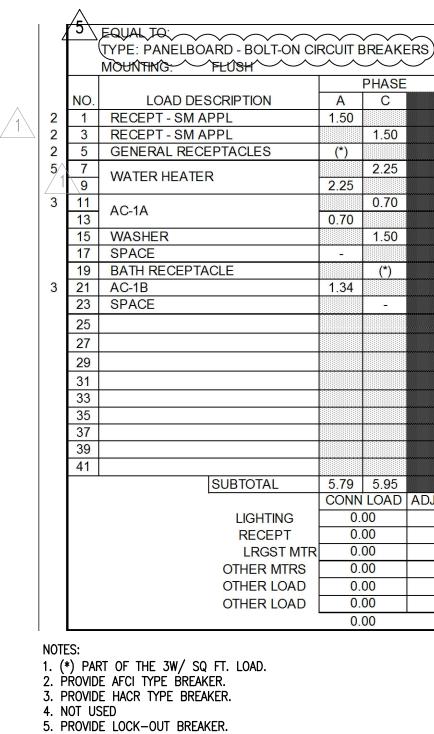

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\sim	NO.	LOAD DESCRIPTION	Α	С		BKR	Р	I
¹ (1,2	λ 1	FLOOD LIGHTS	0.80			20	1	ĺ
\sim	/3	RECEPTACLES		0.40		20	1	
	5							
	7							
	9							
	11							
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-			0.0	0.4				l
		SUBTOTAL	0.8	0.4 LOAD	ADIE	ACTOR	DMD	ſ
		LIGHTING		36		25	1.	
		RECEPT		40			N	
		LRGST MTR		00	1	25	1.	
		OTHER MTRS		00		00	1.	
		OTHER LOAD		00		25	1.	
		OTHER LOAD		00		00	1.	
		O HIER EORD	-	76				
L	DTES:			. •				

<u>/5</u>`

Meter Center Load Analysis								
	Base	ed on 120,	/240V,	1P, 3W				
4	units at	28,944	=	115.8	kVA			
	115.8	at DF of	0.45	52.1	kVA			
		House P	anel	1.8				
		1	Fotal	53.9				
	54	VA / 240	V	224.4	A			

RISER KEY NOTES

- (1) CONTRACTOR SHALL PROVIDE AND INSTALL FPL SERVICE AND METERING EQUIPMENT SQUARE "D" EZ METER CENTER WITH A 400 A TAP BOX & (5) 125 A METERS WITH MAINS. RING OR RINGLESS TYPE DEVICE AS REQUIRED BY FPL. COORDINATE FPL SERVICE LOCATION WITH FPL PRIOR TO INSTALLATION.
- CONTRACTOR SHALL PROVIDE AND INSTALL (4) 2P-110 AMPS SERVICE RATED 22K AIC MAINS FOR UNITS & (1) 2P-60 2 AMPS SERVICE RATED 22K AIC MAIN FOR HOUSE PANEL "H" LOAD.

(3) CONTRACTOR SHALL PROVIDE AND INSTALL (4) 120/240V, 1 PH, 125 AMPS, NEMA 1 FLUSH ENCLOSURE PANELBOARDS FOR UNITS 1,2,3,4 & (1) 120/240V, 1 PH, 125 AMPS, NEMA 3R SURFACE ENCLOSURE PANELBOARD "H" FOR HOUSE LOAD, BRANCH BREAKERS AS INDICATED. SEE PANEL SCHEDULE AND RISER DIAGRAM FOR DETAILS. MAKE ALL CONNECTIONS FOR A COMPLETE WORKING SYSTEM IN PLACE.

- 4 CONTRACTOR SHALL PROVIDE AND INSTALL 3# 250kcmil IN 2 1/2" C, COMPLETE IN PLACE FROM METER EQUIPMENT TO FPL POINT OF CONNECTION. COORDINATE WITH FPL REPRESENTATIVE FOR EXACT LOCATION OF ELECTRICAL SERVICE, POINT OF CONNECTION AND METERING EQUIPMENT. ASSUME 250LF SERVICE FEEDER FOR PRICING. CONDUITS ROUTE AND TRENCH SHALL BE COORDINATED IN FIELD AND IN COMPLIANCE WITH FPL AND N.E.C. REQUIREMENTS. MAKE ALL NECESSARY CONNECTIONS, PROVIDE PULL BOXES, TRENCHING, RISERS, ETC. FOR A COMPLETE WORKING SYSTEM IN PLACE.
- 5 PROVIDE GROUNDING OF ALL METAL SUPPORTS AND EQUIPMENT ATTACHED BY A MECHANICAL LUG AND BOLTED TO EQUIPMENT AND CONNECTED TO GROUNDING SYSTEM AS PER RISER DIAGRAM. PROVIDE AN INTERSYSTEM GROUNDING PER NEC 250.94
- (6) CONTRACTOR SHALL PROVIDE AND INSTALL 3#1 & 1#6 (G) IN 1 1/2" C, COMPLETE IN PLACE. FEEDER CONDUCTORS SHALL BE ROUTED ALONG THRU THE INTERIOR OF THE BUILDING IN EMT CONDUITS.


- (7) CONTRACTOR SHALL PROVIDE AND INSTALL 3#6 & 1#8 (G) IN 1 1/4" C, COMPLETE IN PLACE.
- (8) PROVIDE MINIMUM 36" IN FRONT OF ELECTRICAL EQUIPMENT FOR N.E.C. WORKING CLEARANCES.

			PANEL		"A" 149	950						120/240V, 1P, 3W	
rs)				10,000	AIC					MAINS	AMPS:	125A	
	PANELS "B", "C", "D", SIMILAR						TYPE MAINS: M.L.O						
		CIR	CUIT		CIRCUIT					PHASE			
	BKR	Р	W	С	С	W	P	BKR		Α	С	LOAD DESCRIPTION	NO.
	20	1	12	1/2"	1/2"	12	1	20		(*)		GENERAL LIGHTS	2
	20	1	12	1/2"	1/2"	14	1	15			(*)	GENERAL LIGHTS	4
	15	1	12	1/2"	1/2"	14	1	15		0.20		HOOD FAN /LIGHT	6
	30	2	10	3/4"	3/4"	8	2	50		4.38	4.38	RANGE	8 10
		-			1/2"	12	1	20			1.40	REFRIGERATOR	12
	20	2	12	1/2"						2.60			14
	20	1	12	1/2"	3/4"	10	2	30		2.00	2.60	DRYER	16
	-	-	-	-	-	-	1	20		-		SPARE	18
	20	1	12	1/2"	-	-	1	20			-	SPARE	20
	20	1	12	1/2"	-	-	-	-		-		SPACE	22
	-	-	-	-	-	-	-	-			-	SPACE	24
													26
													28
													30
													32
													34
													36
													38
													40
													42
										7.175	8 38		
DJ F	DJ FACTOR DMD FO		DMD FCTR TOTAL					TOTAL			0.0		
	.25		00		00								
		NEC 0.0		00	\neg				TOTAL AMPS 0.0				
1.25		1.00 0.0		00	7				(SEE UNIT LOAD ANALYSIS)				
1.00		1.00 0.00		00	Lighting load 3W								
1.25		1.00 0.0		00	A/C			2.74					
1.00		1.00 0.00			00	Other Load 22.31							
				0.	00	ŀ							

	Unit Loa	ad Anal	ysis	
В	ased on 12	0/240V,	1P, 3W	
548	SF at 3 W/	SF	1,644	VA
Other loa	ds except A	24,560	VA	
	S	Subtotal	26,204	VA
	1st 10kVA	at100%	10,000	VA
	16,204	at 40%	6,482	VA
	A/C	at 100%	2,740	VA
		Total	19,222	VA
19,222	VA / 240V		80.1	Α

PANEL		"H" 149	950				VOLTA	GE:	120/240V, 1P, 3W					
10,000 AIC							MAINS AMPS: 100A							
							TYPE I	MAINS:	M.L.O					
CUIT				CUIT		000055000055000055000055	PHASE							
W	С	C	W	P	BKR		A	С	LOAD DESCRIPTION	NO.				
12	1/2"	3/4"	12	20	1		0.21		PARKING LIGHTS	2				
12	1/2"	1/2"	12	20	1			0.35	ELEC. RM.	4				
										6				
										8				
										10				
										12				
I			1	1	1		0.21	0.35	1.8	I				
FCTR	TO	TAL					TOTAL	kVA		2.1				
00		70												
EC	0.40			TOTAL AMPS 8.8										
00		00												
00		00												
00		00												
00		00	ļ											
	2.	10												



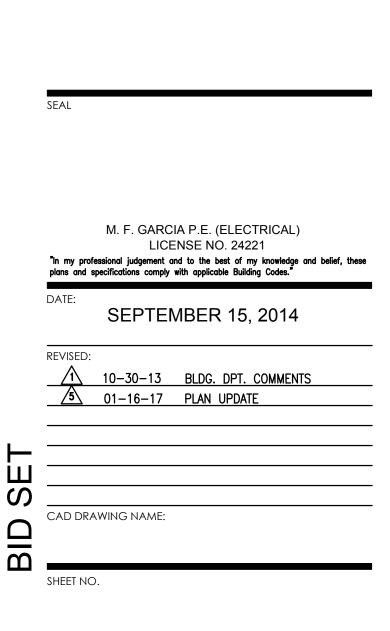

ELECTRICAL DEMOLITION & NEW WORK PLANS

DRAWING TITLE:

MIAMI, FL

CITY OF MIAMI LIFE QUEST RENOVATIONS 14950 NE 11TH AVENUE

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